CITY OF TAMPA



Bob Buckhorn, Mayor

CONTRACT ADMINISTRATION DEPARTMENT

David L. Vaughn, AIA, Director

ADDENDUM NO. 1

DATE: June 26, 2013

Contract 13-C-00033; Fire Station 19 Improvements

Bidders on the above referenced project are hereby notified that the following addendum is made to the Contract Documents. BIDS TO BE SUBMITTED SHALL CONFORM TO THIS NOTICE.

- Item 1: Permit and Utility Fee clarification: All fees are paid by the City.
- Item 2: Refrigerator Model Change: Bid basis is Kenmore 04641153000- Model #41153 (stainless steel)
- Item 3: Dryer Model Change: Bid basis is Kenmore 26-81372 White
- Item 4: Apparatus room ceiling height clarification: Ceiling is 18'-0" AFF.
- Item 5: Flag Pole height clarification: Flag Pole height is 35'-0".
- Item 6: Add plumbing sheet P-6.0
- Item 7: ARRA requirements Clarification: Delete all references. Contractor is encouraged to provide buy American products.
- Item 8: Dumpster Clarification: Replace Detail 2 on sheet C-1 with attached revised detail.
- Item 9: Sheet G-1, Index, Revise as follows: Delete sheet M-1.2 from Index.
- Item 10: Add the attached Electrical Sheet E-3.1.
- Item 11: Attached for your reference is the Pre-Bid meeting sign-in sheet.


All other provisions of the Contract Documents and Specifications not in conflict with this Addendum shall remain in full force and effect. Questions are to be e-mailed to Contract Administration@tampagov.net.

Jim Greiner

Jim Greiner, P.E., Contract Management Supervisor


306 E. Jackson Street, 4N • Tampa, Florida 33602 • (813) 274-8456 • FAX: (813) 274-8080




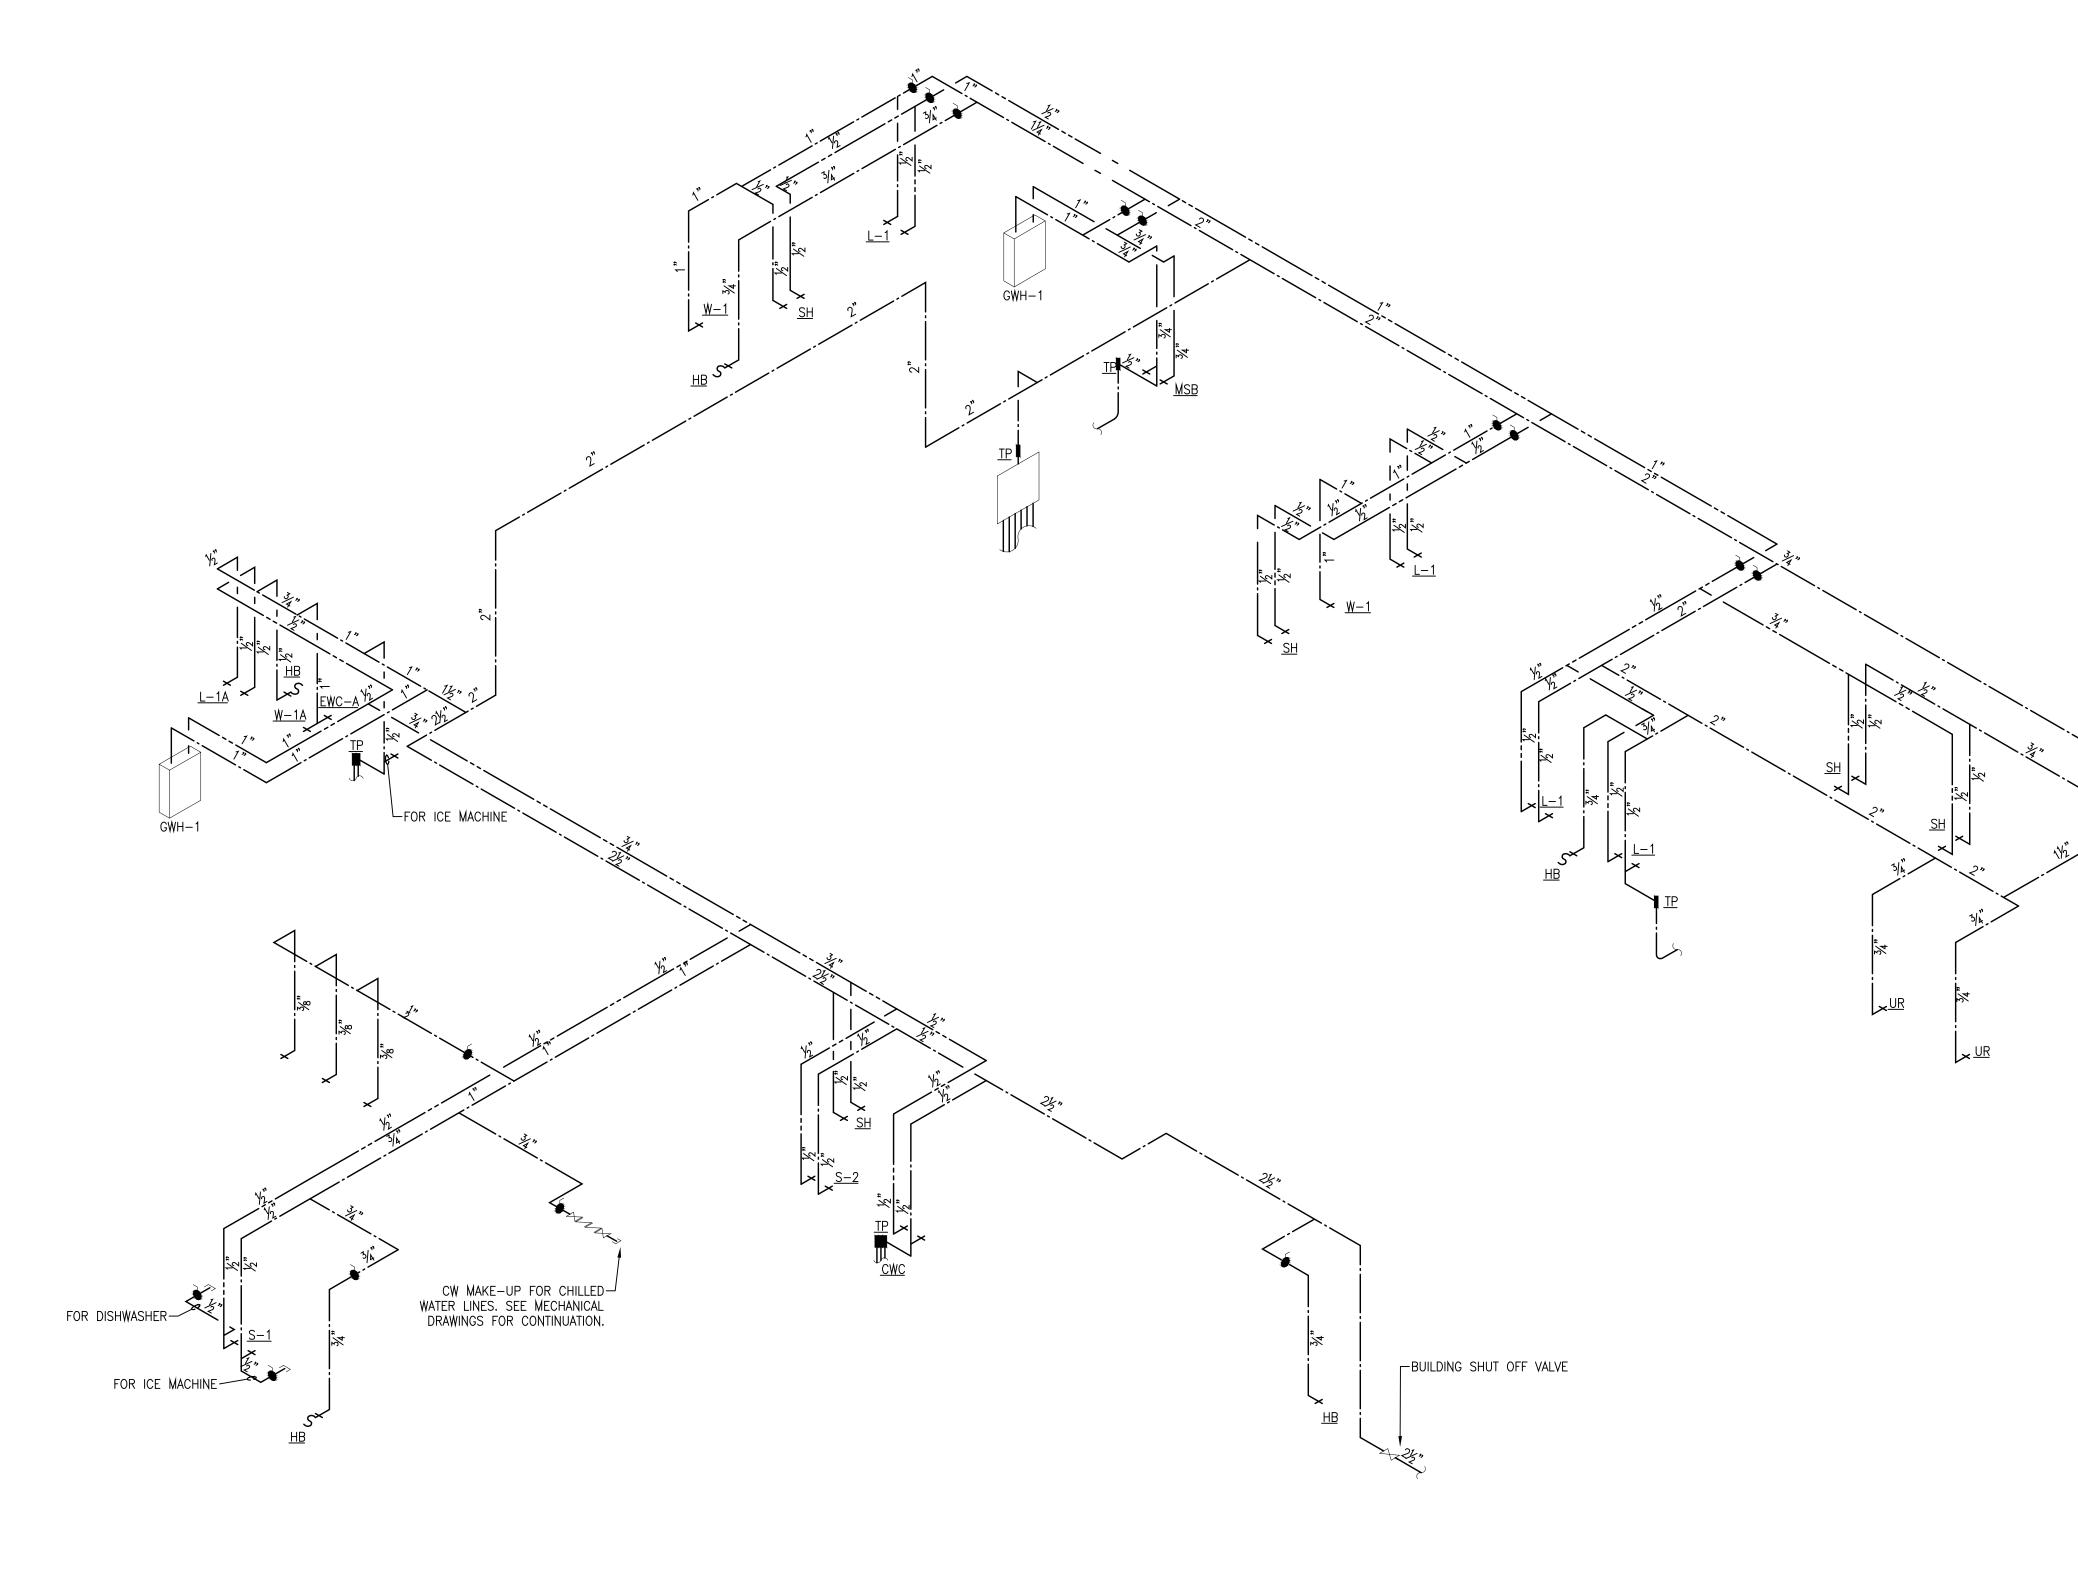

SUPPLY RISER scale: not to scale

			UNIT OF CONSULTANT
	3/4	34."	DAVID CONNER & ASSOCIATES 1509 W. SWANN AVENUE,SUITE 255 TAMPA, FL 33606
<u>W-1</u> <u>W-1</u>		کر ال ا	FIRE STATION 19 7910 INTERBAY BLVD. TAMPA, FL
<u>W = 1</u>			DPW FILE NUMBER DPW NUMBER FD0116 ISSUE DATE MAY 31, 2013 DRAWN BY
			SEAL
			SCALE: N.T.S. SUPPLY RISERS
	GRINER ENGINEERING, II 1628 First Avenue North St. Petersburg, Florida 33713 Phone: (727)-822-2335 Fax: (727)-821-3361 Certificate of Authorization #3173	DrawnADBDesignedADBEORJHG	SHEET NUMBER

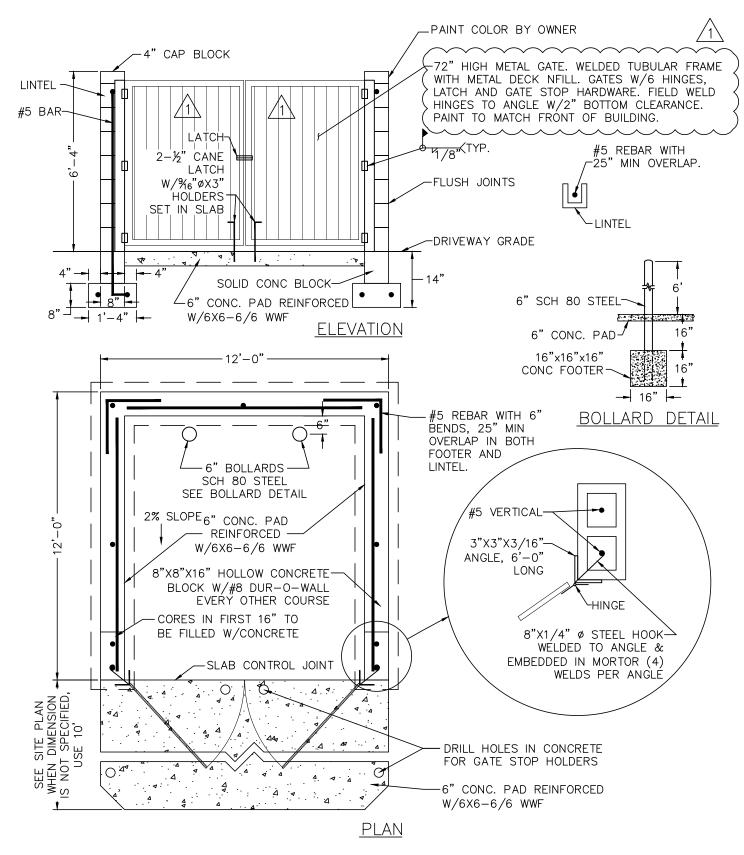

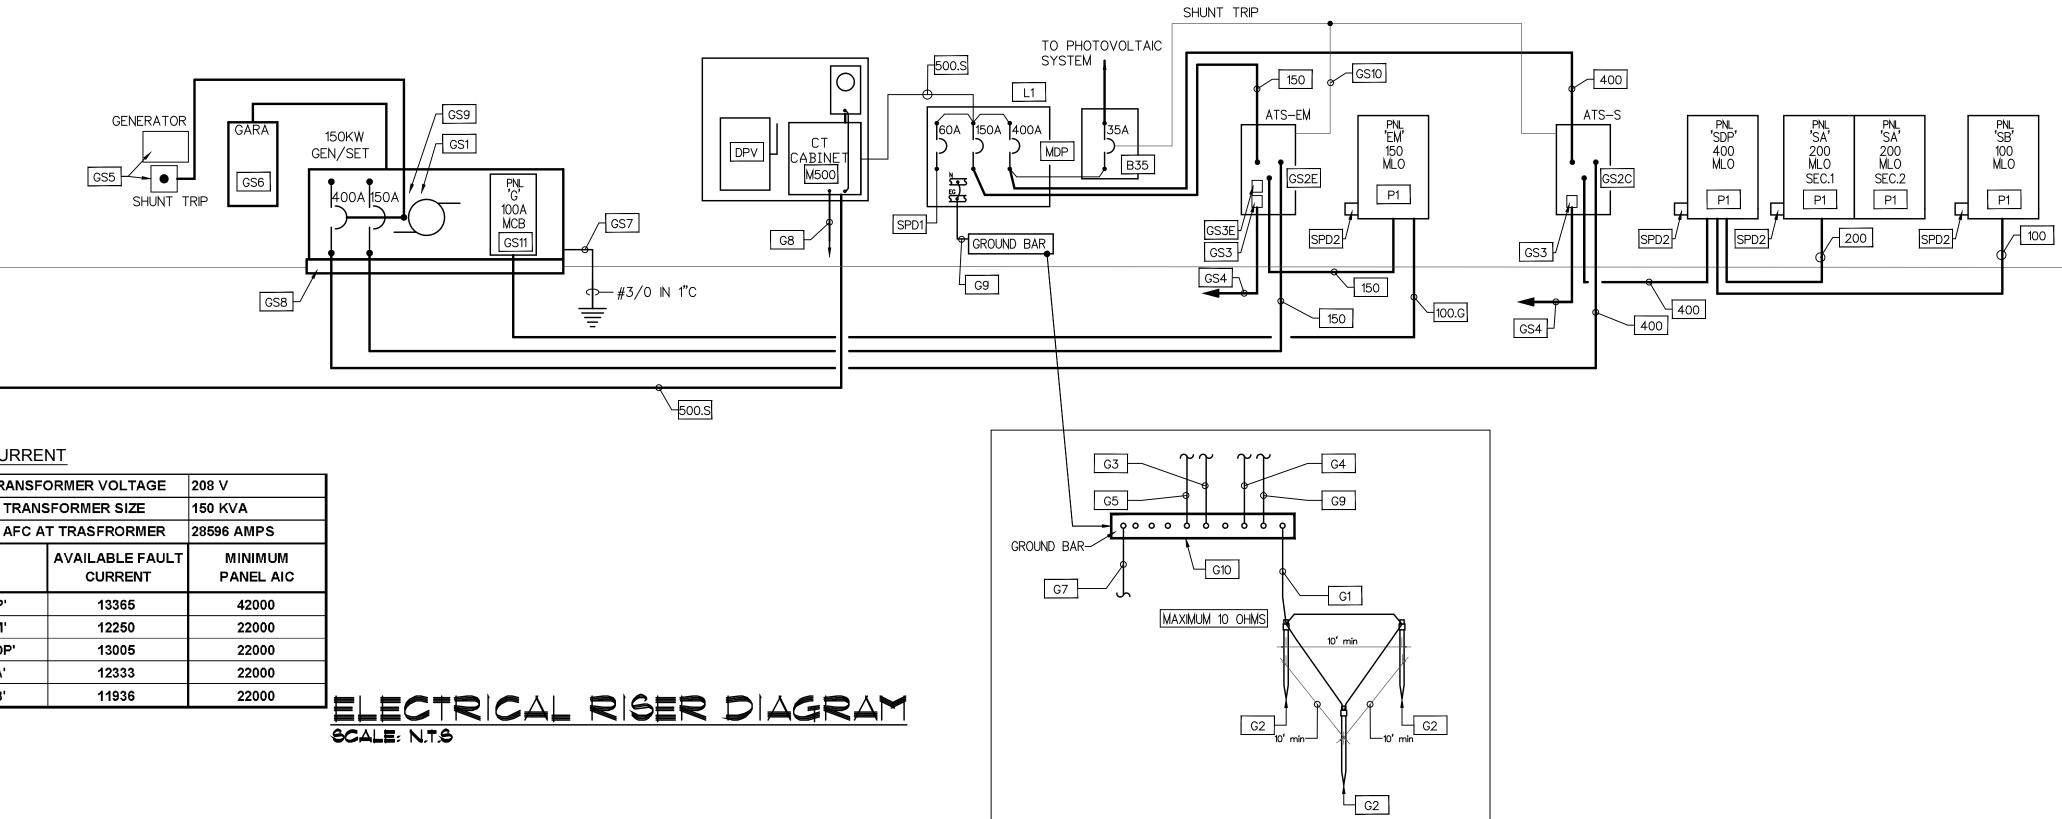

FAULT CURRENT

ΗH

UT1

UTILITY TRANSFO	208 V	
ASSUMED TRANS	150 KVA	
ASSUMED AFC A	28596 AMPS	
BUS	AVAILABLE FAULT CURRENT	MINIMUM PANEL AIC
MAIN 'MDP'	13365	42000
PANEL 'EM'	12250	22000
PANEL 'SDP'	13005	22000
PANEL 'SA'	12333	22000
PANEL 'SB'	11936	22000

GENERAL FLORIDA BUILDING CODE NOTES:	GENERAL ELECTRICAL RISER NOTES:	ELECTRICAL RISER NOTES:			GOLDER ASSOCIATES, INC. 5100 W. LEMON STREET #14 TAMPA, FL 33609	
ALL ELECTRICAL WORK SHALL COMPLY WITH FLORIDA BUILDING CODE, COMMERCIAL ENERGY EFFICIENCY	1. ELECTRICAL CONTRACTOR SHALL COORDINATE ALL ELECTRICAL WORK WITH ARCHITECT, OWNER AND GENERAL CONTRACTOR PRIOR TO BID AND START ANY WORK. NO EXCEPTION.	MISCELLANEOUS NOTES:	GROUNDING/BOUNDING NOTES:	GENERATOR NOTES:	FEEDER SCHEDULES:	
505.7.3 VOLTAGE DROP. 505.7.3.1 FEEDERS AND COSTUMER OWNED SERVICE CONDUCTORS.	2. ELECTRICAL CONTRACTOR SHALL SUBMIT A PROPOSE CONSTRUCTION SCHEDULE WITH INFORMATION REGARDING ANY POSSIBLE ELECTRICAL OUTAGE TO BUILDING	UTILITY COMPANY PAD HANDHOLE AT THE POLE MOUNTED TRANSFORMER. SECONDARY VOLTAGE TO BE 120/208Y 3 PHASE, 4 WIRE WYE. FIELD	G1 3/0 CU GROUND ELECTRODE CONDUCTOR IN 3/4" CONDUIT.	GS1 PROVIDE EMERGENCY GENERATOR LEVEL 1, GAS/LP (DUAL SOURCES) FUELED, 150KW, 3PH, 120/208V, (WYE) 60HZ, WITH OVERSIZE ALTERNATOR, 150 AMPS	[100] (FEEDER – 100 AMPS) 4 #1 AND 1#6 E.G. IN 1–1/2" C	LANDSCAPE CONSULTANT DAVID CONNER & ASSOCIATES
MAXIMUM VOLTAGE DROP OF 2 PERCENT AT DESIGN LOAD. 505.7.3.2 BRANCH CIRCUITS.		VERIFY EXACT LOCATION. CONTACT AND COORDINATE ALL ELECTRICAL WORK WITH UTILITY COMPANY AND OWNER PRIOR TO BID AND START	G2 3/4" X 20' LONG COPPER CLAD GROUND. CONNECT WITH EXOTHERMIC WELD.	AND 400 AMPS AMPS UNIT MOUNTED LSI CIRCUIT BREAKERS WITH SHUNT TRIP COIL, CERTIFIED BY THE ENVIRONMENTAL PROTECTION AGENCY (EPA) WITH	(FEEDER - 200 AMPS) 200 4 #3/0, AND 1#6 EG. IN 2" C	1509 W. SWANN AVENUE, SUITE 255 TAMPA, FL 33606
BRANCH CIRCUIT CONDUCTORS SHALL BE SIZED FOR A MAXIMUM VOLTAGE DROP OF 3 PERCENT AT DESIGN LOAD.	POWER DOWN TIME NOTES:	ANY WORK. NO EXCEPTION. REFER TO POWER COMPANY GENERAL NOTE ON THIS SHEET FOR ADDITIONAL REQUIREMENTS.	G3 EXTEND THE GROUND ELECTRODE SYSTEM TO A REBAR IN THE BUILDING FOUNDATION AND BUILDING STEEL. REBAR SHALL BE CONTINUOUS 20' LENGTH,	CRITICAL GRADE SOUND ALUMINUM ENCLOSURE, PF=0.8 BY KOHLER OR GENERAC, CAT AND ONAN EQUAL. VERIFY WITH GENERATOR MANUFACTURER	(FEEDER - 400 AMPS) (2) SETS OF 4 #3/0 AND 1#3 E.G. IN 2" C.	
505.7.4 COMPLETION REQUIREMENTS 505.7.4. DRAWINGS. CONSTRUCTION DOCUMENTS SHALL REQUIRE THAT WITHIN 30 DAYS AFTER THE	1. PROVIDE TEMPORARY BACK UP POWER AS REQUIRED OR/AND NEEDED DURING THE CONSTRUCTION.	M500 3 PHASE METER AND CT CABINET PER UTILITY COMPANY SPEC.	#4 MINIMUM AND ENCASED IN A MINIMUM 2" OF CONCRETE PER NEC 250.52 (3).	FOR EXACT LAYOUT AND CLEARANCE AND SITE CONDITIONS PRIOR TO ORDERING 150 A, 4 POLE, NEMA 1 AUTOMATIC TRANSFER	$\begin{array}{c} (\text{SERVICE}-500 \text{ AMPS}) \\ (2) \text{ SETS OF 4 } \#250 \text{ KCMIL IN } 2-1/2" \text{ C.} \end{array}$	FIRE STATION 19 7910 INTERBAY BLVD.
DATE OF SYSTEM ACCEPTANCE, RECORD DRAWINGS OF THE ACTUAL INSTALLATION SHALL BE PROVIDED TO THE BUILDING OWNER, INCLUDING: 1. A SINGLE-LINE DIAGRAM OF THE BUILDING ELECTRICAL DISTRIBUTION	UTILITY COMPANY COORDINATION NOTES:		GA BOND THE METALLIC COLD WATER PIPE TO THE GROUND ELECTRODE SYSTEM.	GS2E SWITCH WITH BYPASS ISOLATION, SURFACE MOUNTED, 50KA. THE TRANSFER SWITCH AND GENERATOR SHALL BE SUPPLIED AND SERVICED BY A SINGLE COMPANY. THE TRANSFER SWITCH	(FEEDER – 100 AMPS, 1PH) 100.G 3 #1 AND 1#6 E.G. IN 1-1/2" C	TAMPA, FL
SYSTEM AND 2. FLOOR PLANS INDICATING LOCATION AND AREA SERVED FOR ALL DISTRIBUTION.	1. ELECTRICAL CONTRACTOR SHALL COORDINATE ALL ELECTRICAL WORK WITH	SURGE PROTECTIVE DEVICE TYPE 1, UL 1449, 3RD SPD1 EDITION, NEMA 3R, 100KA. EXTEND 5#4 IN 1-1/2"C AS STRAIGHT AS POSSIBLE (MAX 2'-0").	G5 EXTEND A #1 GROUND ELECTRODE CONDUCTOR TO THE BUILDING TELEPHONE TERMINAL CABINET OR BOARD. PROVIDE A GROUND BAR AT THE TELEPHONE CABINET OR BOARD.	SHALL BE PROVIDED WITH INTEGRAL SURGE PROTECTIVE DEVICE.		DPW FILE NUMBER
505.7.4.2 MANUALS. CONSTRUCTION DOCUMENTS SHALL REQUIRE THAT AN OPERATING MANUAL AND MAINTENANCE MANUAL BE PROVIDED TO THE BUILDING OWNER. THE MANUALS	TECO (POWER COMPANY). CONTACT MRS. JUDY BUTTS, TECO AT 813-228-4709 FOR ALL ELECTRICAL UTILITY SERVICE WORK AND REQUIREMENTS. CONTRACTOR SHALL INCLUDE ALL FEES TO PROVIDE POWER TO THE BUILDING IN HIS BID PROPOSAL. NO EXCEPTION.	SURGE PROTECTIVE DEVICE TYPE 2, UL 1449, 3RD EDITION, NEMA 3R, 100KA, BY LEA. EXTEND 5#4 IN 1-1/2"C AS STRAIGHT AS POSSIBLE		GS2C 400 A, 4 POLE, NEMA 1 AUTOMATIC TRANSFER SWITCH WITH BYPASS ISOLATION, SURFACE MOUNTED, 50KA. THE TRANSFER SWITCH AND GENERATOR SHALL BE SUPPLIED AND SERVICED		DPW NUMBER
SHALL INCLUDE, AT A MINIMUM, THE FOLLOWING: 1. SUBMITTAL DATA STATING EQUIPMENT RATING AND SELECTED OPTIONS FOR EACH PIECE OF EQUIPMENT REQUIRING MAINTENANCE.		(MÁX 2'-0").		BY A SINGLE COMPANY. THE TRANSFER SWITCH SHALL BE PROVIDED WITH INTEGRAL SURGE PROTECTIVE DEVICE.		FD0116 ISSUE DATE
2. OPERATION MANUALS AND MAINTENANCE MANUALS FOR EACH PIECE OF EQUIPMENT REQUIRING MAINTENANCE. REQUIRED ROUTINE MAINTENANCE ACTIONS SHALL BE CLEARLY IDENTIFIED.	FAULT CURRENT AND SELECTIVE COORDINATION STUDIES NOTES:	DPV DISCONNECT SWITCH MOUNTED ADJACENT TO ELECTRIC METER FOR PHOTOVOLTAIC SYSTEM. REFER TO ELECTRICAL SHEET E2.5 FOR	WITH A #I CO GEC IN I CONDOIL.	GS3 GENERATOR START RELAY. GENERATOR START RELAY. REFER TO SPECIFICATION AND GENERATOR		MAY 31, 2013
3. NAMES AND ADDRESSES OF AT LEAST ONE QUALIFIED SERVICE AGENCY. 505.7.5 ELECTRICAL MOTORS. ELECTRICAL MOTORS SHALL COMPLY WITH THE REQUIREMENTS OF THE ENERGY	1. THE ELECTRICAL CONTRACTOR SHALL SUBMIT TO ENGINEER A LETTER FROM UTILITY COMPANY FOR THE AVAILABLE FAULT CURRENT AT THE SECONDARY	PHOTOVOLTAIC SYSTEM REQUIREMENTS. CONFIRM FINAL REQUIREMENTS WITH THE UTILITY COMPANY.	G9 3/0 CU GROUND CONDUCTOR IN 1" CONDUIT.	MANUFACTURER RECOMMENDATION AND INSTRUCTION. GS3E EMERGENCY LIGHTING CONTROL RELAY. COORDINATE WITH GENERATOR AND LIGHTING		DRAWN BY
POLICY ACT OF 1992.	TERMINALS AT THE INSTALLED UTILITY TRANSFORMER WITH PANEL SUBMITTALS. IF A LETTER IS NOT PROVIDED WITH THE PANEL SUBMITTALS, THE SUBMITTALS WILL BE REJECTED WITHOUT REVIEW. NO EXCEPTION.	MDP MAIN DISTRIBUTION PANEL 3PH, 208/120V. REFER TO ELECTRICAL PANEL SCHEDULE FOR REQUIREMENTS.	G10 PROVIDE COOPER GROUND BUSS 20" X 4" X 1/4" THICK ERICO MODEL #EGBA14420NN COMPLETE WITH INSULATOR MOUNTED BRACKET. NO HOLES.	COORDINATE WITH GENERATOR AND LIGHTING CONTROL MANUFACTURERS. EXTEND 3/4"C TO EMERGENCY LIGHTING CONTROL PANEL.		
	2. CONTRACTOR SHALL PROVIDE FAULT CURRENT AND SELECTIVE COORDINATION STUDY FOR ENTIRE ELECTRICAL SYSTEM PER NFPA 70 AND IEEE. REFER TO	ELECTRICAL PANEL, 3PH, 208/120V. REFER TO ELECTRICAL PANEL SCHEDULE FOR REQUIREMENTS.	PROVIDE CONNECTORS AND BOLT HOLES AS REQUIRED. MOUNT ADJACENT TO MAIN SWITCHBOARD OR AS SHOWN ON THE ELECTRICAL	GS4 3 #12 IN 1/2"C TO GENERATOR CONTROL PANEL.		
	ELECTRICAL SPECIFICATION FOR REQUIREMENTS.	PROVIDE LABEL:	DRAWINGS.	GS5 GENERATOR EMERGENCY STOP SWITCHES (ONE IN ELECTRICAL ROOM AND ONE ADJACENT TO FACP IN NEMA 3R BOX. PROVIDE 1/4" WHITE ENGRAVED		
		WARNING - ELECTRICAL SHOCK HAZARD-PANEL HAS THREE INPUT POWER SUPPLIES (UTILITY, GENERATOR AND PHOTOVOLTAIC). DISCONNECT ALL		LETTERS ON RED LAMINATED PLASTIC UNDER STOP SWITCH TO READ "GENERATOR EMERGENCY STOP". SURFACE MOUNT SWITCH 4'-6".		SEAL
		CIRCUITS BREAKERS FROM ALL POWER SOURCES BEFORE ANY WORK. B35 PROVIDE ENCLOSED CIRCUIT BREAKER 35 AMPS, 3P, 42KAIC RATED FOR PHOTOVOLTAIC SYSTEM WITH SHUNT TRIP MECHANISM. INTERLOCK SHUNT TRIP		GS6 PROVIDE GENERATOR ALARM REMOTE ANNUNCIATOR (GARA) PANEL. COORDINATE FINAL LOCATION WITH OWNER AND AHJ AND EXTEND (1)-1"C WITH WIRING PER MANUFACTURER REQUIREMENTS.		
			, ,			Signature Date
		WITH ATS CONTACT. SHUNT TRIP TO BE ACTIVATE UPON TRANSFER TO GENERATOR POWER.	D	GS7 BOND NEUTRAL TO GROUND AT THE GENERATOR (SEPARATE DERIVE SYSTEM). PROVIDE COMPLETE GROUND/BOND FOR A SEPARATE DERIVE SYSTEM		IVAYLO I. TODOROV FLORIDA P.E.
				PER NPÉA 70 - NATIONAL ELECTRIC CODE.		#73028 SCALE: N.T.S.
				GS8 PROVIDE CONCRETE PAD. DIMENSIONS TO BE 12" WIDER THAN GENERATOR FOOT PRINT.		
				GS9 THE GENERATOR ENCLOSURE SHALL BE SOUND ATTENUATED (SOUND ATTENUATION LEVEL: 60 dBA REDUCTION AT 12'-O") (FREE FIELD) ALUMINUM CONSTRUCTION OUTDOOR WEATHER PROTECTIVE		ELECTRICAL RISER DIAGRAM
				ENCLOSURE PACKAGE FOR STANDBY GENERATOR SET, LISTED AND CERTIFIED TO 150 MPH WIND, CAPACITY, MEETS ASCE 7-05, WIND RESISTANCE.		SHEET NUMBER
				GS10 EMERGENCY SHUNT TRIP FOR MAIN CIRCUIT BREAKER OF THE PHOTOVOLTAIC SYSTEM. COORDINATE WITH		E3.1
				GENERATOR AND PV SYSTEM INSTALLER.	GRINER ENGINEERING, INC. 1628 First Avenue North St. Petersburg, Florida 33713 Date 05/31/2013 Drawn IIT Designed IIT	
				120/208V, 1PH PROVIDED BY GENERATOR VENDOR.	Phone: (727)-822-2335 Designed II1 Fax: (727)-821-3361 EOR JHG Certificate of Authorization #3173 Job no. 12032	



David R. Pagitt Supervisor, Architectural Drafting Kinsey C. Tillman Drafting Technician Jerry P. Sanders Drafting Technician Byron K. Thomas Drafting Technician

MEP CONSULTANT GRINER ENGINEERING, INC. 1628 Ist. AVENUE NORTH ST. PETERSBURG, FL 33713

STRUCTURAL CONSULTANT ROGAL-TGA CONSULTING ENGINEERS, INC. 124 5th Avenue South, Suite B SAFETY HARBOR, FL 34695

CIVIL CONSULTANT

CONTRACT 13-C-00033; Fire Station 19 Improvements - Pre-Bid Conf. 06/18/2013

-	E-Mail to Register as a Plan Holder and E-Mail All Questions to; ContractAdministration@tampagov.net				
-	E-Mail to Register as a Plan Holder and E-Mail P Sign-In Sheet S Please Print		City of Tampa, Contract Administration Department		
	Name	Organization	E-Mail OR Phone		
1	Jim Greiner, PE	Tampa Contract Administration Dept.	Jim.Greiner@tampagov.net		
2	RAY VARGAS	KENYON FPARTNERS	RAY. VARGAS @ KENYOH AND PARTNERS. com		
3	JAMEMitehll	Hen Kelman Const	JAMB & HCINC, NET		
4	KERRICK Williams	KWPConstruction Video	Kerricke Kur Construction Video. cum		
5	Matt Recd	A The Blue Book	mreed@mail.the bluebak.com		
61	TODO HINRICHS	SILVERKING CONTRACTING	TOODGS, LVEEKING CONTRACTING INC. COM		
7	Luke Voelker	ACF Stradby Systems	Livoelker @act.com		
8	James Davis	ACF Standby Systems	J. Jauls actrower.com		
9	Mike McCandless	Connerstone Solutions	miker @ cornerstanesolutions group. ko		
10	Michael R. News	Reeves Plumburg	Mikem @ cornerstancsolutions yroup.com Recver building of vention.net DANIEL. LODUCA @ HORUS-CS. COM		
11	DANIEL LODUCA	HORUS CONSTRUCTION	DANIEL, LODUCH CHORUS-CS. COM		
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