CITY OF TAMPA



Bob Buckhorn, Mayor

CONTRACT ADMINISTRATION DEPARTMENT

David L. Vaughn, AIA, Director

ADDENDUM NO. 4

DATE: February 5, 2015


Contract 15-C-00018; David L. Tippin Water Treatment Plant Dewatering Building Bathroom Modifications - Sheltered Market

Bidders on the above referenced project are hereby notified that the following addendum is made to the Contract Documents. BIDS TO BE SUBMITTED SHALL CONFORM TO THIS NOTICE.

- Item 1: Specifications, Section 01020 Allowances, page 01020-2: Change Allowance No. 1 to read \$5,000.
- Item 1: Replace Plan Sheet Nos. G-0.1, A 2.1 and A 1.1 with the attached revised Plan Sheet Nos. G-0.1, A 1.1 and A 2.1.

All other provisions of the Contract Documents and Specifications not in conflict with this Addendum shall remain in full force and effect. Questions are to be e-mailed to Contract Administration@tampagov.net.

Jim Greiner, P.E., Contract Management Supervisor

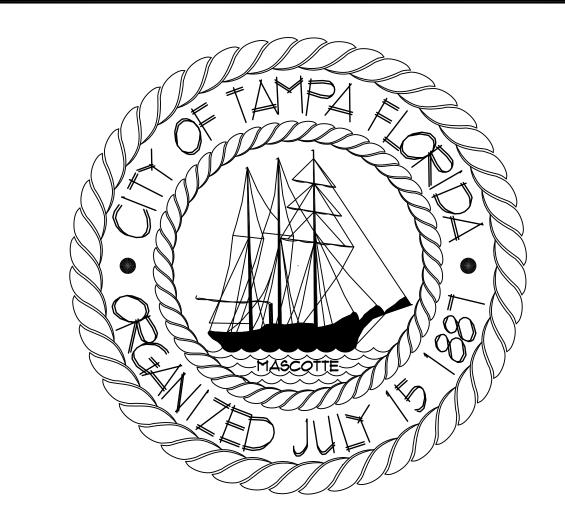

DAVID L. TIPPIN WATER TREATMENT PLANT DEWATERING BUILDING BATHROOM MODIFICATION

CONSULTANTS

ABBREVIATIONS

above finished floor air conditioning alternate anchor bolt bituminous blocking built up roofing cast-in-place concrete ceramic tile clearance column concrete ceramic mosaic tile concrete masonry unit continuous or continue control joint dampproofing dead load detail diameter

dimension downspout drinking fountain electrical electrical water cooler elevation

INSUL JT JST LAY LTL MH

MOD

NOM

insulate (d), (ion)

masonry opening mechanical metal

not in contract

polyvinyl chloride

precast concrete

reinforced vinyl title

property line radius

specification(s)

stàinless steel

to be removed

vapor barrier

water closet water heater

water proofing

vinyl asbestos title vinyl base

telephone thick(ness)

vertical

wood

roofing

similar

square

steel structural

post-tension concrete

bounds per cubic feet pounds per lines | foot

pounds per square foot

pounds per square inch

not to scale

pressure

lavatory

modular

nominal

existina expansion joint exterior finished floor elevation finished floor line flashing flooring floor drain footing furnished by others general contractor ğlass, glazing grab bar GYPDWL gypsum dry wall HDW HT HC HB hardware

ALTERNATES

hollow core hose bibb

SYMBOLS




—note number

reference return air roof drain rough opening service sink solid core

109 tongue & groove unless noted otherwise

A-2 SCALE: 1/8"=1'-0"

DESCRIPTIVE TITLE

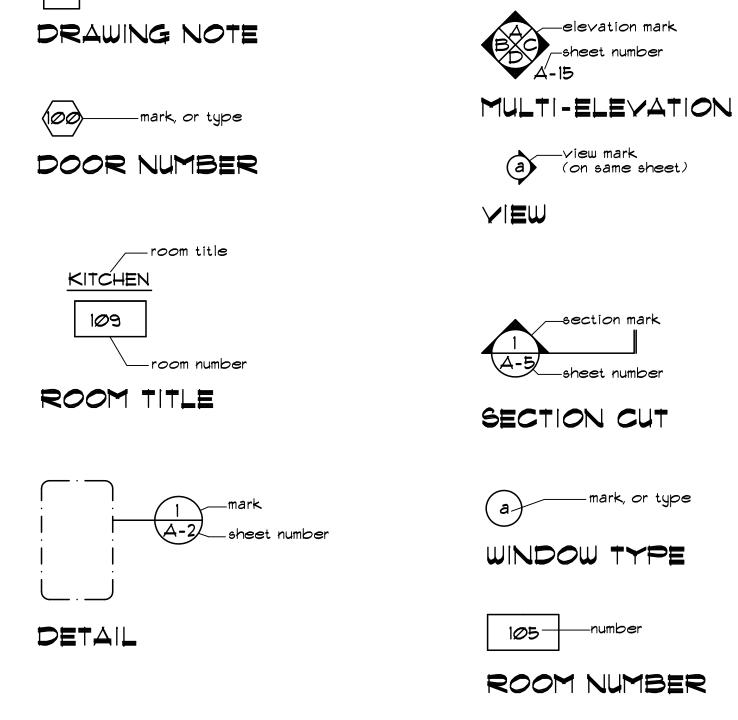

-drawing type N

north arrow-

elevation mark

ELEVATION

DPW FILE NUMBER

15-6-00018

DPW NUMBER

ISSUE DATE

DECEMBER 8, 2014 REV: FEBRUARY 5, 2015

ARCHITECT

JAMES E. JACKSON JR., AIA, CITY ARCHITECT ARR0015839 306 E. JACKSON ST. 4N

PROJECT NOTES

- ALL CONSTRUCTION SHALL COMPLY WITH APPLICABLE CODES AND STANDARDS, INCLUDING BUT NOT LIMITED TO ALL STATE LAWS, LOCAL ORDINANCES, UTILITY COMPANY, FLORIDA ACCESSIBILITY CODE FOR BUILDING CONSTRUCTION, THE STANDARD MECHANICAL CODE, THE STANDARD PLUMBING CODE, THE OCCUPATIONAL SAFETY AND HEALTH ACT, NFPA AND THE CURRENTLY ADOPTED STANDARD BUILDING CODE
- CONTRACTOR SHALL REMOVE ALL DEBRIS FROM THE PROJECT SITE AS REQUIRED TO MAINTAIN A SAFE AND ORDERLY WORK ENVIRONMENT.
- GENERAL CONTRACTOR SHALL VERIFY ALL DIMENSIONS AND EXISTING CONDITIONS PRIOR TO AND DURING CONSTRUCTION.
- DEMOLITION WORK SHALL NOT BE LIMITED TO THESE DOCUMENTS TO COMPLETE PROJECT AS ILLUSTRATED, REMOVE ITEMS NECESSARY TO ALLOW FOR NEW CONSTRUCTION.
- EXISTING SURFACES (WALLS, CEILINGS, ETC.) SHALL BE PROTECTED DURING CONSTRUCTION. THE CONTRACTOR SHALL CLEAN SURFACES AFTER CONSTRUCTION. REPAIR, PAINT AND OR REPLACE AREAS DAMAGED AS A RESULT OF PERFORMANCE OF THE WORK.
- 6 ALL WORK SHALL BE COORDINATED WITH THE CITY OF TAMPA'S ARCHITECTURAL REPRESENTATIVE.
- THE CONTRACTOR SHALL SECURE ALL OPENINGS UNDER CONSTRUCTION AT THE END OF EACH WORKING DAY.
- ITEMS OR AREAS DAMAGED BY THE CONTRACTOR OR SUBCONTRACTORS SHALL BE REPAIRED OR REPLACED AT THE CONTRACTOR'S EXPENSE.
- BACKGROUND CHECK ARE REQUIRED FOR ALL EMPLOYEES OF CONTRACTOR, SUB CONTRACTORS AND SUPPLIES.

INDEX

ARCHITECTURAL


G-Ø.1 COVER SHEET / GENERAL INFORMATION A-1.1 SITE PLAN

A-2.1 FLOOR PLANS & DETAIL

AERIAL MAP

SITE LOCATION

DAVID L. TIPPIN WATER TREATMENT PLANT 7125 N. 30TH STREET TAMPA, FLORIDA 33604

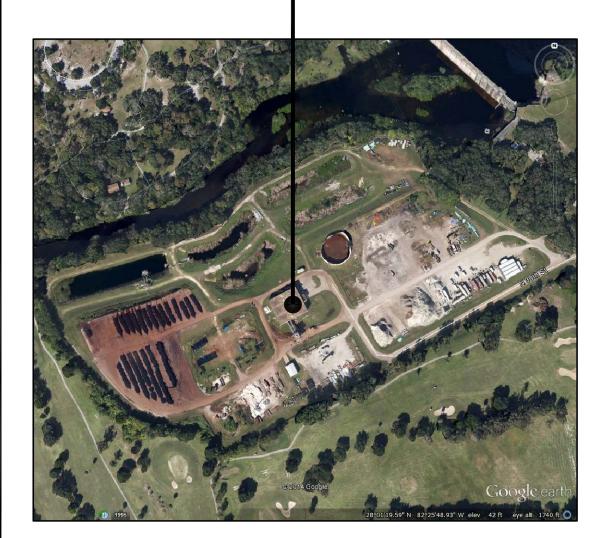


SQUARE FOOTAGE

SHEET NUMBER G-0.1 OF 3





GENERAL NOTES

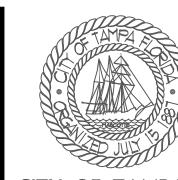

CITY OF TAMPA
CONTRACT ADMINISTRATION
DEPARTMENT
PLANNING AND DESIGN DIVISION

PLANNING AND DESIGN DIVISION

306 E. JACKSON STREET 4 NORTH
TAMPA, FLORIDA 33602
p: 813. 274. 8456 - f: 813. 274. 8080
url: www.tampagov.net

James E. Jackson, Jr. AIA, NOMA
City Architect
Edward D. Rice, AIA
Project Architect
Keele I. Henlike, AIA

KEY NOTES

Kinsey C. Tillman Drafting Technician

Jerry P. Sanders
Drafting Technician

Byron K. Thomas, LEED GA
Drafting Technician

MEP CONSULTANT

STRUCTURAL CONSULTANT

CIVIL CONSULTANT

LANDSCAPE CONSULTANT

DLT WATER TREATMENT PLANT
DEWATER BUILDING BATHROOM MODIFICTION
TAMPA, FLORIDA

FILE NUMBER

PROJECT NUMBER 15-C-00018

DECEMBER 8, 2014

ISSUE DATE

DRAWN BY
JERRY P. SANDERS

REVISIONS

2-5-2015


 \triangle


PROFESSIONAL SEAL

SCALE: 1'=1'-0"

SHEET NUMBER

/\ I.I

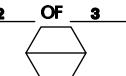

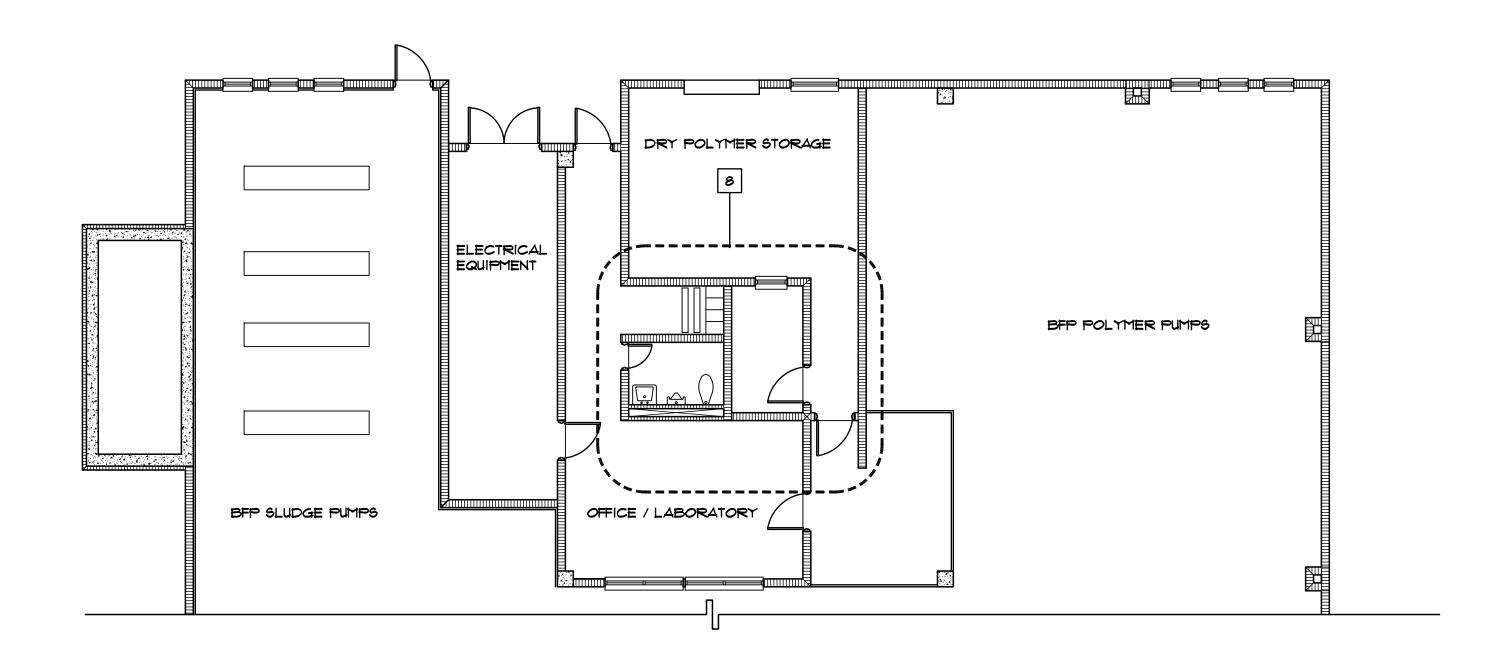


PARTIAL INFORMATION FLOOR PLAN (EAST HVAC AND BUILDING SPACE)


SCALE 1/4" = 1'-0"

SHOWER ELEVATION


8'-0"

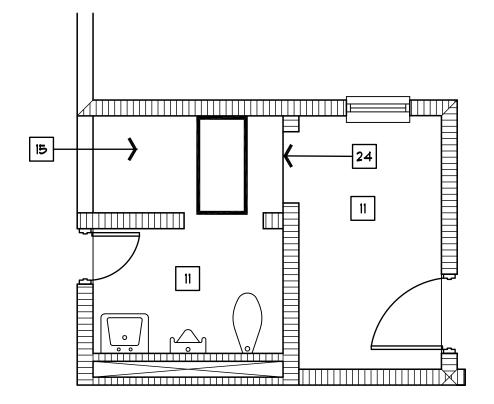



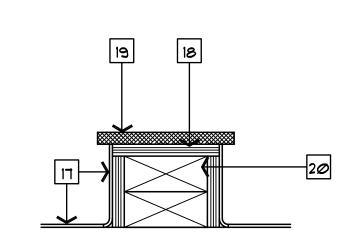


TYPICAL CURB DETAIL SCALE 3" = 1'-0"

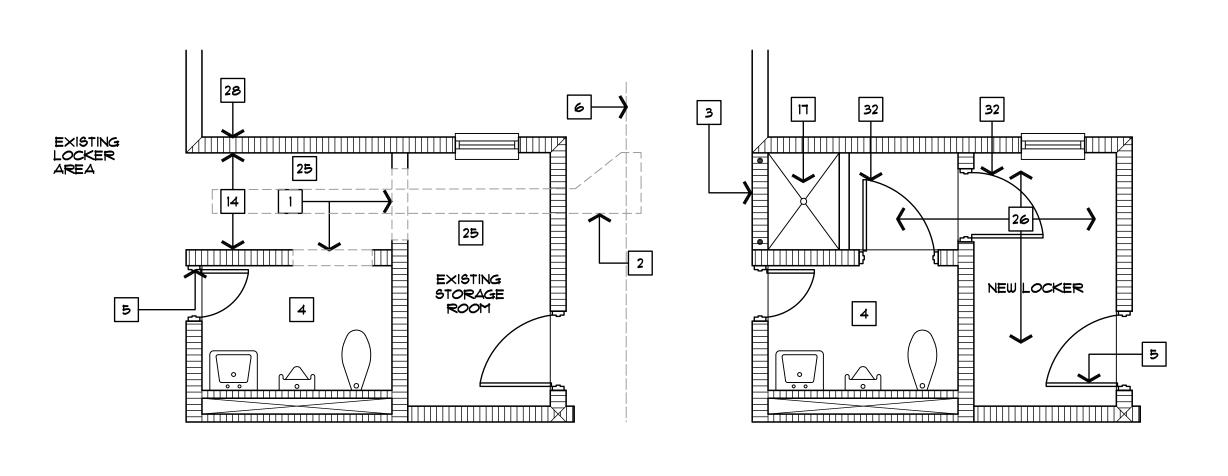

SCALE 1/8" = 1'-0"


DEMO FLOOR PLAN SCALE 1/4" = 1'-0"



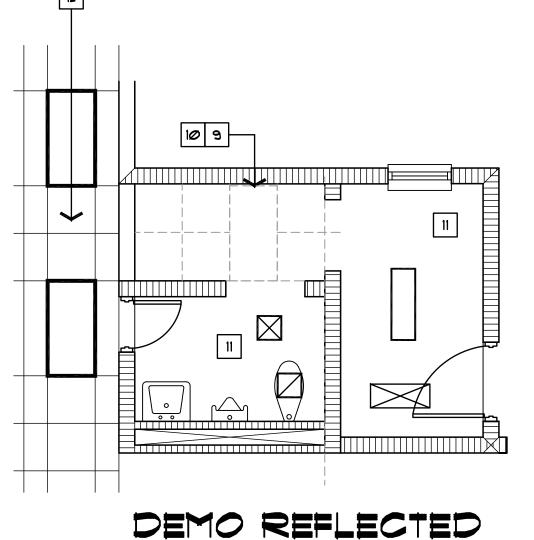

CEILING PLAN

SCALE 1/4" = 1'-0"

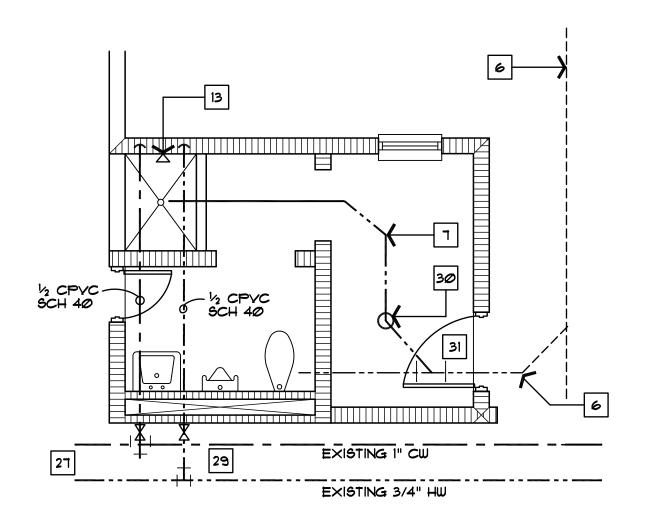

PLUMBING FLOOR PLAN SCALE 1/4" = 1'-0"

GENERAL NOTES

- PAINT REQUIREMENTS FOR ALL WALLS AND SHOWER AREA CEILING.
- A. MASONRY BLOCK SIMILAR TO PORTER 896 ACRI FILL ACRYLIC BLOCK FILTER.
- B. MASONRY WALLS INTERIOR SEMI GLOSS ODORLESS ALKYD ENAMEL - SIMILAR TO PORTER 4139 GLYPTE SATIN ENAMEL WITH PORTER 429 UNDERCOAT AND PRIMER PORTER 689 HI-HIDE FLAT.
- C. GYPSUM BOARD CEILING SIMILAR TO MASONRY PAINT REQUIREMENTS.
- 2. CAULK AT CEILING TO WALL CONDITIONS WITH SILICON SEALANT SIMILAR TO BOSTIK CHEM - CALK 1200' OR EQUAL.

KEY NOTES

- I EXISTING WALL TO BE CUT.
- 2 CUT EXISTING FLOOR FOR PLUMBING.
- 3 NEW 8" CMU INFILL WALL PAINT HALL SIDE.
- 4 EXISTING RESTROOM TO REMAIN.
- 5 EXISTING DOOR TO REMAIN.
- 6 EXISTING 4" WASTE LINE. 7 NEW 3" SCHEDULE 40 PYC WASTE LINE
- PATCH FLOOR OPENING WITH 4" 3000 PSI CONCRETE WITH FIBER MESH.
- 8 AREA OF WORK.
- 9 EXISTING LIGHT TO BE RELOCATED SUSPENDED CEILING TO BE ADJUSTED REMOVED.
- BE REMOVED II EXISTING CEILING TO REMAIN IN PLACE.

10 EXISTING 2x2 CEILING TILES TO

- 12 EXISTING LIGHT AND CEILING GRID AND TILE TO REMAIN.
- 13 SHOWER ASSEMBLY ZUM Z-1700 'TEMP - GUARD 'PRESSURE BALANCING SHOWER MIXING YALVE WITH WALL MOUNTED INSTITUTIONAL SHOWER HEAD. JAY R. SMITH #2010 - A SHOWER DRAIN 5" DIAMETER ROUND NICKEL BRONZE TOP. PROVIDE TRAP, SUPPLIES, STOPS, ETC. FOR COMPLETE INSTALLATION.
- 14 EXISTING CMU WALLS TO BE CLEAN UP AND PREPARED FOR NEW WORK
- 15 MOISTURE RESISTANT 5/8" GYP. BOARD SUSPENDED ON HEAVY DUTY GRID RATED FOR INTERIOR APPLICATION BY USG INTERIORS OR EQUAL. 2' MIN. CARRYING CHANNELS ASTM C645 COMPOSED OF MAIN BEAMS OF CROSS FURRING MEMBERS THAT INTERLOCK TO FORM A MODULAR SUPPORTING NETWORK.
- 16 PROVIDE CERAMIC WALL TILE 4"x4" 1/4" MODULAR SQUARE SIMILAR TO DAL-TILE OR EQUAL. COLOR AS SELECT FROM FULL RANGE OF STANDARD COLORS. PROVIDE SETTING MATERIALS AND GROUT MEETING ANSI A118.6 REQUIREMENTS. INSTALL ON THREE SIDES FULL HEIGHT.
- 17 PROVIDE 2" x 2" x 1/8" MOSAIC FLOOR TILE, SLIP RESTRAINT, 12" x 12" MOUNTED SHEETS 2" × 2" 1/8" WALL BASE WITH COVE, COLOR AS SELECTED FROM FULL RANGE OF STANDARD COLORS. PROVIDE SETTING MATERIALS SEE
- 18 1/2" CEM. BD. SIM. TO DUROROCK
- 19 1/2" x 5" WIDE TRAVERTINE SILL
- 20 P.T. DOUBLE 2×4 CONTINUOUS SILL 21 2" × 2" MOSAIC TILE BASE.
- 22 PROVIDE *5 DOWEL 30" IN LENGTH WITH EMBED INTO SLAB 2" SET IN EPOXY PROVIDE 1 *5 VERTICAL TO WITHIN 1 COURSE OF TOP OF WALL.
- 23 EXISTING HEADER TO REMAIN ALIGN WALL WITH HEADER.
- 24 NEW CEILING TO EXISTING CEILING PROVIDE
- J BEAD. 25 EXISTING VCT TO BE REMOVED
- 26 NEW 12"x12" VINYL COMPOSITION TILE SIMILAR TO ARMSTRONG OR EQUAL PROVIDE WATER RESISTANT ADHESIVE PROVIDE COVE WALL BASE ARMSTRONG OR EQUAL COLOR SELECTED FROM STANDARD RANG OF COLORS.
- 27 EXISTING WATER HEATER ABOVE CEILING
- CONTRACTOR TO LOCATE,, TIE IN 28 CUT CMU FACE SHELL TO FACILITATE
- SHOWER COMPONENTS AND WATER LINES. 29 PROVIDE COPPER TO CPVC TRANSITION COMPONENTS AND GATE YALVE.
- 30 FLOOR CLEAN OUT SIZED TO MATCH EXISTING DRAIN WITH BRASS COVER PLATE 31 CUT EXISTING WASTE LINE, PROVIDE GALVANIZED PIPE TO PVC TRANSITION
- COMPONENTS. 32. NEW 3'x7' G60 GALY.DOOR WITH LEVER SET HARDWARE AND 1.5 PAIR HINGES. METAL DOOR IS 1 3/4" THICK METAL FRAME PER ANSI/SDI 100 BOTH BY STEELCRAFT OR

EQAUL. LEVER SET BY SCHLAGE ,SATIN CHROME FINISH. HINGES BY IVES, STAINLESS

STEEL. PAINT FRAME AND DOOR SURFACES.



CITY OF TAMPA CONTRACT ADMINISTRATION DEPARTMENT

PLANNING AND DESIGN DIVISION 306 E. JACKSON STREET 4 NORTH TAMPA, FLORIDA 33602 p: 813. 274. 8456 - f: 813. 274. 8080 url: www.tampagov.net James E. Jackson, Jr. AIA, NOMA City Architect

Edward D. Rice, AIA Project Architect Thomas A. Hester, Sr., AIA, NOMA Project Architect

Kinsey C. Tillman Drafting Technician Jerry P. Sanders Drafting Technician Byron K. Thomas, LEED GA Drafting Technician

MEP CONSULTANT

STRUCTURAL CONSULTANT

CIVIL CONSULTANT

LANDSCAPE CONSULTANT

DLT WATER TREATMENT PLANT DEWATER BUILDING BATHROOM MODIFICTION

FILE NUMBER

TAMPA, FLORIDA

PROJECT NUMBER 15-C-00018

ISSUE DATE **DECEMBER 8, 2014**

DRAWN BY JERRY P. SANDERS

REVISIONS 1 2-5-2015

PROFESSIONAL SEAL

SCALE: 1'=1'-0"

SHEET NUMBER A 2.1

_OF <u>2</u>

