

# Contract Administration Michael W. Chucran, Director

306 East Jackson Street, 4N Tampa, FL 33602

> Office (813) 274-8116 Fax: (813) 274-7368

### ADDENDUM 1 Via E-Mail DATE: July 17, 2020

Contract 19-C-00018; E. Columbus Drive from N Nebraska Ave (SR45) to 14th St. Bike Lane/Sidewalk – FDOT LAP

Bidders on the above referenced project are hereby notified that the following addendum is made to the Contract Documents. BIDS TO BE SUBMITTED SHALL CONFORM TO THIS NOTICE.

- Item 1: Replace the Plans with the attached Plans.
- Item 2: Replace Plans Sheets 1 and 2A with the attached Plans Sheets 1 and 2A.
- Item 3. Attached is a Contamination Locator Map and three Assessment Reports.

All other provisions of the Contract Documents and Specifications not in conflict with this Addendum shall remain in full force and effect. Questions are to be e-mailed to Contract Administration@tampagov.net.

zm gremer

Jim Greiner, P.E., Contract Management Supervisor

INDEX OF ROADWAY PLANS

ROADWAY PLANS
SIGNING AND PAVEMENT MARKING PLANS
SIGNALIZATION PLANS
LANDSCAPE ARCHITECTURE PLANS
UTILITY WORK BY HIGHWAY CONTRACTOR AGREEMENT PLANS

### STATE OF FLORIDA CITY OF TAMPA

### WALK-BIKE LAP PROJECT

CITY PROJECT NO. 1001221


FINANCIAL PROJECT ID 436639-1-58-01

(FEDERAL FUNDS)

HILLSBOROUGH COUNTY

E COLUMBUS DR FROM N NEBRASKA AVE (SR45) TO 14TH ST

#### SHEET NO. SHEET DESCRIPTION KEY SHEET SIGNATURE SHEET 2 SUMMARY OF PAY ITEMS 3 4 - 5 TYPICAL SECTION TYPICAL SECTION DETAILS 6 - 7 8 - 10 SUMMARY OF DRAINAGE STRUCTURES 11 PROJECT CONTROL GENERAL NOTES 12 13 - 17 ROADWAY PLANS ROADWAY PROFILES 18 - 22 23 - 43 DRAINAGE STRUCTURES 44 - 46 DRAINAGE DETAILS TREE WELL DETAILS DATA TABLE 47 - 49 50 - 54 INTERSECTION LAYOUTS 55 - 63 GRADING DETAILS 64 - 83 CROSS SECTIONS 84 - 99 DRIVEWAY HALF-SECTIONS TEMPORARY TRAFFIC CONTROL PLANS 100 - 101 UTILITY ADJUSTMENTS 102 - 106 SQ-1 - SQ-13 SUMMARY OF QUANTITIES

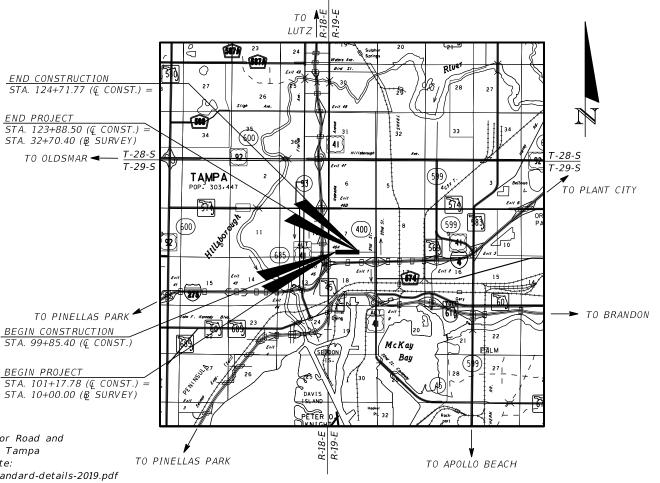

### CONSTRUCTION PLANS MARCH 2020

### ROADWAY PLANS ENGINEER OF RECORD:

JEFFREY SIEWERT, P.E.
P.E. LICENSE NUMBER 39196
AYRES ASSOCIATES
8875 HIDDEN RIVER PKWY, SUITE 200
TAMPA, FL 33637
(813) 978-8688
CERTIFICATE OF AUTHORIZATION 4356

### PROJECT MANAGER:

NINA MABILLEAU, E.I.

ST PETERSBUR

LOCATION OF PROJECT

FISCAL	SHEET
YEAR	NO.
21	1

### GOVERNING STANDARD PLANS:

Florida Department of Transportation, FY 2019-20 Standard Plans for Road and Bridge Construction, applicable Interim Revisions (IRs), and City of Tampa Stormwater Standards: Which can be found at the following web site: https://www.tampagov.net/sites/default/files/stormwater/files/sw-standard-details-2019.pdf For the City of Tampa Water Department Engineering Standard Details can be found at the following web site:

https://www.tampagov.net/sites/default/files/water/files/technical\_standard\_details\_0.pdf
For the City of Tampa Wastewater Department Technical Standards Guideline for
Construction of Wastewater Facilities, go to the web page site:
https://www.tampagov.net/sites/default/files/wastewater/files/TECHNICAL\_STANDARDS\_
GUIDELINE\_FOR\_CONSTRUCTION\_OF\_WASTEWATER\_FACILITIES\_JULY\_2014\_VERSION\_6.PDF

Standard Plans for Road Construction and associated IRs are available at the following website: http://www.fdot.gov/design/standardplans

### GOVERNING STANDARD SPECIFICATIONS:

Florida Department of Transportation, January 2020 Standard Specifications for Road and Bridge Construction at the following website: http://www.fdot.gov/programmanagement/Implemented/SpecBooks

AYTONA BEACH



THIS ITEM HAS BEEN DIGITALLY SIGNED AND SEALED BY

## Jeffrey J Siewert 2020.05.20 16:13:17 -04'00'

ON THE DATE ADJACENT TO THE SEAL

PRINTED COPIES OF THIS DOCUMENT ARE NOT CONSIDERED SIGNED AND SEALED AND THE SIGNATURE MUST BE VERIFIED ON ANY ELECTRONIC COPIES.

AYRES ASSOCIATES INC 8875 HIDDEN RIVER PKWY, SUITE 200 TAMPA, FL 33637 CERTIFICATE OF AUTHORIZATION: 4356 JEFFREY SIEWERT, P.E. NO. 39196

THE ABOVE NAMED PROFESSIONAL ENGINEER SHALL BE RESPONSIBLE FOR THE FOLLOWING SHEETS IN ACCORDANCE WITH RULE 61G15-23.004, F.A.C.

SHEET NO.	SHEET DESCRIPTION
1	KEY SHEET
2	SIGNATURE SHEET
3	SUMMARY OF PAY ITEMS
4 - 5	TYPICAL SECTION
6 - 7	TYPICAL SECTION DETAILS
11	PROJECT CONTROL
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102 - 106	UTILITY ADJUSTMENTS
SQ-1	SUMMARY OF QUANTITIES
SQ-5 - SQ-13	SUMMARY OF QUANTITIES



THIS ITEM HAS BEEN DIGITALLY SIGNED AND SEALED BY

### Thomas J Ward 2020.05.19 16:54:23 -04'00'

ON THE DATE ADJACENT TO THE SEAL

PRINTED COPIES OF THIS DOCUMENT ARE NOT CONSIDERED SIGNED AND SEALED AND THE SIGNATURE MUST BE VERIFIED ON ANY ELECTRONIC COPIES.

BES INC. 1107 N 56TH ST, SUITE 209 TEMPLE TERRACE, FL 33617 CERTIFICATE OF AUTHORIZATION: 9835 THOMAS WARD, P.E. NO. 52144

THE ABOVE NAMED PROFESSIONAL ENGINEER SHALL BE RESPONSIBLE FOR THE FOLLOWING SHEETS IN ACCORDANCE WITH RULE 61G15-23.004, F.A.C.

SHEET NO.	SHEET DESCRIPTION
2	SIGNATURE SHEET
8 - 10	SUMMARY OF DRAINAGE STRUCTURES
23 - 43	DRAINAGE STRUCTURES
44 - 46	DRAINAGE DETAILS
47 - 49	TREE WELL DETAILS DATA TABLE
SQ-2 - SQ-4	SUMMARY OF QUANTITIES


		JEFFREY SIEWERT, P.E.			
DATE	DESCRIPTION	DATE	DESCRIPTION	P.E. LICENSE NUMBER 39196 AYRES ASSOCIATES 8875 HIDDEN RIVER PKWY, SUITE 200 TAMPA, FL 33637 CERTIFICATE OF AUTHORIZATION 4356	
				I	

CITY OF TAMPA TRANSPORTATION DEPARTMENT										
CITY PROJECT NO.	COUNTY	FINANCIAL PROJECT ID								
1001221 HILLSBOROUGH 436639-1-58-01										

SIGNATURE SHEET


SHEET NO.

		CITY OF TAMPA			SUMMARY OF SIGNALIZATION (CONT.)						
		PROPOSAL SUMMARY OF PAY ITEMS			ITEM NUMBER		ITEM DESCRIPTION	UNIT	QUANTITY TOTAL		
		CIP NO.: 1001221 / FPID: 436639-1-58-01			0633 4 1		CABLE - TWISTED PAIR CABLE, FURNISH & INSTALL	LF.	50		
		SUMMARY OF ROADWAY			0633 4 6 0635 2 11	PULL & SPLICE BOX, F&I, I	CABLE- TWISTED PAIR CABLE, REMOVE	LF EA	30		
ITEM NUMBER		ITEM DESCRIPTION	UNIT	QUANTITY TOTAL	0635 2 12	PULL & SPLICE BOX, F&I, 2		EA	1		
0101 1	MOBILIZATION		LS	1	0639 1122		CE, F&I, UNDERGROUND, METER PURCHASED BY CONTRACTOR	AS	1		
0102 1	MAINTENANCE OF TRAFFIC		LS	1	0639 1610	ELECTRICAL POWER SERVIC	· ·	AS	1		
0102104		D MAINTENANCE, INTERSECTION	ED	2120	0639 2 1	ELECTRICAL SERVICE WIRE		LF	105		
0102107 1		ON AND MAINTENANCE, INTERSECTION	ED	2120	0639 3 11 0641 2 11	BRESTRESSED CONCRETE	ONNECT, F&I, POLE MOUNI  POLE, F&I, TYPE P-II PEDESTAL	EA EA	1 2		
0104 10 3	SEDIMENT BARRIER INLET PROTECTION SYSTEM		LF EA	100	0641 2 11		POLE, F&I, TYPE P-II FEDESTAL  POLE, F&I, TYPE P-II SERVICE POLE	EA	1		
0110 1 1	CLEARING & GRUBBING		AC	0.824	0641 2 70		POLE, SHALLOW POLE REMOVAL- POLE 30' AND GREATER	EA	2		
0110 4 10	REMOVAL OF EXISTING CONCRE	TF	SY	2950	0646 1 11	ALUMINUM SIGNALS POLE, F	PEDESTAL	EA	15		
0120 1	REGULAR EXCAVATION		CY	500.5	0646 1 60	ALUMINUM SIGNALS POLE, F		EA	5		
0285709	OPTIONAL BASE, BASE GROUP C	99	SY	1090	0649 21 12		LY, FURNISH AND INSTALL, DOUBLE ARM 60'-40'	EA	2		
0327 70 7	MILLING EXIST ASPH PAVT, 4"	AVG DEPTH	SY	8541	0650 1 14 0650 1 16		AL, FURNISH & INSTALL ALUMINUM, 3 SECTION, 1 WAY AL, FURNISH & INSTALL ALUMINUM, 4 SECTION, 1 WAY	AS AS	8		
0334 1 53	SUPERPAVE ASPHALTIC CONCR	ETE, TRAFFIC C, PG76-22	TN	89.9			ARIES, REPAIR/REPLACE/RETROFIT- FURNISH & INSTALL,		<del>                                     </del>		
0337 7 83		COURSE,TRAFFIC C, FC-12.5, PG 76-22	TN	794.4	0650 2102	BACKPLATE- BLACK WITH F	REFLECT BORDER	EA	7		
0350 3 5	PLAIN CEMENT CONCRETE PAVE	EMENT, 8"	SY	566	0653 1 11	· ·	IISH & INSTALL LED COUNTDOWN, 1 WAY	AS	12		
4.07	REMEDIATION		LS	1	0653 1 12		IISH & INSTALL LED COUNTDOWN, 2 WAYS  OVE PED SIGNAL- POLE/PEDESTAL TO REMAIN	AS AS	3		
0425 2 61	MANHOLES, P-8, <10'		EA	9	0653 1 60		HING BEACON, FURNISH & INSTALL- SOLAR POWERED, COMPLETE	=			
0425 2 91	MANHOLES, J-8, <10'	ITV ~ 10'	EA	1 20	0654 2 22	SIGN ASSEMBLY- BACK TO	BACK	AS	6		
0425 3 91 0425 5 1	JUNCTION BOX, DRAINAGE, UTIL MANHOLE, ADJUST, UTILITIES	.111, \ 10	EA EA	28 11	0660 1103	LOOP DETECTOR INDUCTIVE		EA	4		
0425 6	VALVE BOXES, ADJUST		EA	17	0660 2101	LOOP ASSEMBLY- F&I, TYPE	E A EM- VIDEO. FURNISH & INSTALL CABINET EQUIPMENT	AS	4		
425.10	CITY OF TAMPA Type 1 INLET		EA	14	0660 4 11 0660 4 12		EM- VIDEO, FURNISH & INSTALL CABINET EQUIPMENT EM- VIDEO, FURNISH & INSTALL ABOVE GROUND EQUIPMENT	EA EA	4		
425.20	CITY OF TAMPA TYPE T DITCH	BOTTOM INLET	EA	36	0665 1 12		URNISH & INSTALL, ACCESSIBLE	EA	18		
425.30	CITY OF TAMPA TYPE E DITCH		EA	9	0665 1 60		EMOVE- POLE/PEDESTAL TO REMAIN	EA	5		
0430174112	PIPE CULVERT, OPTIONAL MATE	RIAL, ROUND, 12"SD	LF	4	0670 5110	TRAFFIC CONTROLLER ASSE	EMBLY, F&I, NEMA	AS	2		
0430174115	PIPE CULVERT, OPTIONAL MATE	RIAL, ROUND, 15"SD	LF	279	0670 5600		EMBLY, REMOVE CONTROLLER WITH CABINET	AS	2		
0430174118	PIPE CULVERT, OPTIONAL MATE	RIAL, ROUND, 18"SD	LF	112	0685 1 13	UNINTERRUPTIBLE POWER : CABINET	SUPPLY, FURNISH AND INSTALL, LINE INTERACTIVE WITH	EA	2		
0520 1 10	CONCRETE CURB & GUTTER, TY.	PE F	LF	4568	0700 3201		NSTALL OVERHEAD MOUNT, UP TO 12 SF	EA	4		
0520 2 4	CONCRETE CURB, TYPE D		LF	353	0700 5 22	INTERNALLY ILLUMINATED S	SIGN, FURNISH & INSTALL, OVERHEAD MOUNT, 12-18 SF	EA	8		
0522 2	CONCRETE SIDEWALK AND DRIV		SY	1036							
0522 2		VEWAYS, 6" THICK (SCORING PATTERNED)	SY	3643	TEN WINDER		SUMMARY OF LANDSCAPING		Laurenty tata		
0523 1 0527 2	PATTERNED PAVEMENT, VEHICO DETECTABLE WARNINGS	ULAK AKEAS	SY SF	209 241	ITEM NUMBER	DECYCLED DRICK BLOCK B	ITEM DESCRIPTION	UNIT	QUANTITY TOTAL		
0327 2	DETECTABLE WARNINGS		31	241	526-1.2 580-2.1.1	RECYCLED BRICK BLOCK-PA BALD CYPRESS 26' HT 10'		SF EA	810 13		
		SUMMARY OF SIGNING AND PAVEMENT MARKING			580-2.1.1	BALD CYPRESS 26' HT 10'		EA	13		
ITEM NUMBER		ITEM DESCRIPTION	UNIT	QUANTITY TOTAL	580-2.1.2	CHINESE FAN PALM-16' CT		EA	14		
0700 1 11	SINGLE POST SIGN, F&I GROUN	D MOUNT, UP TO 12 SF	AS	15	580-2.1.2.1	CHINESE FAN PALM-16' CT		EA	14		
0700 1 11	SINGLE POST SIGN, F&I GROUN	D MOUNT, UP TO 12 SF (HISTORIC SIGNS)	AS	1	580-2.1.3	IXORA 3 GALLON - FURNISH		EA	49		
0700 1 12	SINGLE POST SIGN, F&I GROUN		AS	4	580-2.4	PINE BARK MULCH		CY	2.4		
0700 1 12		D MOUNT, 12-20 SF (HISTORIC SIGNS)	AS	6	580-2.5	PREPARED PLANTING SOILS	S	CY	2.8		
0700 1 60	SINGLE POST SIGN, REMOVE		AS	26	580-3-1	STRUCTURED SOILS		CY	243		
0700 3501	SIGN PANEL, RELOCATE, UP TO		EA	1	580-3-2		ST IRON 72" SQ 16" DIA OPENING (PALMS)	EA	14		
0710 90	PAINTED PAVEMENT MARKINGS	•	LS	1	580-3-3		ST IRON 72" SQ ,36" DIA OPENING (TREES)	EA	13		
0711 11124 0711 11125		HITE, SOLID, 18" FOR DIAGONALS AND CHEVRONS HITE, SOLID, 24" FOR STOP LINE AND CROSSWALK	LF LF	220 229	580-3-4	TREE BRACING IN TREE WE		EA	27		
0711 11123	<u> </u>	HITE, 2-4 DOTTED GUIDELINE/ 6-10 GAP EXTENSION,		0.053	580-3-5	FABRIC WRAPPED STONE M	MAIT #5/ STUNE	EA	27		
0711 11141	THERMOPLASTIC, STANDARD, W		EA	0.033	580-3-6 580-3-7	TREE GRATE FRAME  TREE GUARD TYPE-E, FOR	26" DIA OPENING (TREES)	EA EA	27 13		
0711 11170	THERMOPLASTIC, STANDARD, W		EA	6	380-3-7	TREE GUARD TIFE-E, TOR	30 DIA OFENING (TREES)	LA	15		
0711 11224	· · · · · · · · · · · · · · · · · · ·	ELLOW, SOLID, 18" FOR DIAGONAL OR CHEVRON	LF	15			SUMMARY OF UTILITIES				
0711 14123		WHITE, SOLID, 12" FOR CROSSWALK	LF	1106	ITEM NUMBER		ITEM DESCRIPTION	UNIT	QUANTITY TOTAL		
0711 14125	THERMOPLASTIC, PREFORMED,	WHITE, SOLID, 24" FOR CROSSWALK	LF	811	1050 51202	UTILITY PIPE- DUCTILE IRC	ON/CAST IRON, FURNISH & INSTALL, WATER/SEWER, 2"	LF	16		
0711 14160	THERMOPLASTIC, PREFORMED,	WHITE, MESSAGE	EA	22	1050 51206		ON/CAST IRON, FURNISH & INSTALL, WATER/SEWER, 6"	LF	65		
0711 16101		HER SURFACES, WHITE, SOLID, 6"	GM	1.023	1050 51212	UTILITY PIPE- DUCTILE IRO	ON/CAST IRON, FURNISH & INSTALL, WATER/SEWER, 12"	LF	20		
0711 16201	THERMOPLASTIC, STANDARD-01	HER SURFACES, YELLOW, SOLID, 6"	GM	0.765	1055 51112	UTILITY FITTINGS, DUCTILE	E IRON/CAST IRON, FURNISH & INSTALL ELBOW, 12"	EA	4		
					1055 51412	UTILITY FITTINGS, DUCTILE	E IRON/CAST IRON, FURNISH & INSTALL UNION, 12"	EA	2		
		SUMMARY OF SIGNALIZATION			1080 23106		S SADDLE/SLEEVE, FURNISH & INSTALL, 6"	EA	1		
ITEM NUMBER		ITEM DESCRIPTION	UNIT	QUANTITY TOTAL	1080 24106	· · · · · · · · · · · · · · · · · · ·	SSEMBLY, FURNISH AND INSTALL, 6"	EA	2		
0630 2 11	CONDUIT, FURNISH & INSTALL,		LF	200	1080 27106		TOP ASSEMBLY, FURNISH AND INSTALL, 6"	EA	1		
0630 2 12	CONDUIT, FURNISH & INSTALL,		LF PI	525	1080 27112		OP ASSEMBLY, FURNISH AND INSTALL, 12"	EA	2		
0632 7 1	SIGNAL CABLE- NEW OR RECON	STRUCTED INTERSECTION, FURNISH & INSTALL	PI PI	2	1080 29106	<u>'</u>	ICAL JOINT RESTRAINT, FURNISH & INSTALL, 6"	EA	8		
0632 / 6	FIBER OPTIC CABLE, F&I, UNDE		LF	150	1080 29112	<u>'</u>	ICAL JOINT RESTRAINT, FURNISH & INSTALL, 12"	EA	10		
0633 1121	FIBER OPTIC CABLE, F&I, UNDE		EA	130	1644113 08 1644900		DARD, 2 HOSE, 1PUMPER, 6"	EA EA	1		
0033 2 32	· · · · · · · · · · · · · · · · · · ·	CIONC			1044900	FIRE HYDRANT, REMOVE		<u> </u>	1		
DATE	DESCRIPTION		EFFREY SIEWERT, P.E. P.E. LICENSE NUMBER		/2722 A 3	CITY OF TAMPA	E A IT		SHEET		
	223.11.1.1011	7	AYRES ASSOCIATES			NSPORTATION DEPARTME		<i>ור או פוועודא</i> אור.	NO.		
			3875 HIDDEN RIVER PI FAMPA, FL 33637	KWY, SUITE 200	CITY PROJECT NO.	COUNTY FINAI	NCIAL PROJECT ID SUMMARY OF PAI	IIIEMS			
			CERTIFICATE OF AUTH	ORIZATION 4356	1001221	HILLSBOROUGH 43	36639-1-58-01		3		

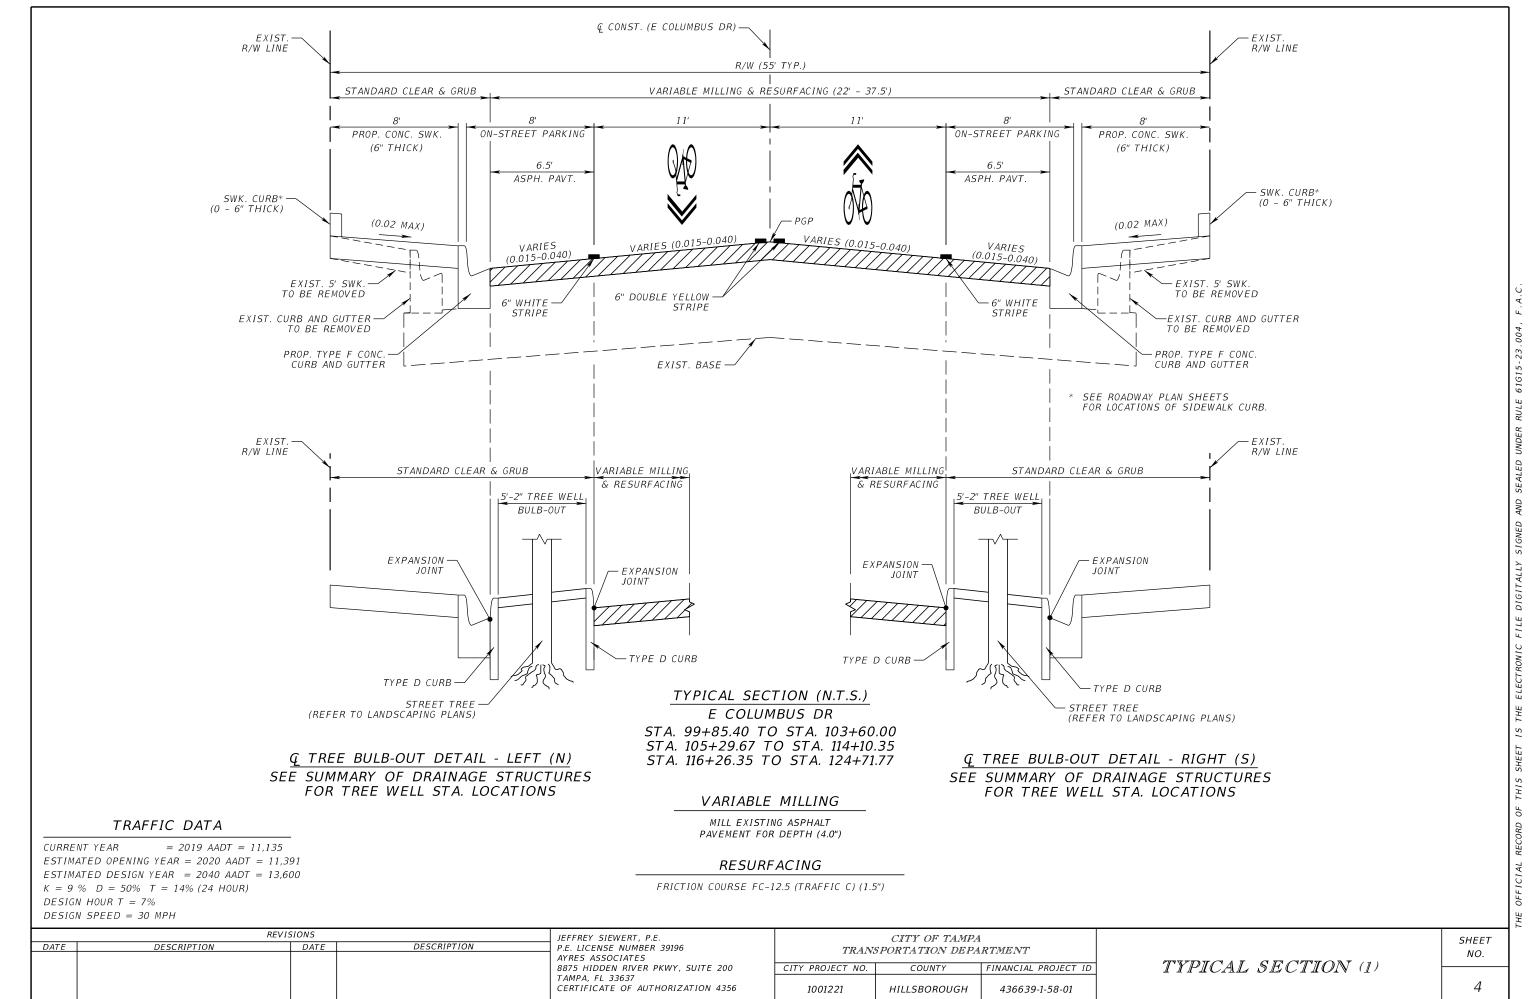

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\* SEE ROADWAY PLAN SHEETS FOR LOCATIONS OF SIDEWALK CURB.

# TYPICAL SECTION (N.T.S.) E COLUMBUS DR STA. 103+60.00 TO STA. 105+29.67

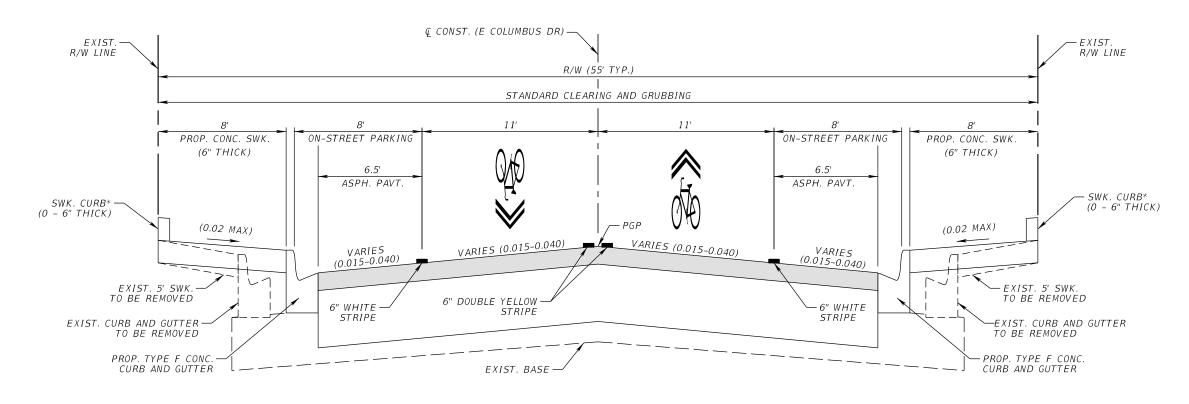STA. 114+10.35 TO STA. 116+26.35

### NEW CONSTRUCTION

OPTIONAL BASE GROUP 9 WITH
TYPE SP STRUCTURAL COURSE (TRAFFIC C) (1.5")
AND FRICTION COURSE FC-12.5 (TRAFFIC C) (1.5")

### TRAFFIC DATA

CURRENT YEAR = 2019 AADT = 11,135ESTIMATED OPENING YEAR = 2020 AADT = 11,391ESTIMATED DESIGN YEAR = 2040 AADT = 13,600 K = 9 % D = 50% T = 14% (24 HOUR)DESIGN HOUR T = 7%DESIGN SPEED = 30 MPH

					I				1		
	REVI	SIONS		JEFFREY SIEWERT, P.E.		CITY OF TAMPA	4		SHEET		
DATE	DESCRIPTION	DATE	DESCRIPTION	P.E. LICENSE NUMBER 39196 AYRES ASSOCIATES	TRAN	SPORTATION DEPA			NO.		
				8875 HIDDEN RIVER PKWY, SUITE 200 TAMPA, FL 33637 CERTIFICATE OF AUTHORIZATION 4356			CITY PROJECT NO.	COUNTY	FINANCIAL PROJECT ID	TYPICAL SECTION (2)	
					1001221	HILLSBOROUGH	436639-1-58-01		5		

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HILLSBOROUGH

436639-1-58-01

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1001221

CERTIFICATE OF AUTHORIZATION 4356

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BASED UPON: SIDEWALK SCORING ILLUSTRATION BACK OF SWK.-CITY OF TAMPA -SCORING PATTERN BEGINS AT INSIDE CORNER OF R/W HISTORIC PRESERVATION & URBAN DESIGN OCTOBER 31. 2009 4' SQ 4' SQ OUT LIMITS PLANS FOR WIDTH) SWK. σ 4' SQ 4' SQ  $\frac{X'}{2}$  SQ BULB (SEE  $\frac{X'}{2}$  SQ APPLY ADA REQUIREMENTS FOR CURB RAMPS -EDGE OF PAVT. BACK OF SWK.-BACK OF CURB -SCORING PATTERN BEGINS AT INSIDE CORNER OF R/W 3.5' SQ 3.5' SQ OUT LIMITS PLANS FOR WIDTH) SWK. 3.5' SQ 3.5' SQ  $\frac{X'}{2}$  SQ BULB (SEE <u>X'</u> SQ APPLY ADA REQUIREMENTS FOR CURB RAMPS NOTES: - SCORING PATTERN CONSISTENT FOR ENTIRE FACE BLOCK. - DO NOT PLACE SCORING PATTERN THROUGH DRIVEWAYS AND CURB RAMPS. EDGE OF PAVT. CONC. SWK. SCORING PATTERN DETAIL (N.T.S.) - PRIOR TO CONSTRUCTION, CONTACT THE EOR FOR REVIEWAL BACK OF CURB OF FINAL SCORING LAYOUT TO CLARIFY ANY AREAS IN QUESTION. REVISIONS JEFFREY SIEWERT, P.E. P.E. LICENSE NUMBER 39196 CITY OF TAMPA SHEET DESCRIPTION DATE DESCRIPTION DATE TRANSPORTATION DEPARTMENT NO. AYRES ASSOCIATES TYPICAL SECTION DETAILS 8875 HIDDEN RIVER PKWY, SUITE 200 CITY PROJECT NO. COUNTY FINANCIAL PROJECT ID TAMPA, FL 33637 CERTIFICATE OF AUTHORIZATION 4356 1001221 HILLSBOROUGH 436639-1-58-01

HEET IS THE ELECTRONIC FILE DIGITALLY SIGNED AND SEALED UNDER RULE 61G15-23.004, F.A.C.
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ELECTRONIC FILE DIGITALL
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THE OFFICIAL RECOR

STR	R. NO.	STATION	SIDE	DESCRIPTION		ORM DR. RCP MATERIA (CLASS II	L	CURB INLETS COT	FDOT MANHOLES	FDOT MANHOLES	DITCH BOTTOM INLETS COT	FDOT BOT (TREE WELLS)	CONCRETE JACKETS (INCLUDED IN PIPE COST)	REMARKS
ਰੋ					12"	RO 15"	UND 18"	TYPE 1 <10'	P-8 <10'	J-8 <10'	T E		EA	
P S	S-1	104+02.95	RT.	DIVERSION BOX	12	15	18	<10	<10	<10	1		EA	
P TV	<i>N</i> -1	104+08.16	RT.	TREE WELL								1		
F C	D-1	104+13.51	RT.	OUTLET BOX							1			
F S	S-2	104+13.78	LT.	DIVERSION BOX							1			
F TV	N-2	104+07.60	LT.	TREE WELL								1		
F S	S-5	104+39.38	RT.	TYPE 1 CURB INLET		4		1					1	COT TYPE 1 INLET WITH FDOT 2' DIA MH COVER ASSEMBLY, S.I. 425-001
F S	S-8	104+76.08	LT.	DIVERSION BOX							1			
F TV	N-8	104+82.16	LT.	TREE WELL								1		
F S	6-9	105+11.26	LT.	DIVERSION BOX							1			
F	N-9	105+17.42	LT.	TREE WELL								1		
F	-10	105+11.38	RT.	DIVERSION BOX							1			
F	V-10	105+16.67	RT.	TREE WELL								1		
F	-10	105+21.96	RT.	OUTLET BOX							1	,		
F	-11	106+26.57	RT.	DIVERSION BOX							1			
F	V-11	106+31.86	RT.	TREE WELL							I I	1		
F		106+37.16		OUTLET BOX							4	'		
F S	-11		RT.								1			
F	-12	106+38.59	LT.	DIVERSION BOX							1			
F	V-12	106+43.89	LT.	TREE WELL								1		
F	-12	106+49.18	LT.	OUTLET BOX							1			
F	-13	107+37.55	LT.	DIVERSION BOX							1			
F	V-13	107+42.84	LT.	TREE WELL								1		
P 0.	-13	107+48.14	LT.	OUTLET BOX		13					1			
P S- F	-14	107+37.89	RT.	DIVERSION BOX							1			
P TW	V-14	107+43.18	RT.	TREE WELL								1		
P 0.	-14	107+48.47	RT.	OUTLET BOX		34					1			
P S-	-17	107+68.28	RT.	DIVERSION BOX							1			
P TW	V-17	107+74.45	RT.	TREE WELL								1		
	-18	107+77.46	RT.	MANHOLE		13			1					FDOT MH TYPE P-8, S.I. 425-001,425-010
P S-	-22	108+14.06	LT.	MANHOLE										NOT USED
	22A	108+18.06	LT.	TYPE 1 CURB INLET		4		1					1	COT TYPE 1 INLET WITH FDOT 2' DIA MH COVER ASSEMBLY, S.I. 425-001
	-23	108+10.10	LT.	DIVERSION BOX								1		
P TW	V-23	108+03.94	LT.	TREE WELL								1		
F S-	-25	108+51.20	RT.	DIVERSION BOX							1			
F TW	V-25	108+45.91	RT.	TREE WELL								1		
F 0.	-25	108+40.62	RT.	OUTLET BOX			22				1			
F				Summ	ary: 0	68	22	2	1	0	14 4	13	2	

REVISIONS

DATE DESCRIPTION DATE DESCRIPTION

P.E. LICENSE NUMBER 52144

BES, INC.
11007 N. 56TH ST., SUITE 208
TEMPLE TERRACE, FL 33617
CERTIFICATE OF AUTHORIZATION 9835

CITY OF TAMPA
TRANSPORTATION DEPARTMENT

CITY PROJECT NO. COUNTY FINANCIAL PROJECT ID

1001221 HILLSBOROUGH 436639-1-58-01

SUMMARY OF DRAINAGE STRUCTURES

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STR. NO.	STATION	SIDE	DESCRIPTION		ORM DRA RCP MATERIAI CLASS II	L  )	CURB INLETS COT		FDOT MANHOLES	ВОТ	TCH TOM S COT	FDOT BOT (TREE WELLS)	CONCRETE JACKETS (INCLUDED IN PIPE COST)	REMARKS
				12"	ROI 15"	UND 18"	TYPE 1 <10'	P-8 <10'	J-8 <10'	T <10'	E <10'		EA	
S-26	108+80.94	LT.	DIVERSION BOX	12	,,,		1.0			1				
TW-26	108+75.64	LT.	TREE WELL									1		
O-26	108+70.35	LT.	OUTLET BOX		49					1				
S-27	110+18.72	LT.	DIVERSION BOX							1				
TW-27	110+13.43	LT.	TREE WELL									1		
O-27	110+08.14	LT.	OUTLET BOX							1				
S-28	110+81.51	RT.	DIVERSION BOX							1				
TW-28	110+76.22	RT.	TREE WELL									1		
O-28	110+70.93	RT.	OUTLET BOX							1				
S-29	111+17.68	LT.	TYPE 1 CURB INLET		4		1						1	COT TYPE 1 INLET WITH FDOT 2' DIA MH COVER ASSEMBLY, S.I. 425-0(
S-30	111+18.49	RT.	TYPE 1 CURB INLET		4		1						1	COT TYPE 1 INLET WITH FDOT 2' DIA MH COVER ASSEMBLY, S.I. 425-0(
S-31	113+14.61	LT.	DIVERSION BOX							1				
TW-31	113+09.32	LT.	TREE WELL									1		
O-31	113+04.03	LT.	OUTLET BOX							1				
S-32	113+34.16	RT.	DIVERSION BOX							1				
TW-32	113+28.87	RT.	TREE WELL							<u>'</u>		1		
	113+23.58	RT.								1		'		
0-32			OUTLET BOX							1				
S-33	114+21.64	LT.	DIVERSION BOX								1			
TW-33	114+97.29	LT.	TREE WELL									1	_	
S-33A	114+36.66	LT.	MANHOLE	4	4	4		1	1				2	
S-34	114+91.12	RT.	DIVERSION BOX								1			
TW-34	114+97.29	RT.	TREE WELL									1		
S-35	115+77.20	LT.	DIVERSION BOX								1			
TW-35	115+83.37	LT.	TREE WELL									1		
S-36	117+26.06	LT.	DIVERSION BOX							1				
TW-36	117+31.35	LT.	TREE WELL									1		
O-36	117+36.64	LT.	OUTLET BOX							1				
S-37	117+30.90	RT.	DIVERSION BOX							1				
TW-37	117+36.19	RT.	TREE WELL									1		
O-37	117+41.48	RT.	OUTLET BOX							1				
S-38	119+21.70	LT.	DIVERSION BOX							1				
TW-38	119+27.07	LT.	TREE WELL									1		
O-38	119+32.29	LT.	OUTLET BOX			4				1			1	
S-39	119+29.63	LT.	MANHOLE											NOT USED
			Summ	nary: 4	61	8	2	1	1	16	3	11	5	

	REV I.	THOMAS J. WARD, P.E.		
DATE	DESCRIPTION	P.E. LICENSE NUMBER 52144		
				BES, INC.
				11007 N. 56TH ST., SUITE 208
				TEMPLE TERRACE, FL 33617
				CERTIFICATE OF AUTHORIZATION 983

CITY OF TAMPA TRANSPORTATION DEPARTMENT						
CITY PROJECT NO.	FINANCIAL PROJECT ID					
1001221	HILLSBOROUGH	436639-1-58-01				


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STR.	NO.	STATION	SIDE	DESCRIPTION	r	ORM DRA RCP MATERIA (CLASS II	L	CURB INLETS COT	FDOT MANHOLES	FDOT MANHOLES	DITCH BOTTOM INLETS COT	FDOT BOT (TREE WELLS)	CONCRETE JACKETS (INCLUDED IN PIPE COST)	REMARKS
P S-4	40	440.40.44	DT	TVDS D DDI	12"	15"	18"	<10'	<10'	<10'	<10' <10'		EA	
F		119+16.41	RT.	TYPE D DBI			26				1			
P S-4 F		119+44.50	RT.	MANHOLE			8		1				2	FDOT MH TYPE P-8, S.I. 425-001,425-010
P S-4 F	14	119+87.95	LT.	MANHOLE		4			1				1	FDOT MH TYPE P-8, S.I. 425-001,425-010
P S-44	4A	119+90.62	LT.	TYPE 1 CURB INLET		4		1					1	COT TYPE 1 INLET WITH FDOT 2' DIA MH COVER ASSEMBLY, S.I. 425-001
P S-4	15	120+40.21	LT.	DIVERSION BOX							1			
P TW-	-45	120+04.74	LT.	TREE WELL								1		
P S-4	16	120+02.84	RT.	MANHOLE			4		1				1	FDOT MH TYPE P-8, S.I. 425-001,425-010
P S-4	17	120+40.21	RT.	DIVERSION BOX							1			
P TW-	-47	120+34.92	RT.	TREE WELL								1		
P 0-4	47	120+29.63	RT.	OUTLET BOX			25				1			
P S-4	18	120+50.07	LT.	TYPE 1 CURB INLET		79		1						COT TYPE 1 INLET WITH FDOT 2' DIA MH COVER ASSEMBLY, S.I. 425-001
P S-4	19	121+26.13	RT.	DIVERSION BOX							1			
P TW-	-49	121+20.84	RT.	TREE WELL								1		
F 0-4	49	121+15.55	RT.	OUTLET BOX							1			
F S-5	50	121+81.75	LT.	DIVERSION BOX							1			
P TW-	-50	121+76.46	LT.	TREE WELL								1		
F O-5	50	121+71.17	LT.	OUTLET BOX							1			
F S-3	3	200+29.48	LT.	MANHOLE		4			1				1	FDOT MH TYPE P-8, S.I. 425-001,425-010
F S-7	7	200+30.60	RT.	MANHOLE		4			1				1	FDOT MH TYPE P-8, S.I. 425-001,425-010
P S-6	6	200+40.22	RT.	TYPE 1 CURB INLET		8		1						COT TYPE 1 INLET WITH FDOT 2' DIA MH COVER ASSEMBLY, S.I. 425-001
P S-4	4	200+40.27	LT	TYPE 1 CURB INLET		8		1						
P S-1	15	300+28.43	LT.	MANHOLE		4			1				1	FDOT MH TYPE P-8, S.I. 425-001,425-010
P S-2	20	300+30.05	RT.	MANHOLE		4			1				1	FDOT MH TYPE P-8, S.I. 425-001,425-010
P S-1	19	300+35.72	RT.	TYPE 1 CURB INLET		5		1						COT TYPE 1 INLET WITH FDOT 2' DIA MH COVER ASSEMBLY, S.I. 425-001
F S-1	16	300+36.35	LT.	TYPE 1 CURB INLET		6		1						COT TYPE 1 INLET WITH FDOT 2' DIA MH COVER ASSEMBLY, S.I. 425-001
F S-2	24	400+35.96	RT.	TYPE 1 CURB INLET			4	1					1	COT TYPE 1 INLET WITH FDOT 2' DIA MH COVER ASSEMBLY, S.I. 425-001
P S-2	21	400+36.66	LT.	TYPE 1 CURB INLET		4		1					1	COT TYPE 1 INLET WITH FDOT 2' DIA MH COVER ASSEMBLY, S.I. 425-001
P S-4	11	700+34.87	LT.	TYPE 1 CURB INLET			15	1						COT TYPE 1 INLET WITH FDOT 2' DIA MH COVER ASSEMBLY, S.I. 425-001
F S-4	13	700+35.07	RT.	TYPE 1 CURB INLET		16		1						COT TYPE 1 INLET WITH FDOT 2' DIA MH COVER ASSEMBLY, S.I. 425-001
P														
P														
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<u> </u>			<u> </u>	I Summary GRAND TOTAL		150 279	82 112	10	7 9	0	6 2 36 9	4 28	11 18	

		THOMAS J. WARD, P.E.		
DATE	DESCRIPTION	DATE	DESCRIPTION	P.E. LICENSE NUMBER 52144 BES, INC. 11007 N. 56TH ST., SUITE 208 TEMPLE TERRACE, FL 33617
				CERTIFICATE OF AUTHORIZATION 9835

CITY OF TAMPA TRANSPORTATION DEPARTMENT					
ITY PROJECT NO.	COUNTY	FINANCIAL PROJECT ID			
1001221	HILLSBOROUGH	436639-1-58-01			

SUMMARY OF DRAINAGE STRUCTURES

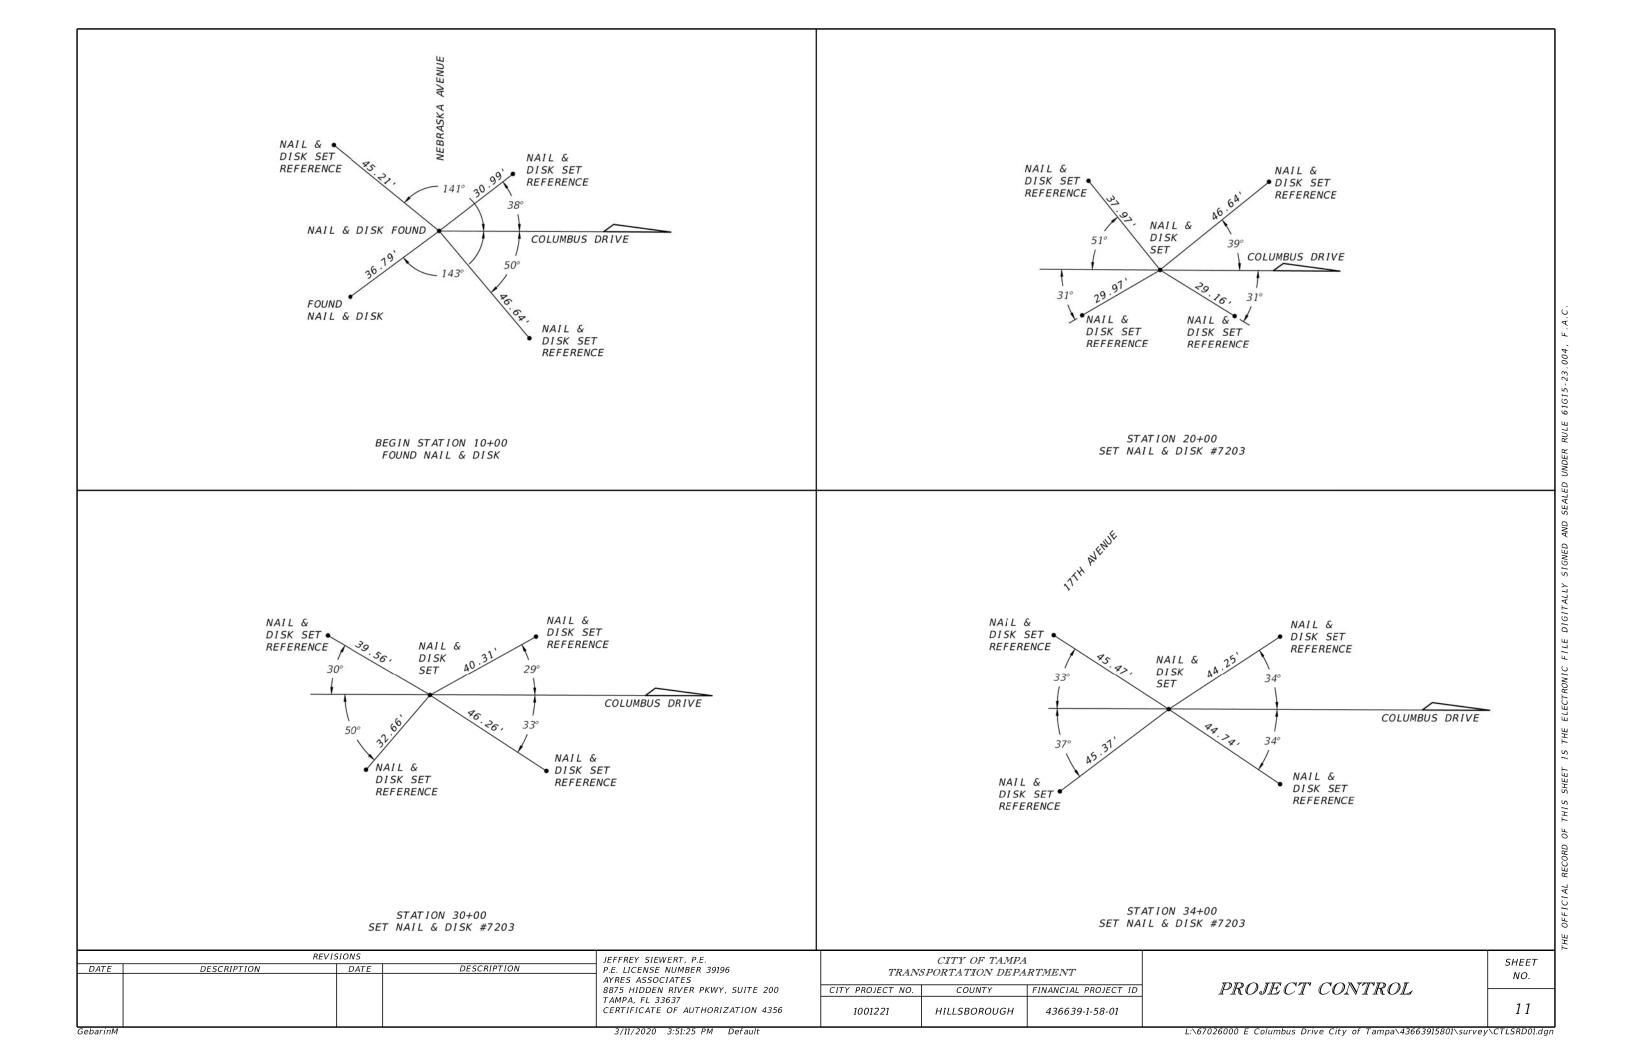

### GENERAL NOTES

#### ROADWAY

- BENCHMARK ELEVATIONS SHOWN ON THE PLANS ARE NORTH AMERICAN VERTICAL DATUM OF 1988 (NAVD 88).
- ALL SURVEY INFORMATION WAS OBTAINED FROM A LICENSED FLORIDA PROFESSIONAL SURVEYOR AND MAPPER AND UTILIZED AS SUPPORTING DATA IN THE PRODUCTION OF DESIGN PLANS AND FOR CONSTRUCTION ON E COLUMBUS DR FROM SR 45 (N NEBRASKA AVE) TO N 14TH ST. THE PROFESSIONAL SURVEYOR AND MAPPER OF RECORD IS:

RUSSELL P. HYATT, P.S.M. P.S.M. NO.: 5303 HYATT SURVEY SERVICES, INC. 2012 LENA RD, BRADENTON, FL 34211 CERTIFICATE OF AUTHORIZATION: 4213

- INFORMATION AND SUBSEQUENT LOCATION OF THE RIGHT OF WAY LINES INDICATED HEREIN WERE OBTAINED BY A REVIEW OF THE LAST DEED OF RECORD AVAILABLE PER HILLSBOROUGH COUNTY, FLORIDA CLERK OF THE CIRCUIT COURT WEBSITE TOGETHER WITH PERTINENT STATE ROAD DEPARTMENT MAPS AVAILABLE PER FDOT RIGHT OF WAY MAPPING WEBSITE TITLE WORK WAS NOT PROVIDED.
- LANE DIRECTION ARROWS ARE FOR INFORMATIONAL PURPOSES ONLY.

REVISIONS

DATE

DESCRIPTION

- ALL PARTIAL STATION CALL OUTS IN THE PLANS ARE BASED ON & CONST. (E COLUMBUS DR).
- REFER TO DRIVEWAY HALF-SECTIONS FOR DRIVEWAY WIDTHS AND TIE-DOWN LIMITS.
- RESOLUTION OF ANY CONTAMINATED OR HAZARDOUS MATERIALS INVOLVEMENT AT IDENTIFIED OR ENCOUNTERED AREAS BY THE CONTRACTOR WILL BE COORDINATED BY CITY OF TAMPA WITH THE APPROPRIATE REGULATORY AGENCIES. CITY OF TAMPA WILL UNDERTAKE, AT ITS OWN EXPENSE, ANY REMEDIAL ACTIONS NECESSARY TO ALLOW THE CONTRACTOR TO CONTINUE CONSTRUCTING THE PROJECT.

CERTAIN CONTAMINATED AREAS INCLUDE, BUT NOT LIMITED TO, THE FOLLOWING ADDRESSES:

- 2317 N NEBRASKA AVE - 1023 E COLUMBUS DR
- 1312 E COLUMBUS DR

#### DRAINAGE

- INFORMATION FOR THE EXISTING STORM DRAIN SYSTEM HAS BEEN PROVIDED ON ROADWAY PLAN SHEET (5).
- ALL GRATES & MANHOLE COVERS TO BE HEAVY DUTY, AND STEEL GRATES TO BE GALVANIZED, NOT PAINTED.

### <u>UTILITIES</u>

INFORMATION FOR THE EXISTING SANITARY SYSTEM HAS BEEN PROVIDED ON UTILITY ADJUSTMENT SHEET (5).

DESCRIPTION

#### NOTES TO REVIEWERS

- ROADWAY PLAN SHEET LIMITS AND DIMENSIONS ALONG MATCHLINES ARE BASED UPON THE & OF SURVEY.
- ALL PROPOSED SIDEWALK WITHIN PROJECT LIMITS TO BE MAINTAINED BY HILLSBOROUGH COUNTY AFTER CONSTRUCTION. SIDEWALK THICKNESS SHALL BE 6" THICK PER COUNTY STANDARDS.

8875 HIDDEN RIVER PKWY, SUITE 200 CITY PROJECT NO. CERTIFICATE OF AUTHORIZATION 4356 1001221

CITY OF TAMPA TRANSPORTATION DEPARTMENT COUNTY FINANCIAL PROJECT ID HILLSBOROUGH 436639-1-58-01

GENERAL NOTES

SHEET NO.

12


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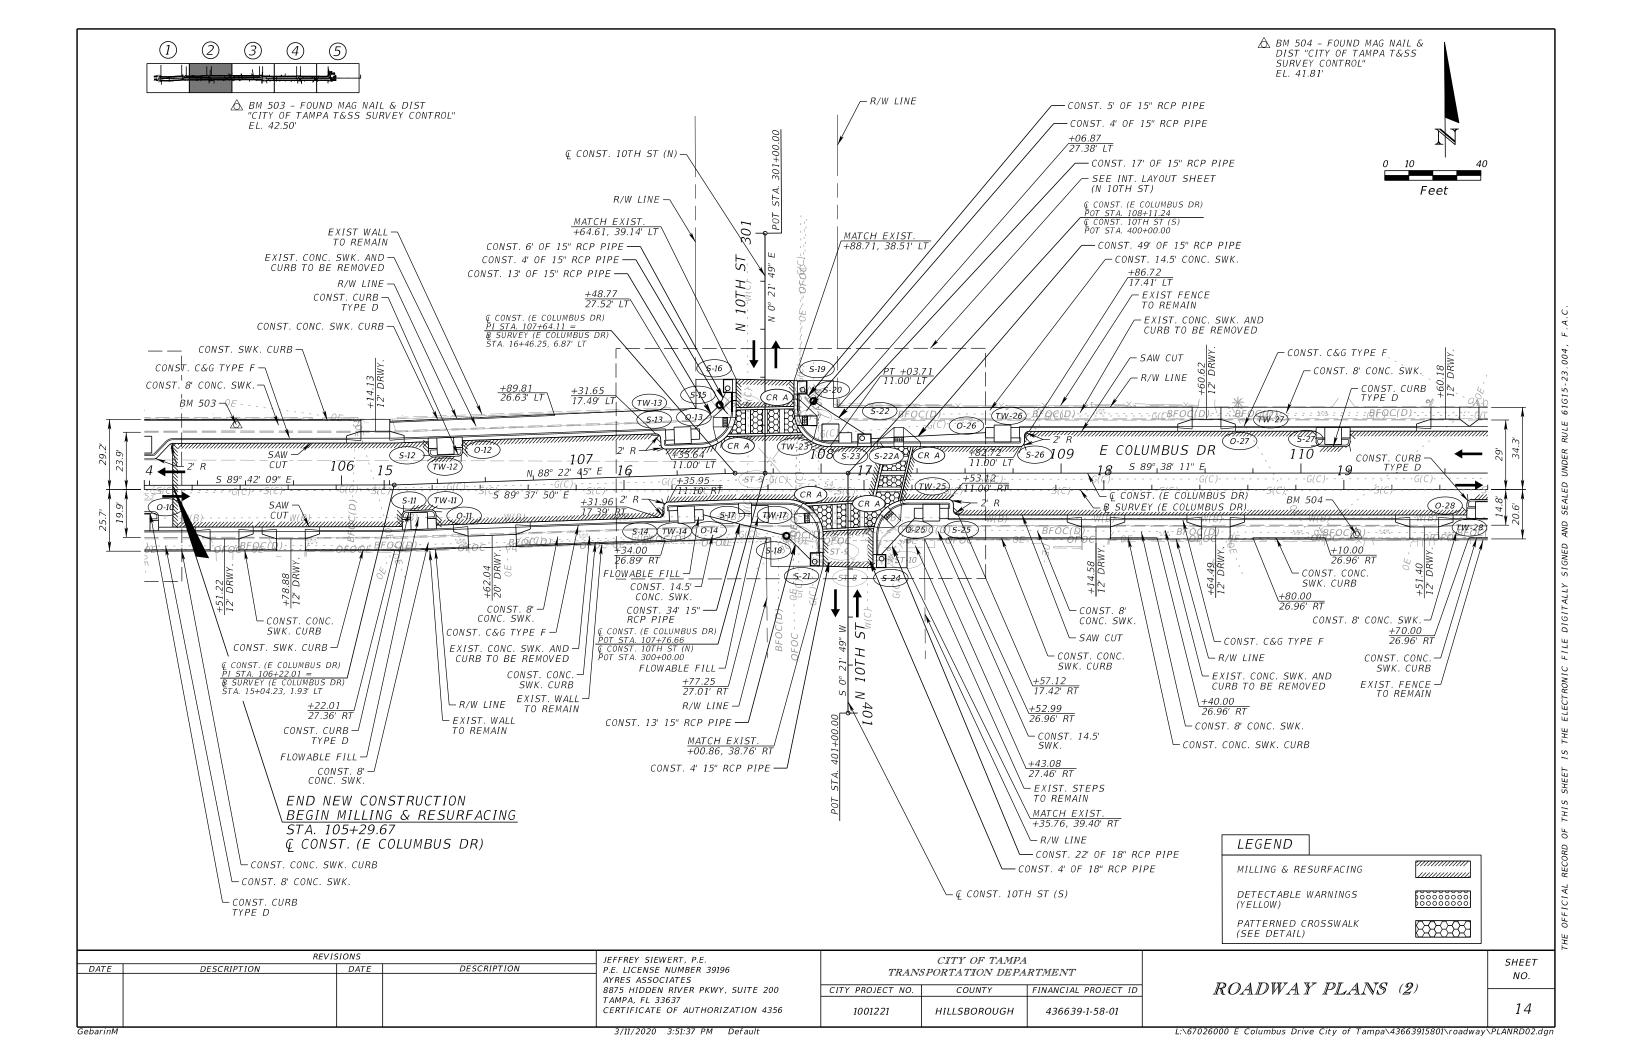
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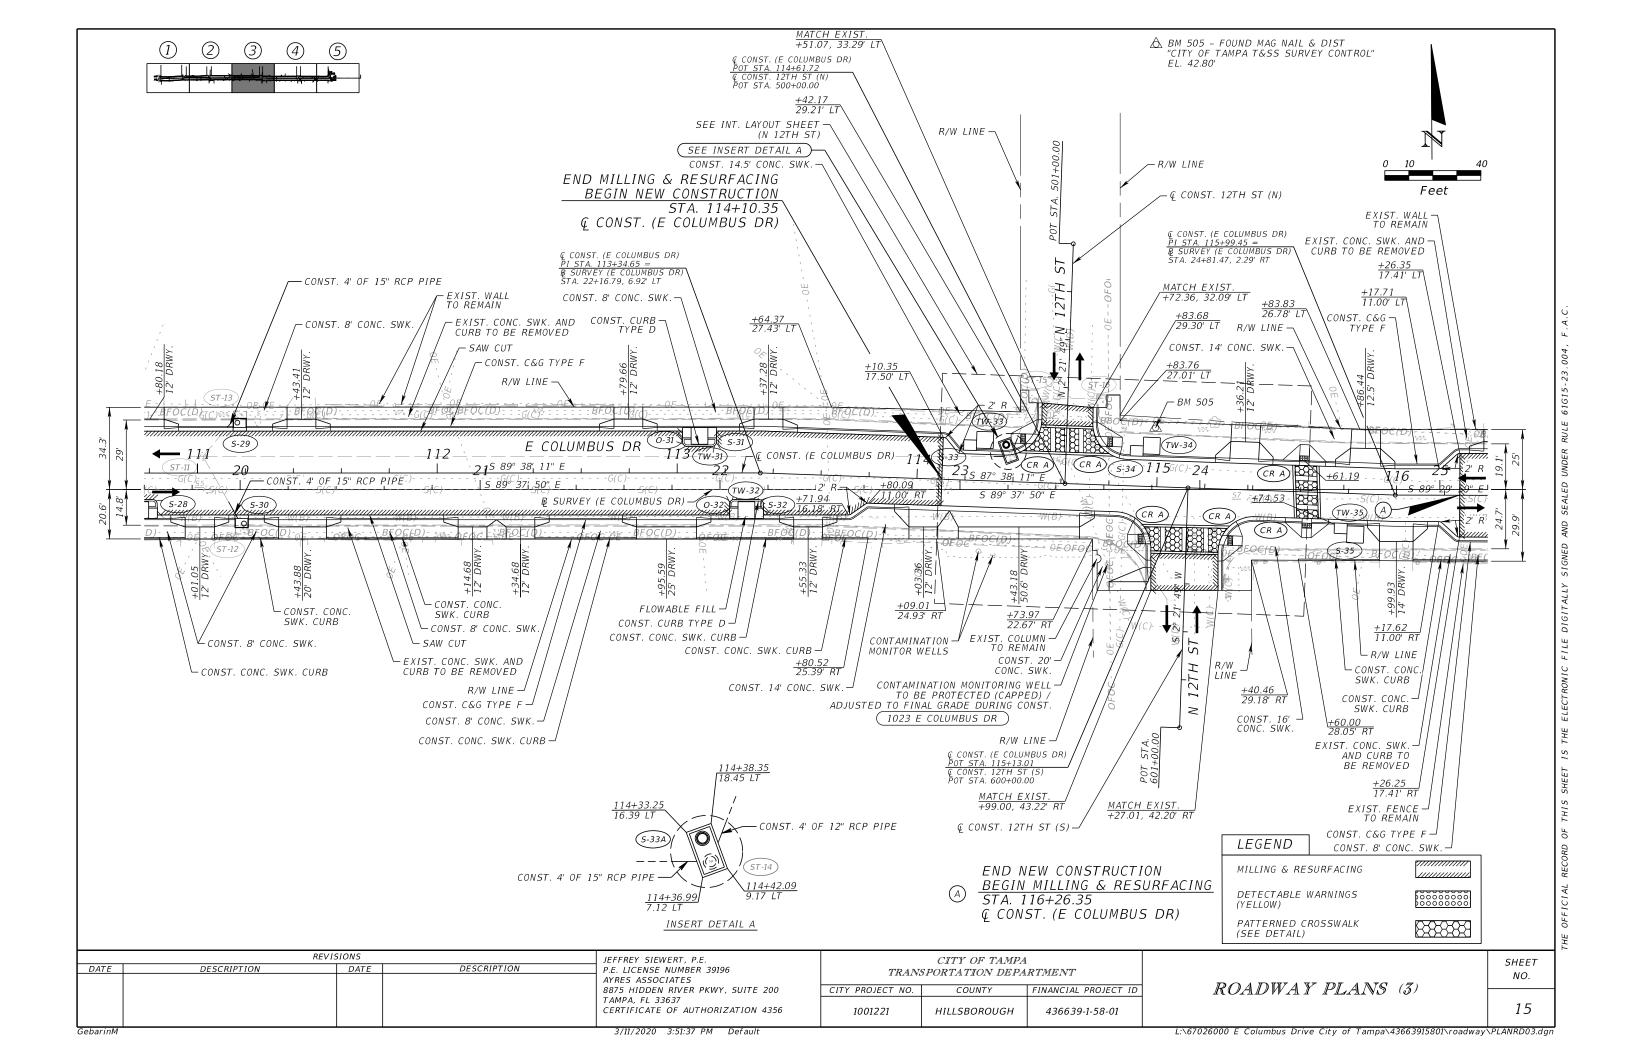
AYRES ASSOCIATES


TAMPA, FL 33637


P.E. LICENSE NUMBER 39196







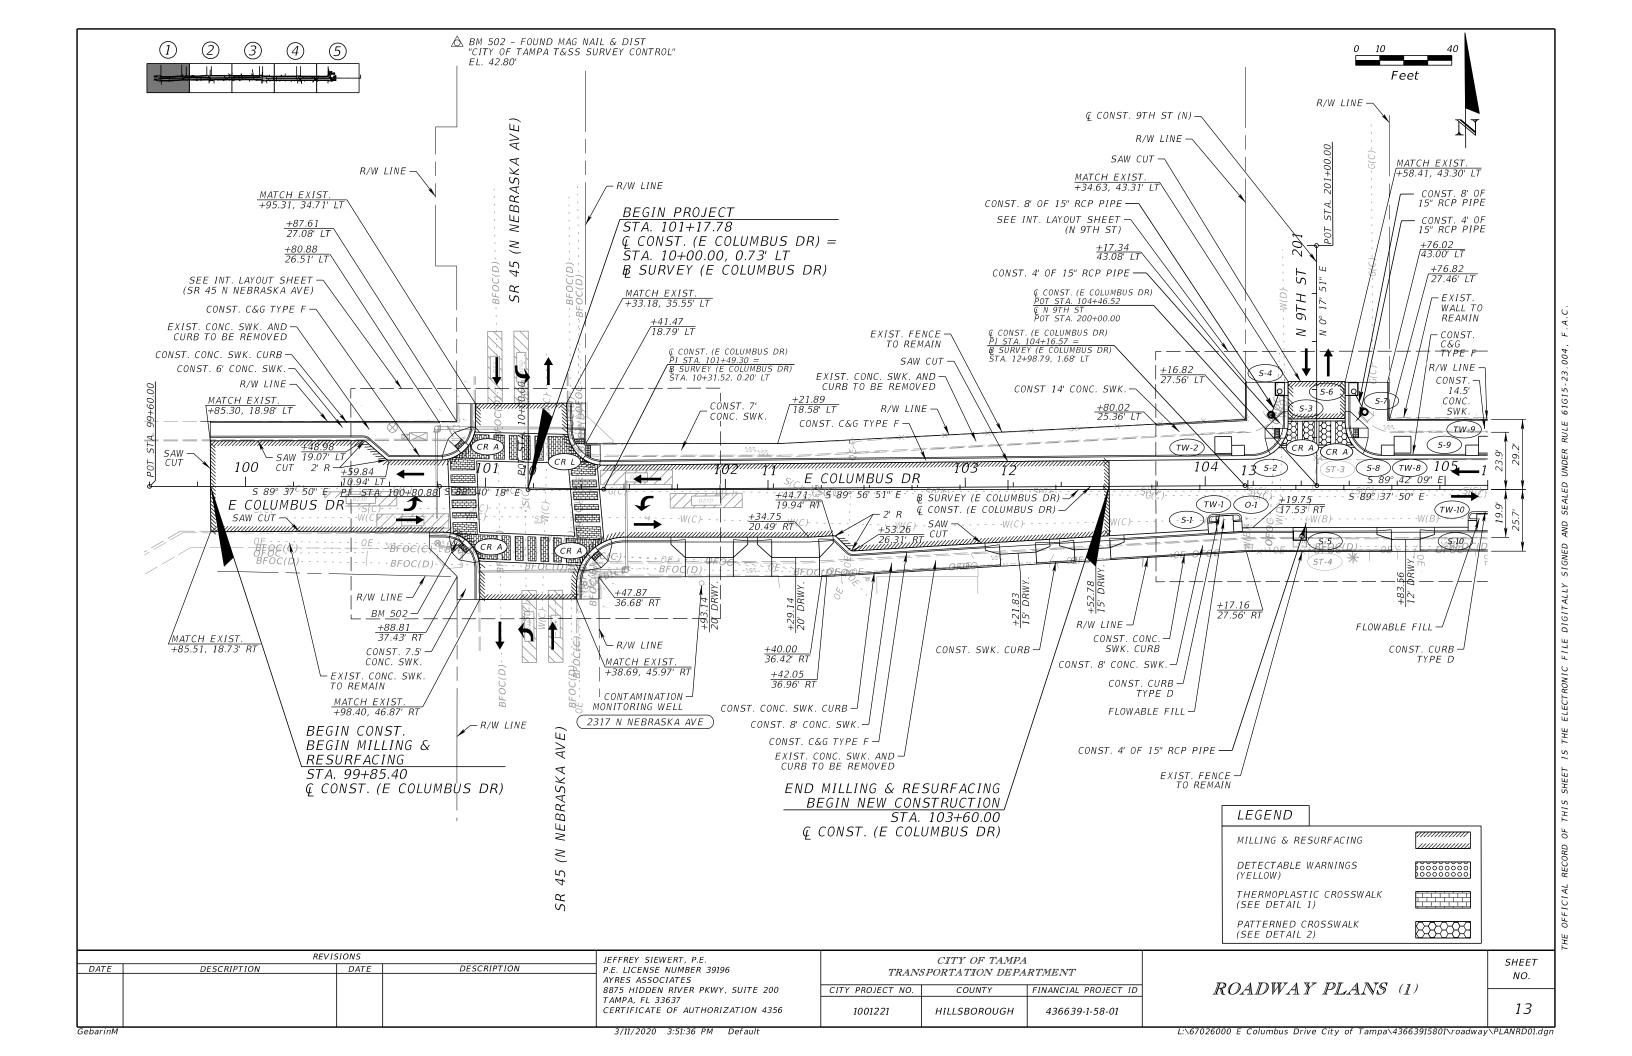


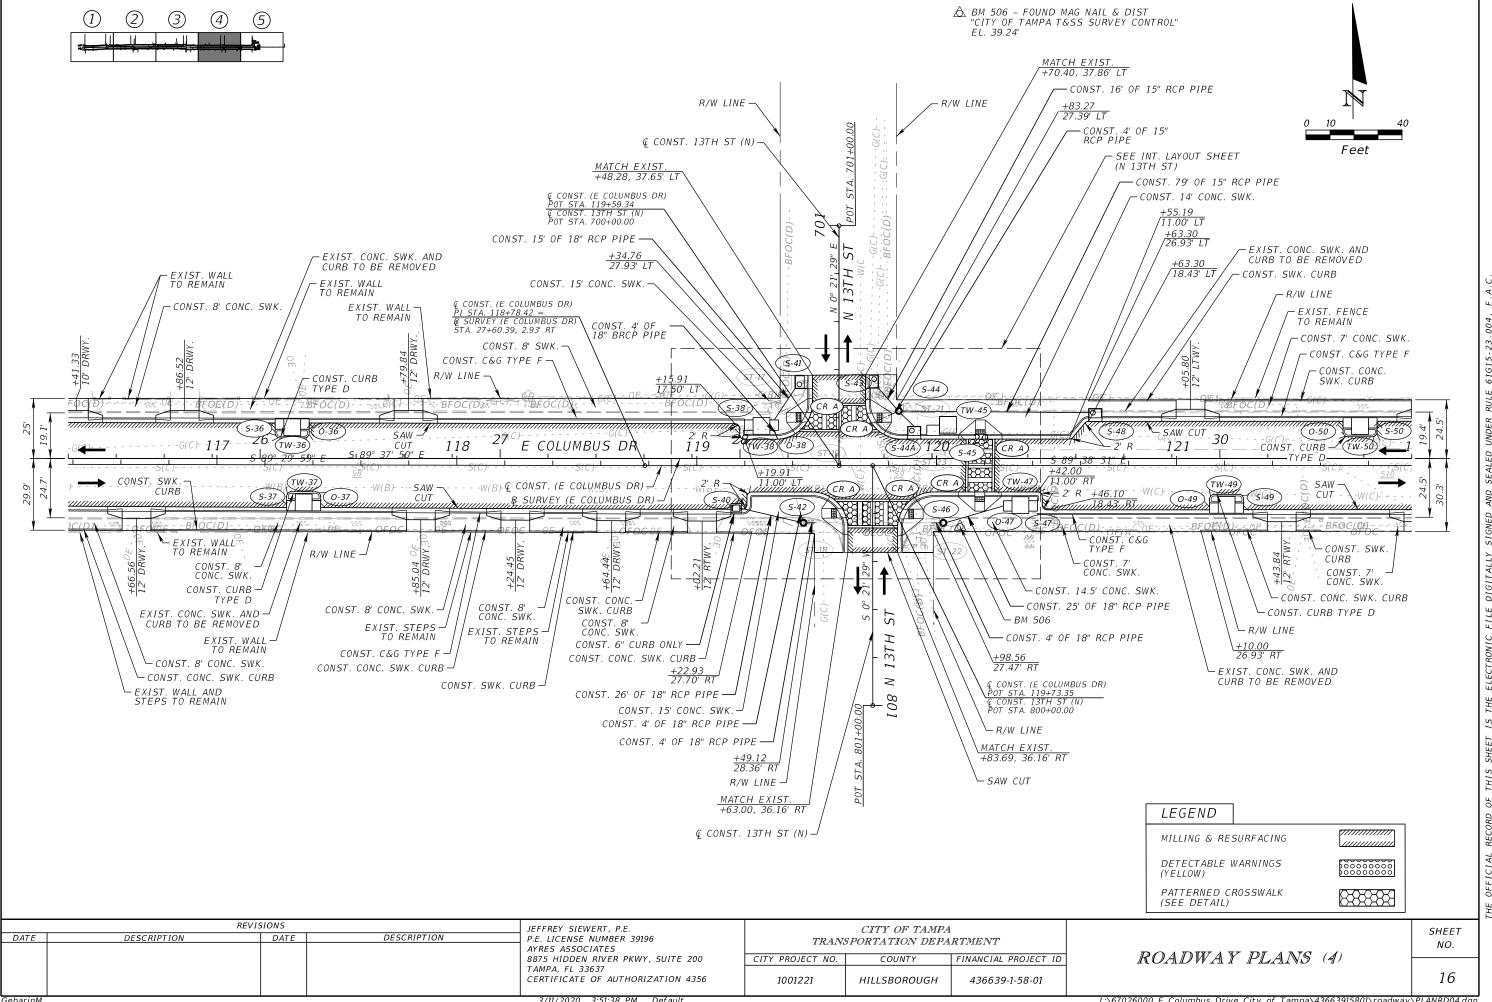


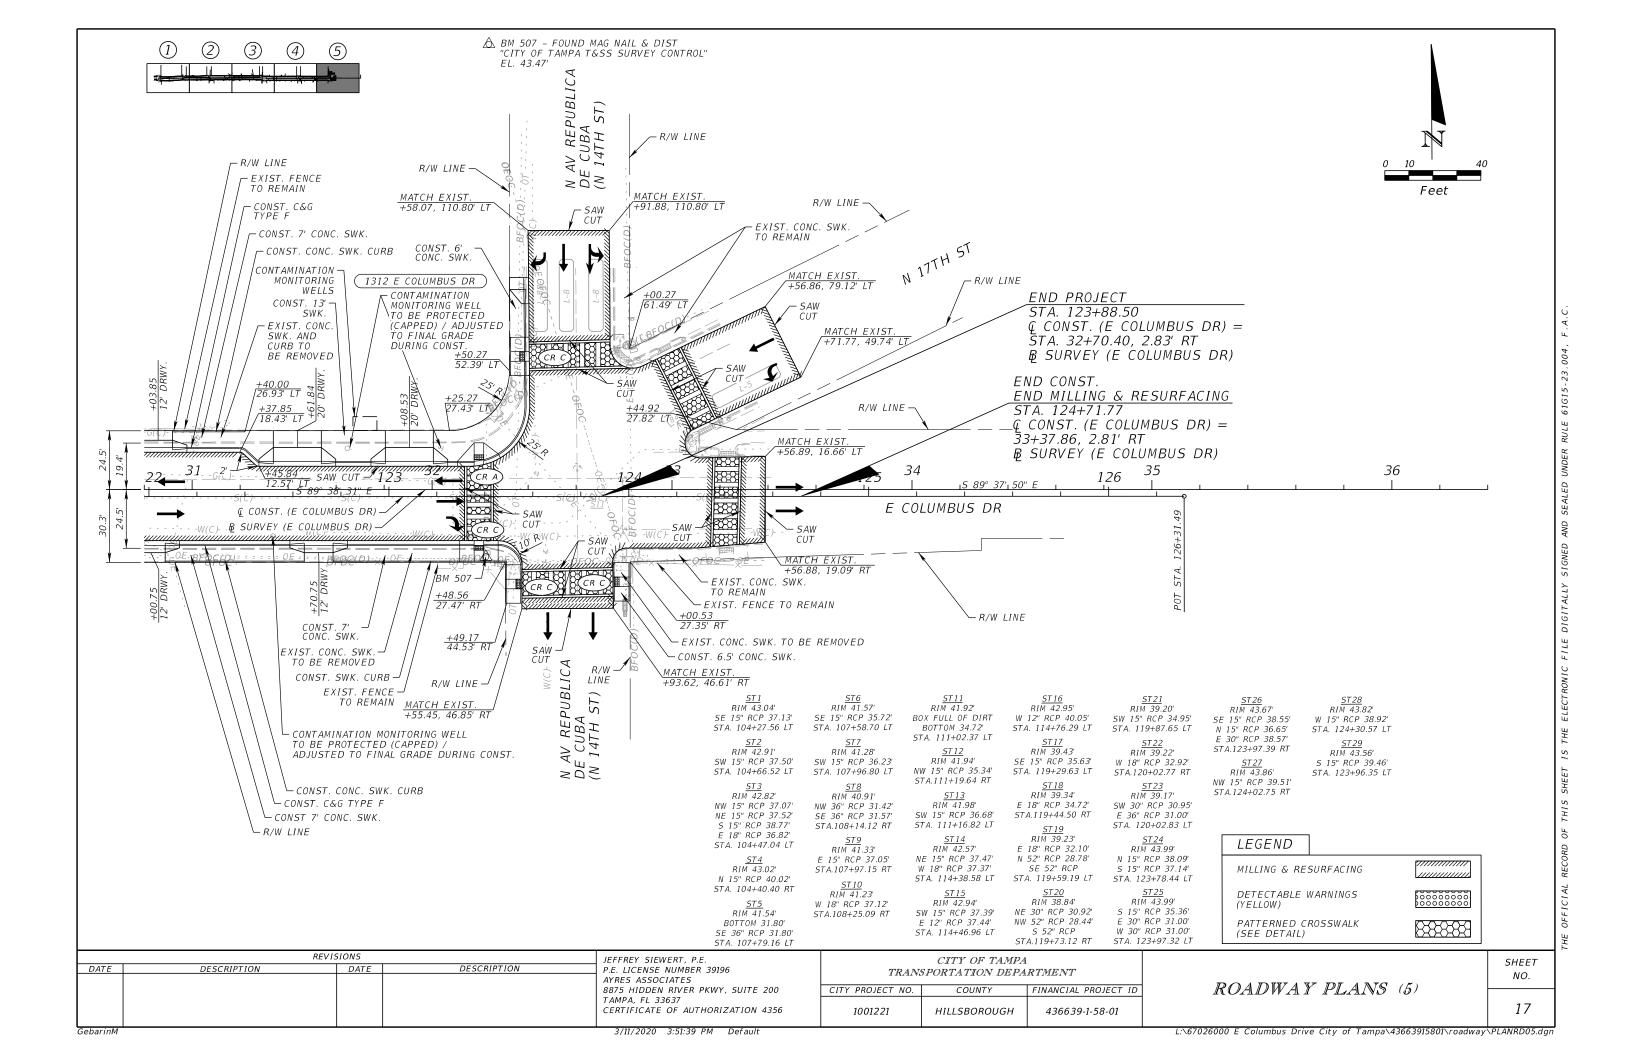


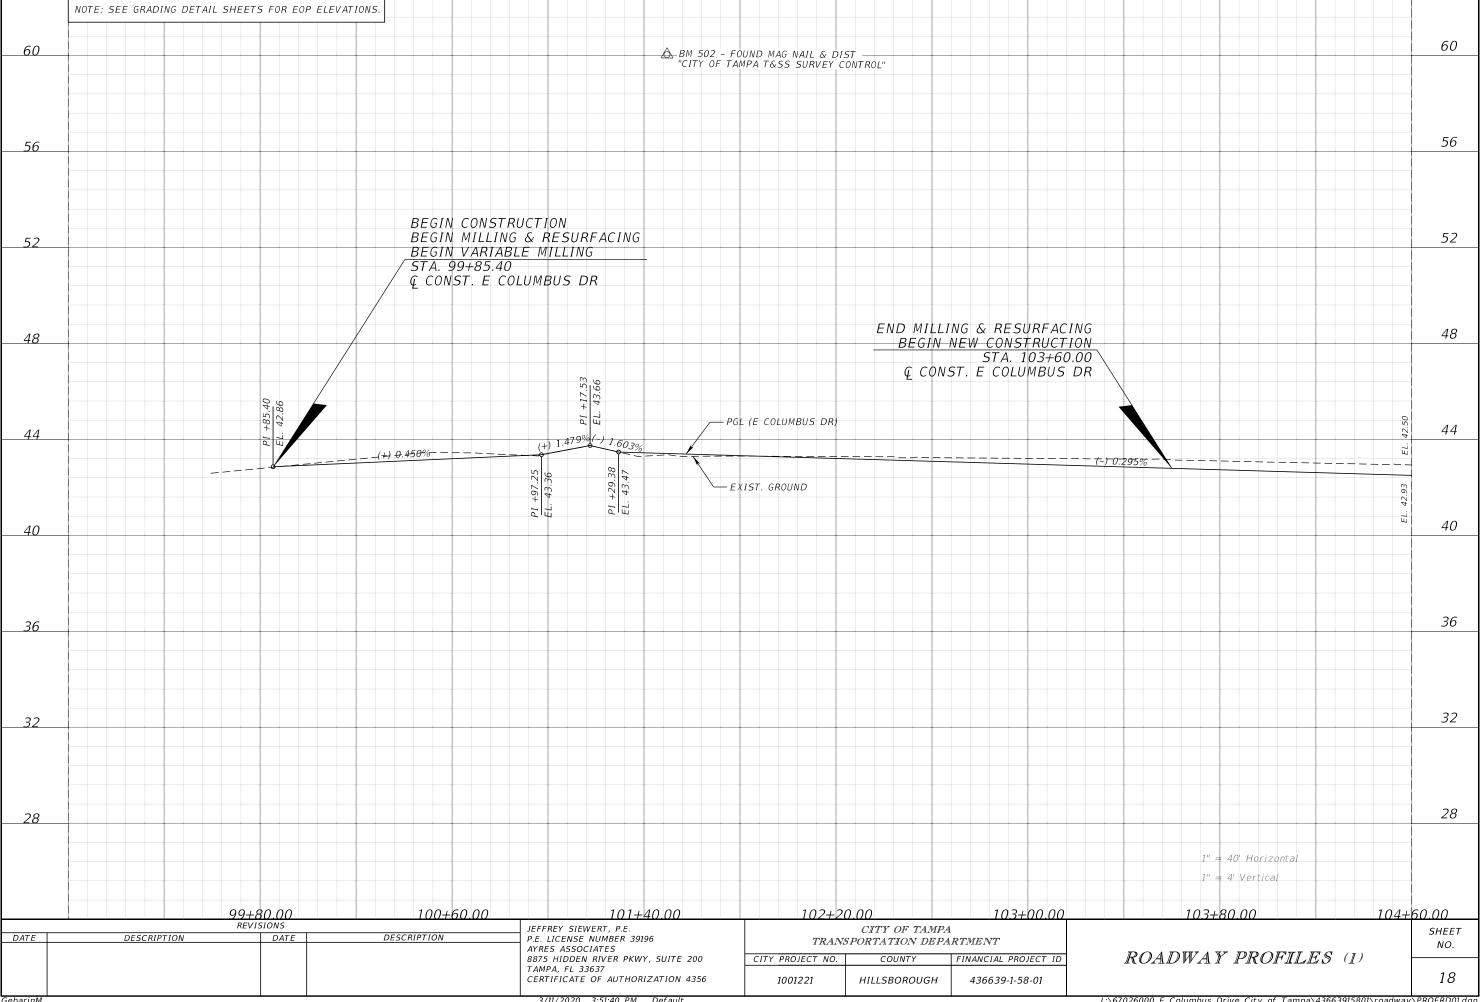


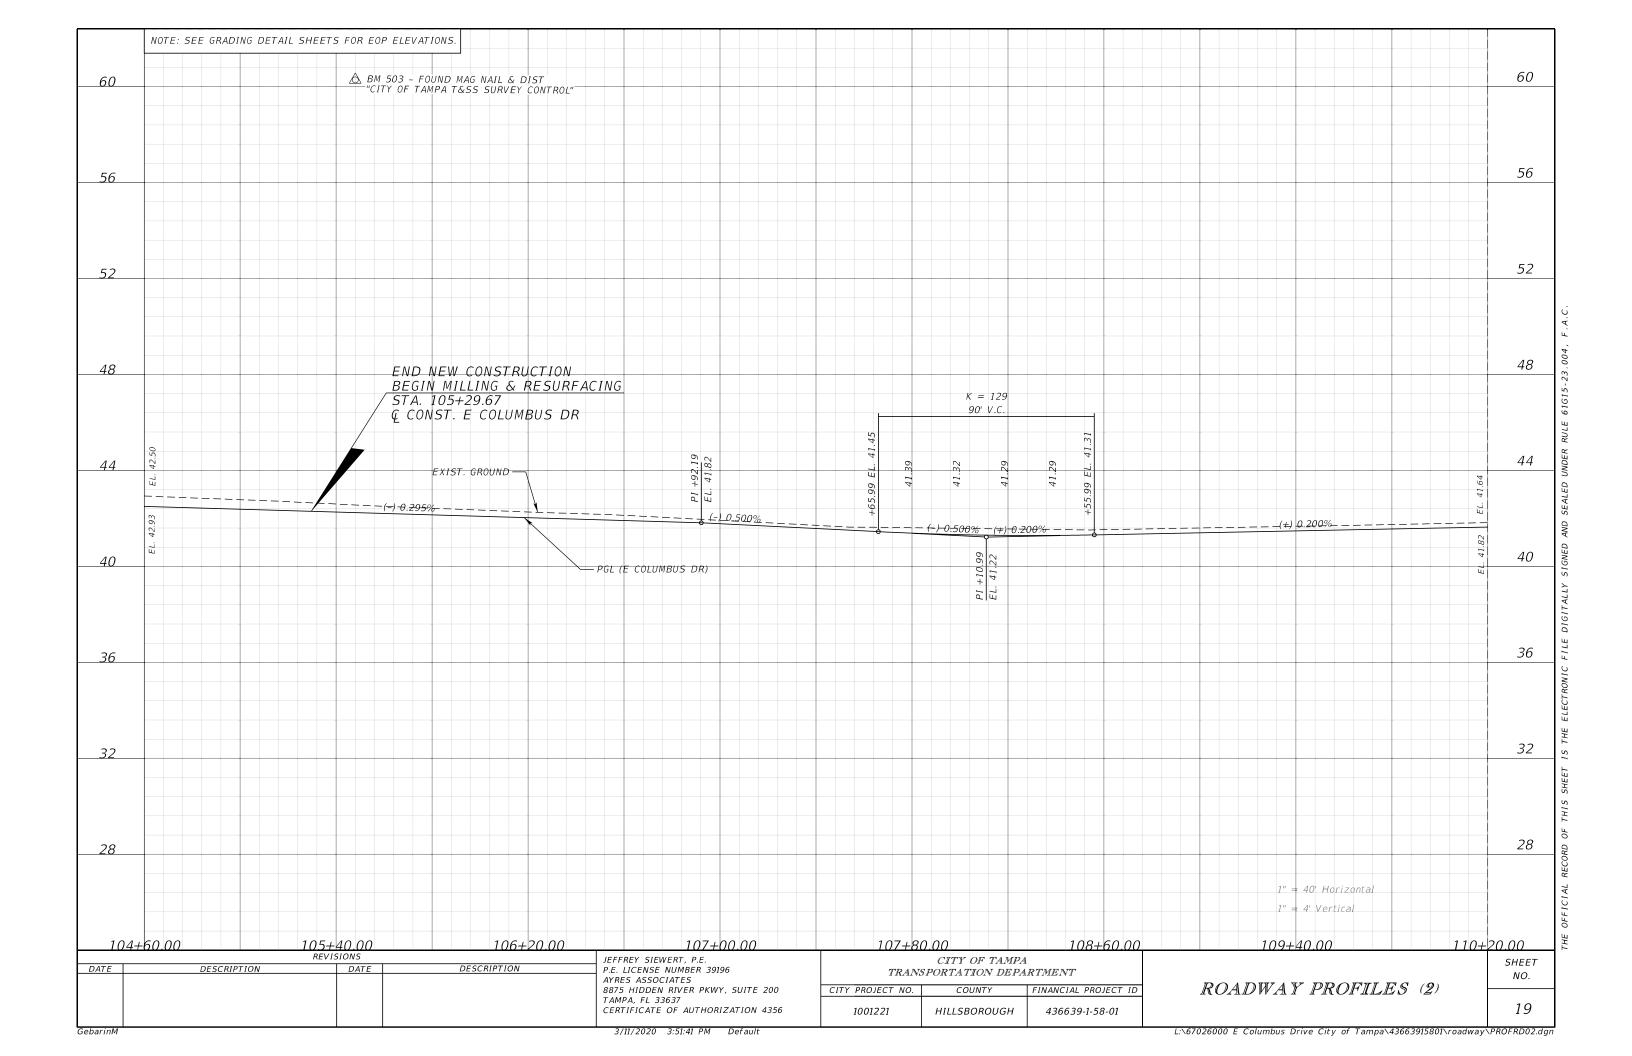


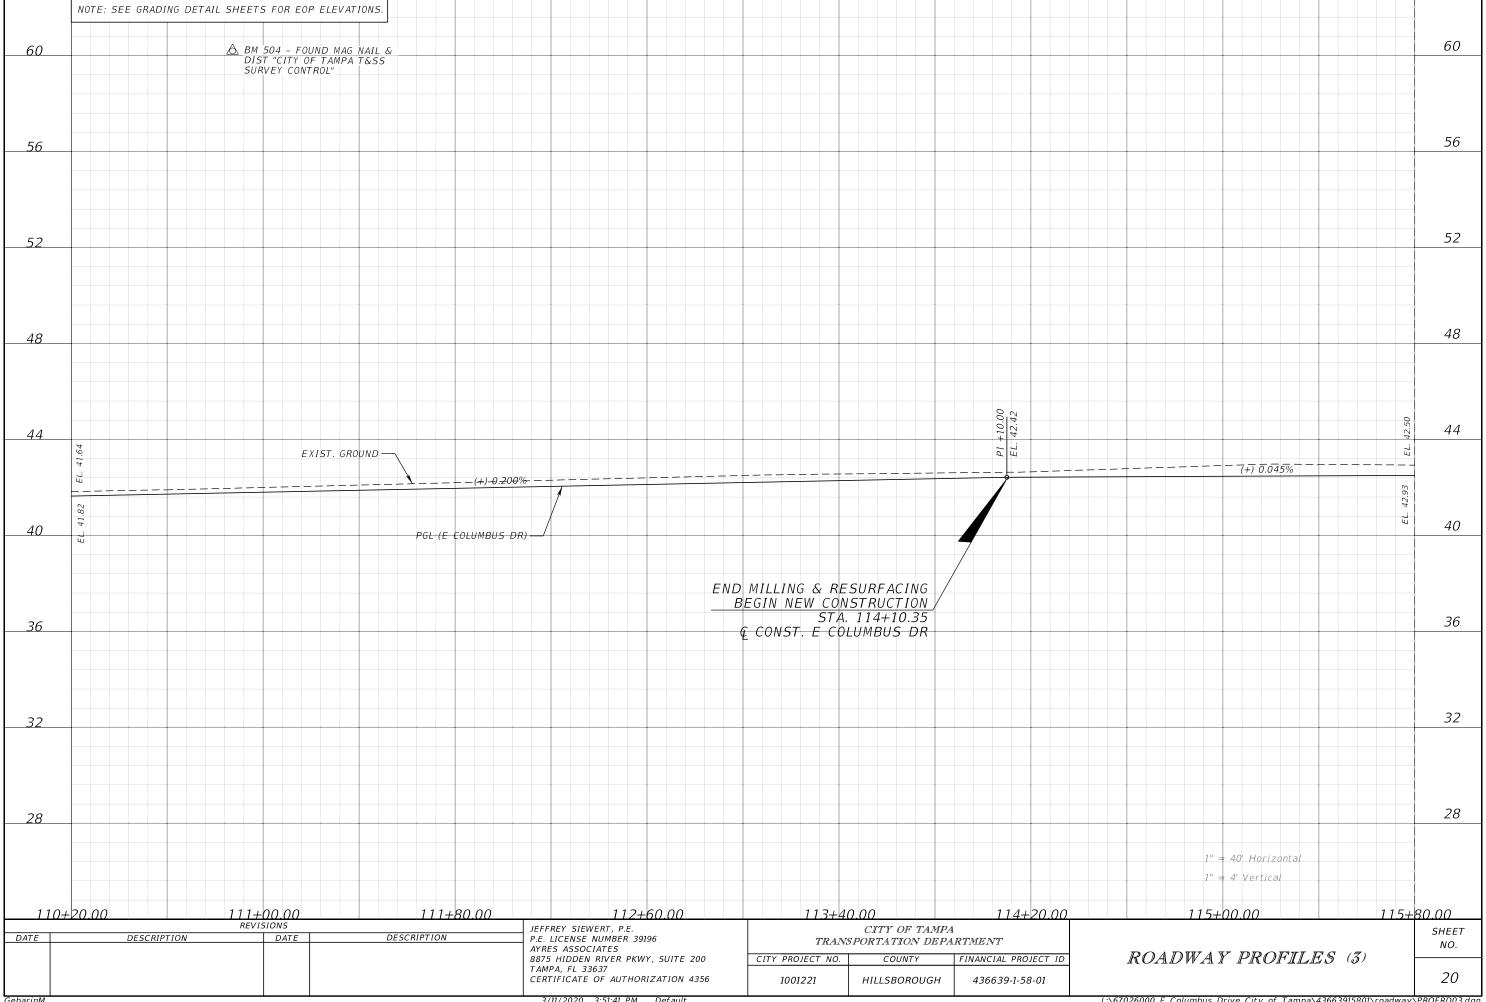


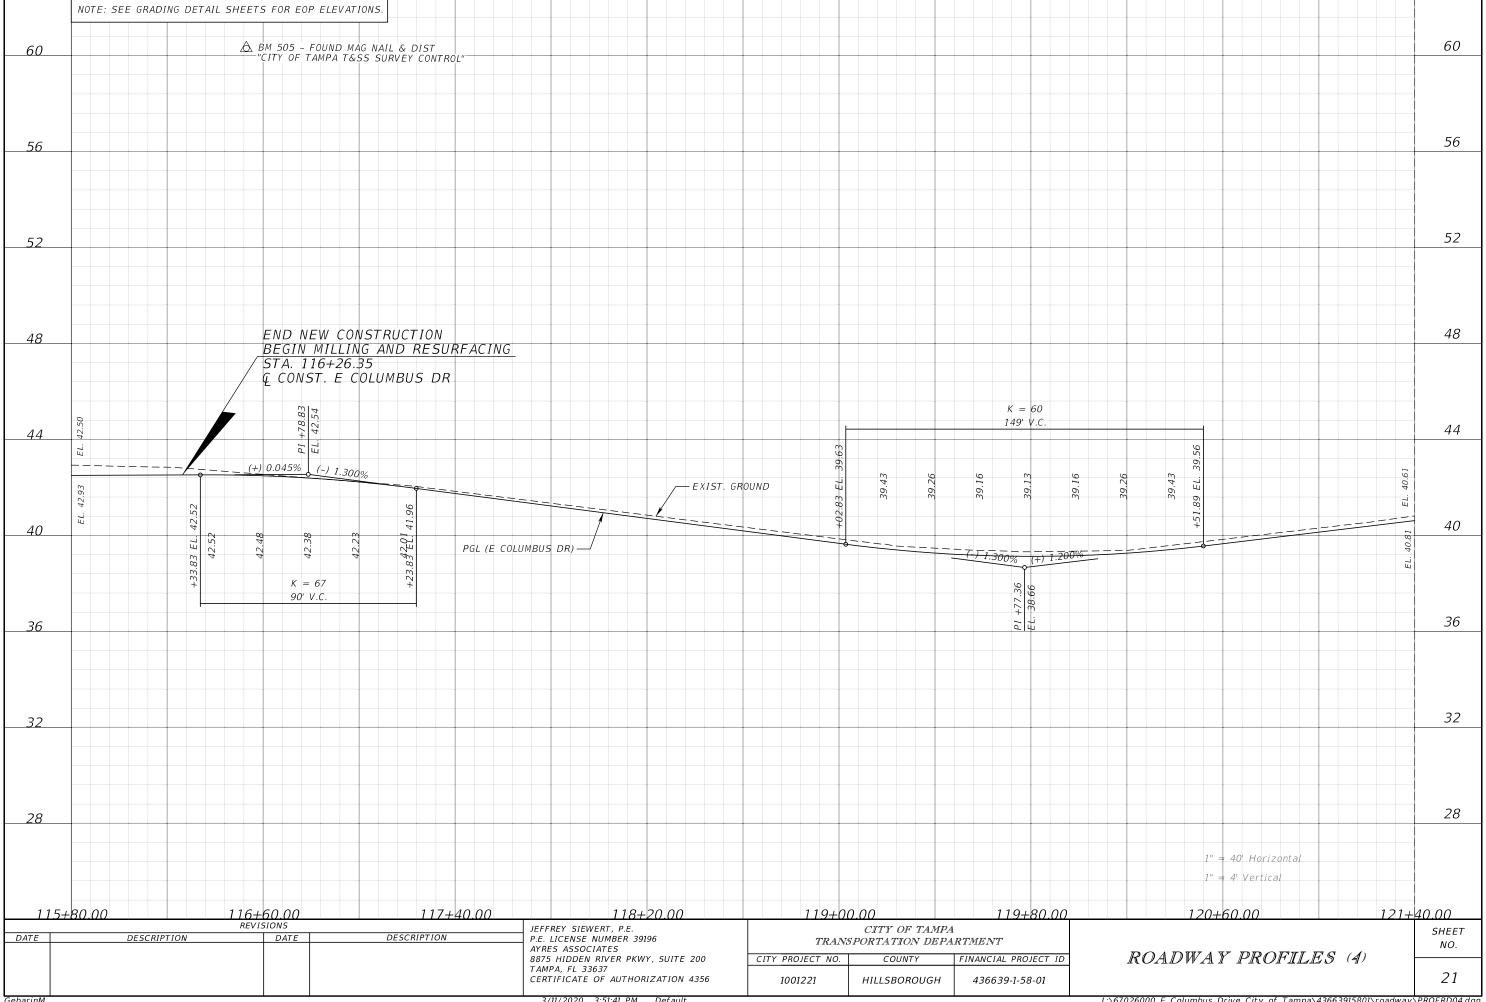


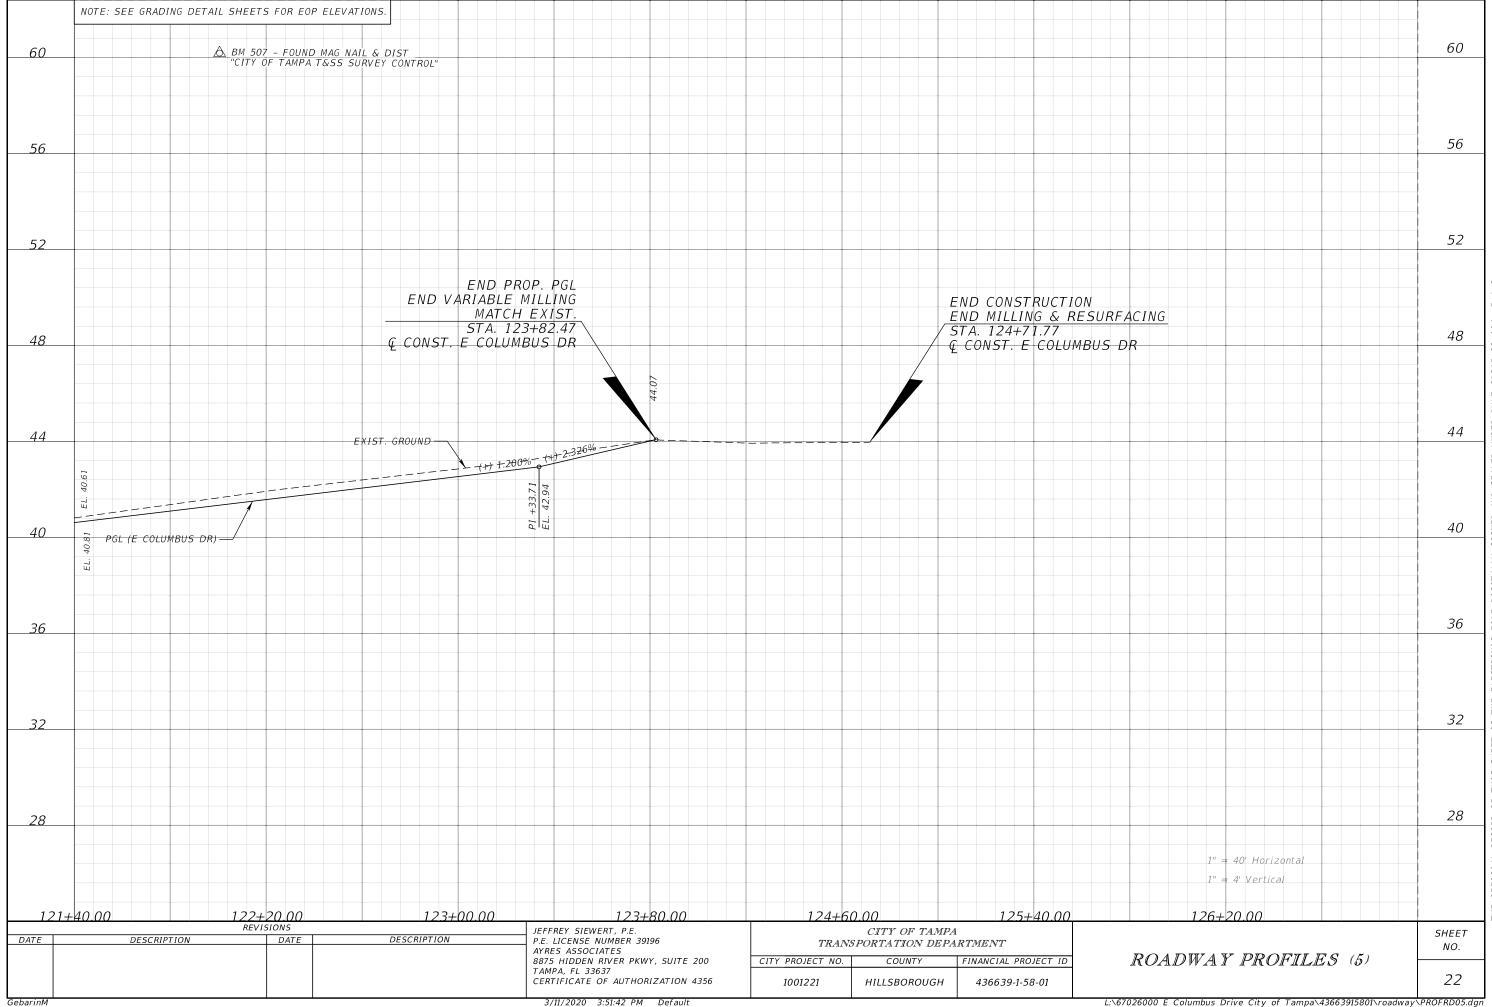


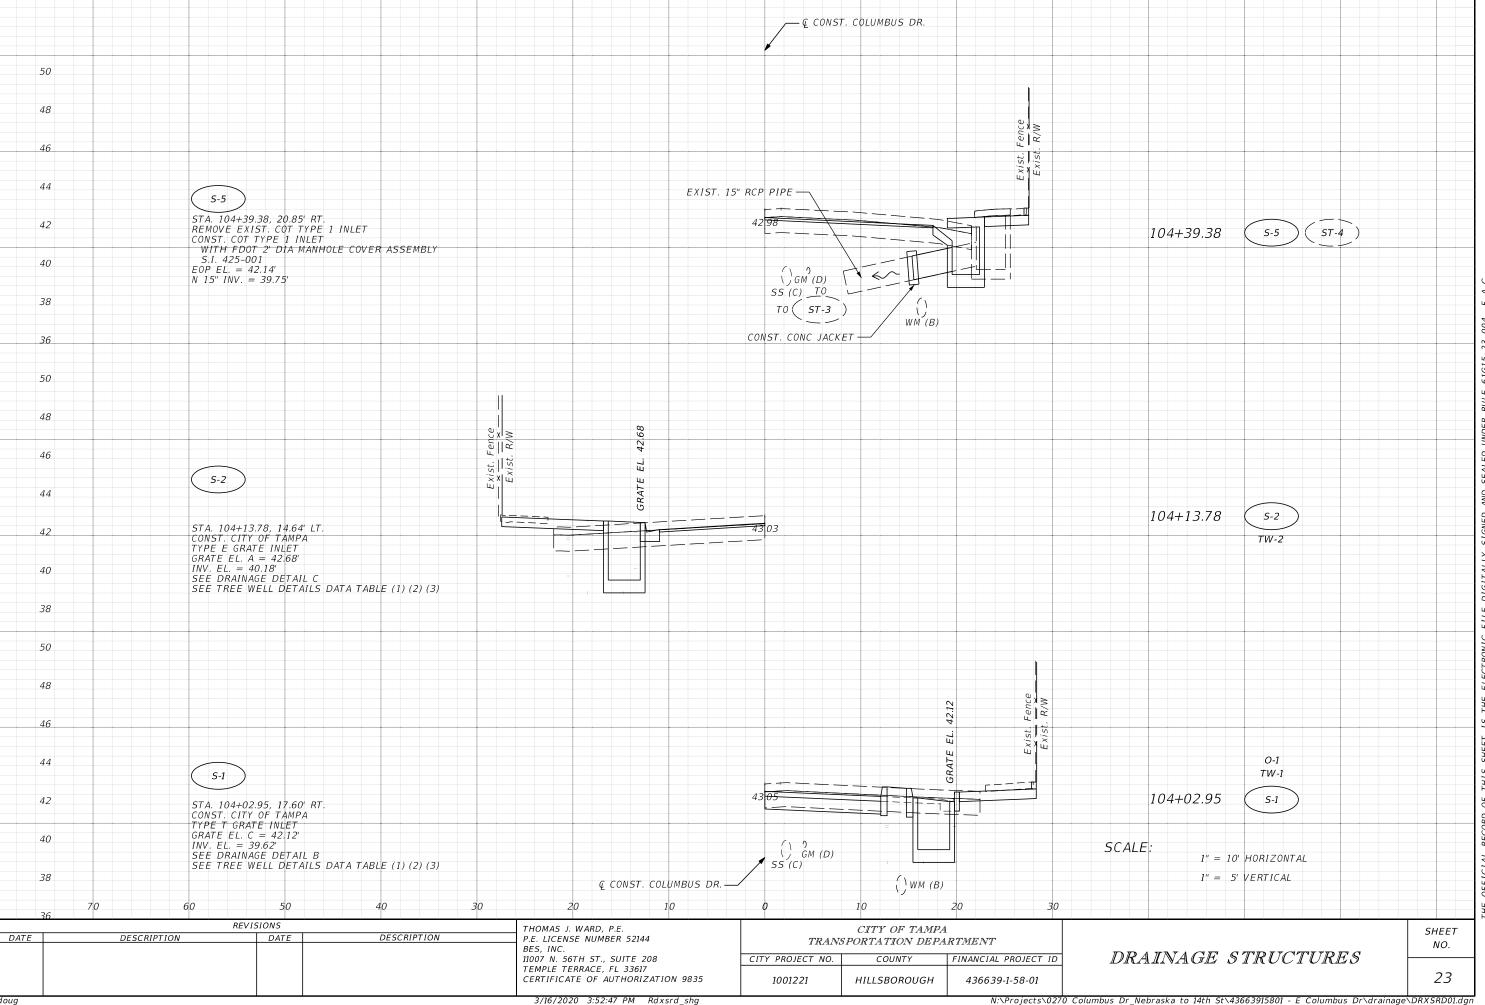


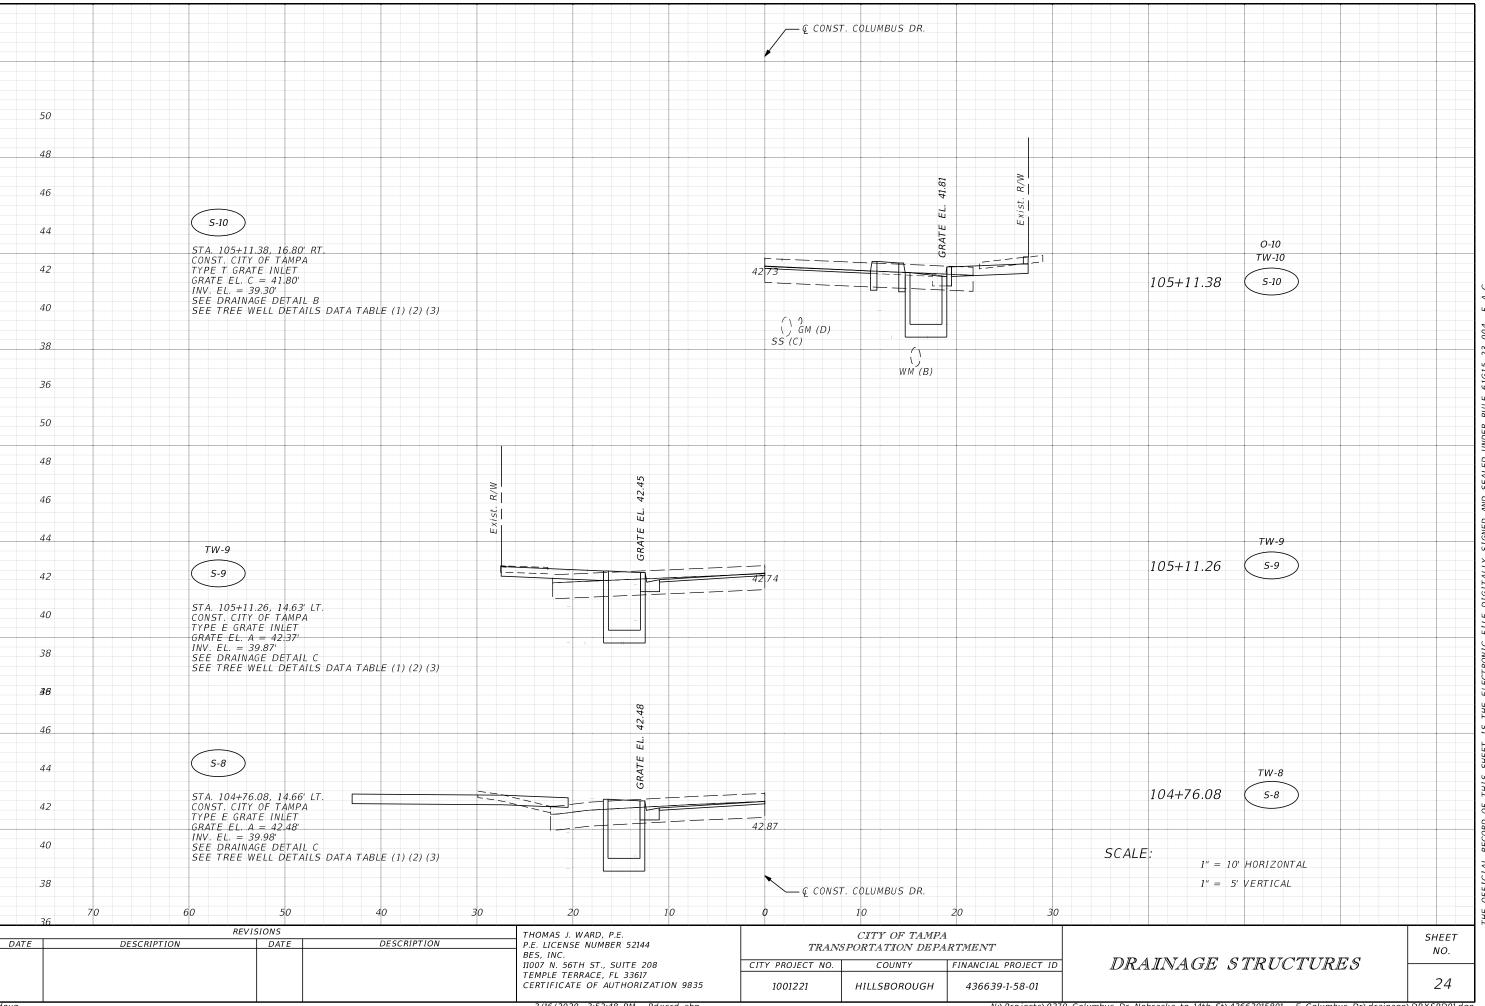


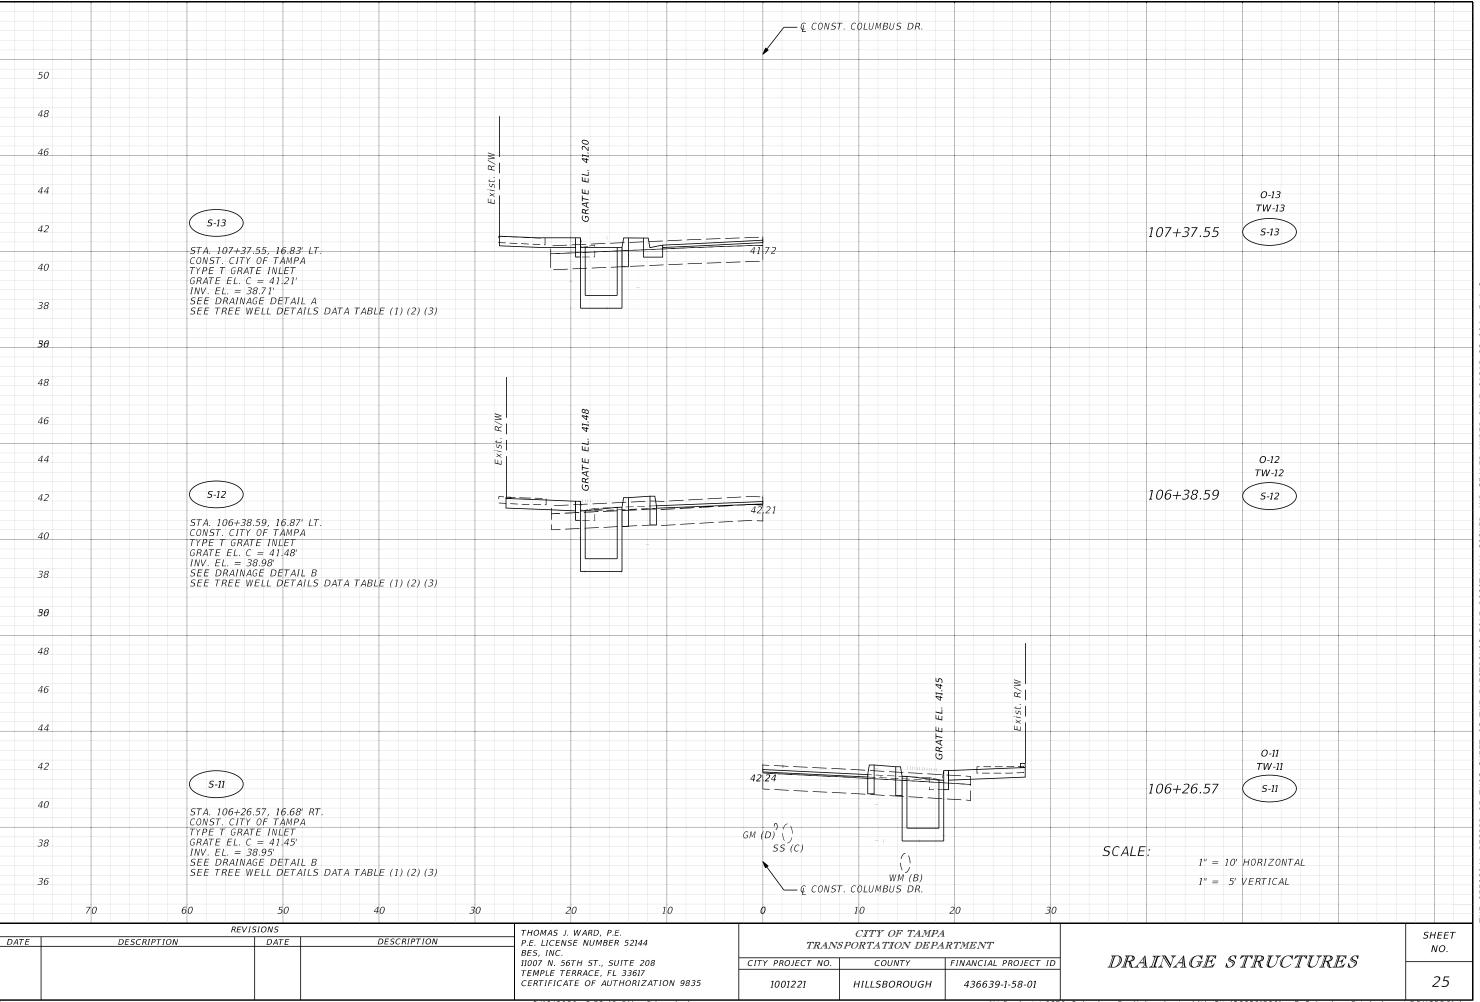


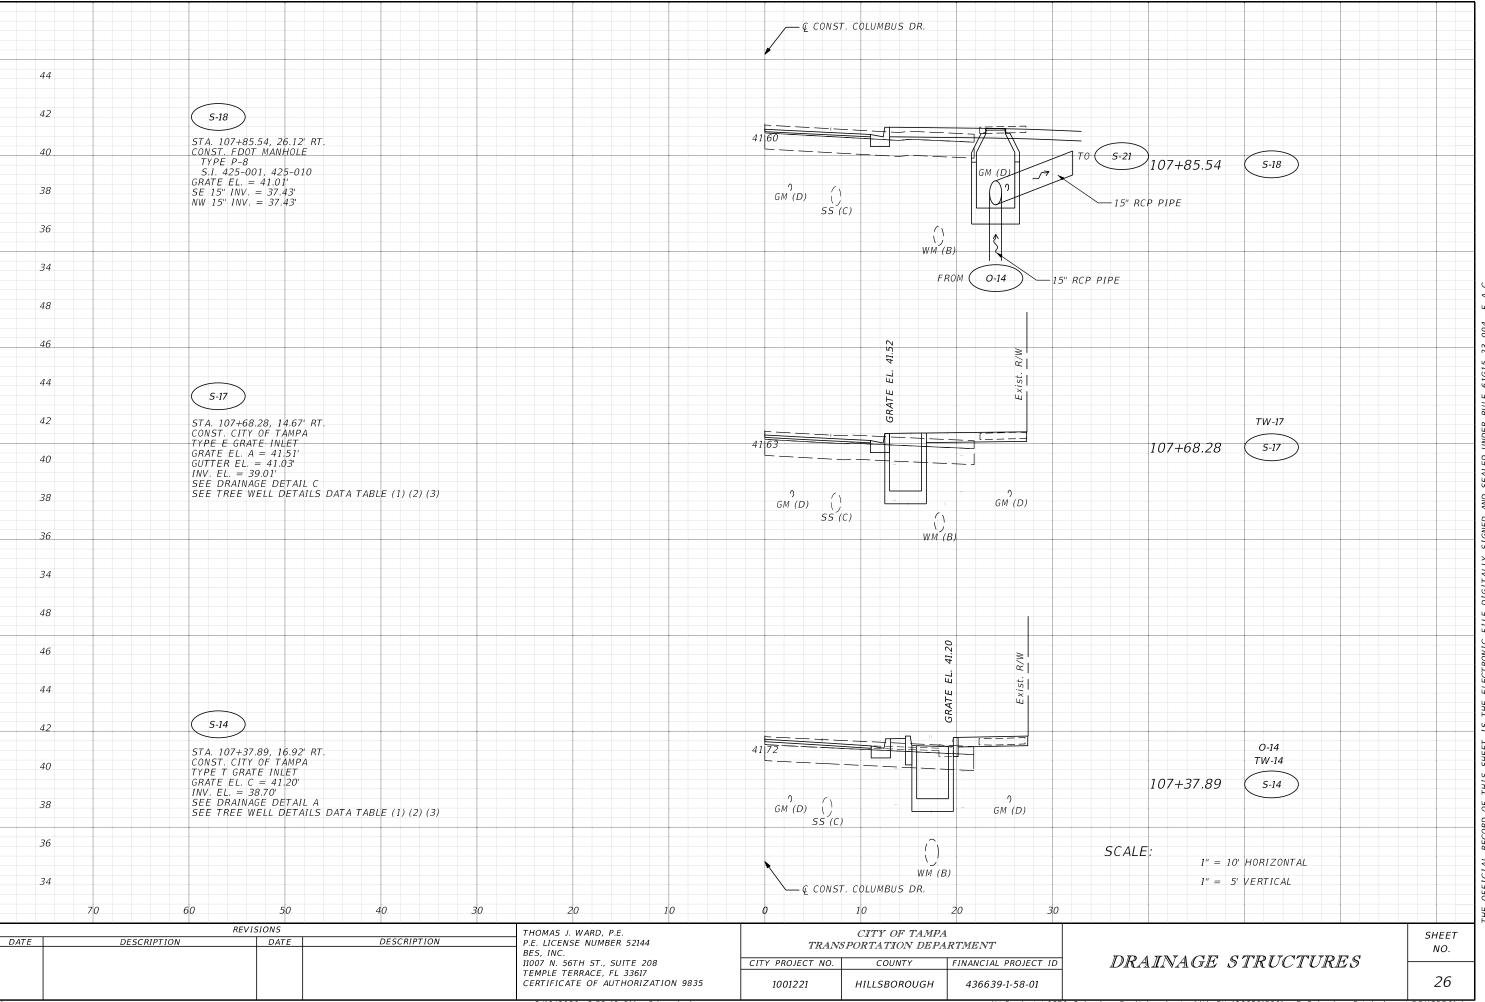


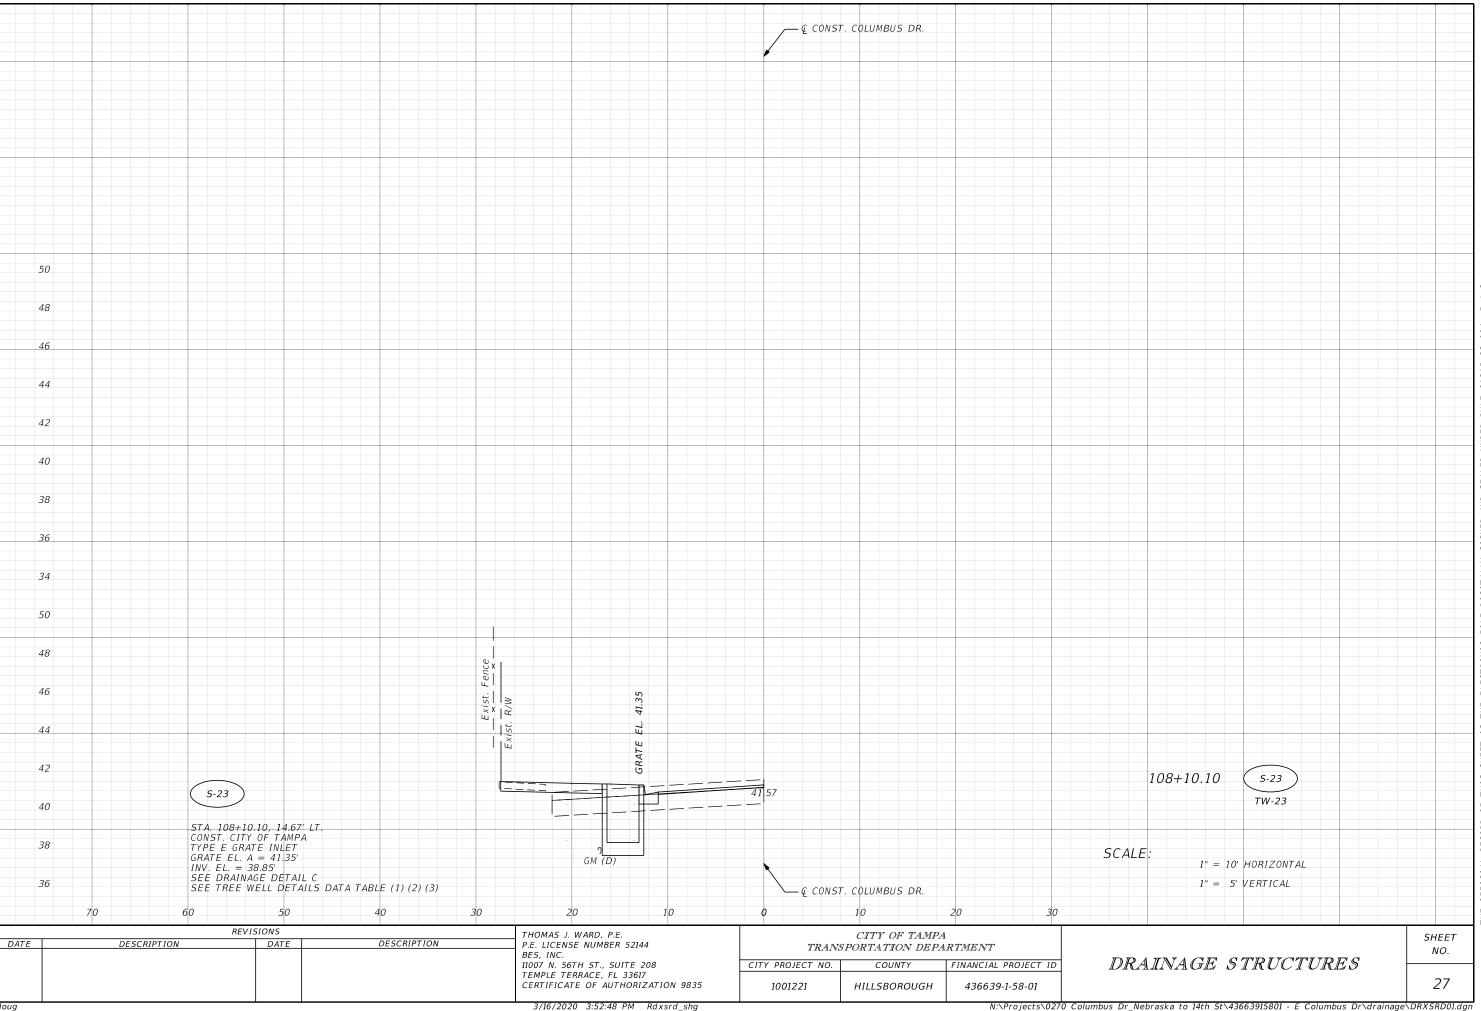


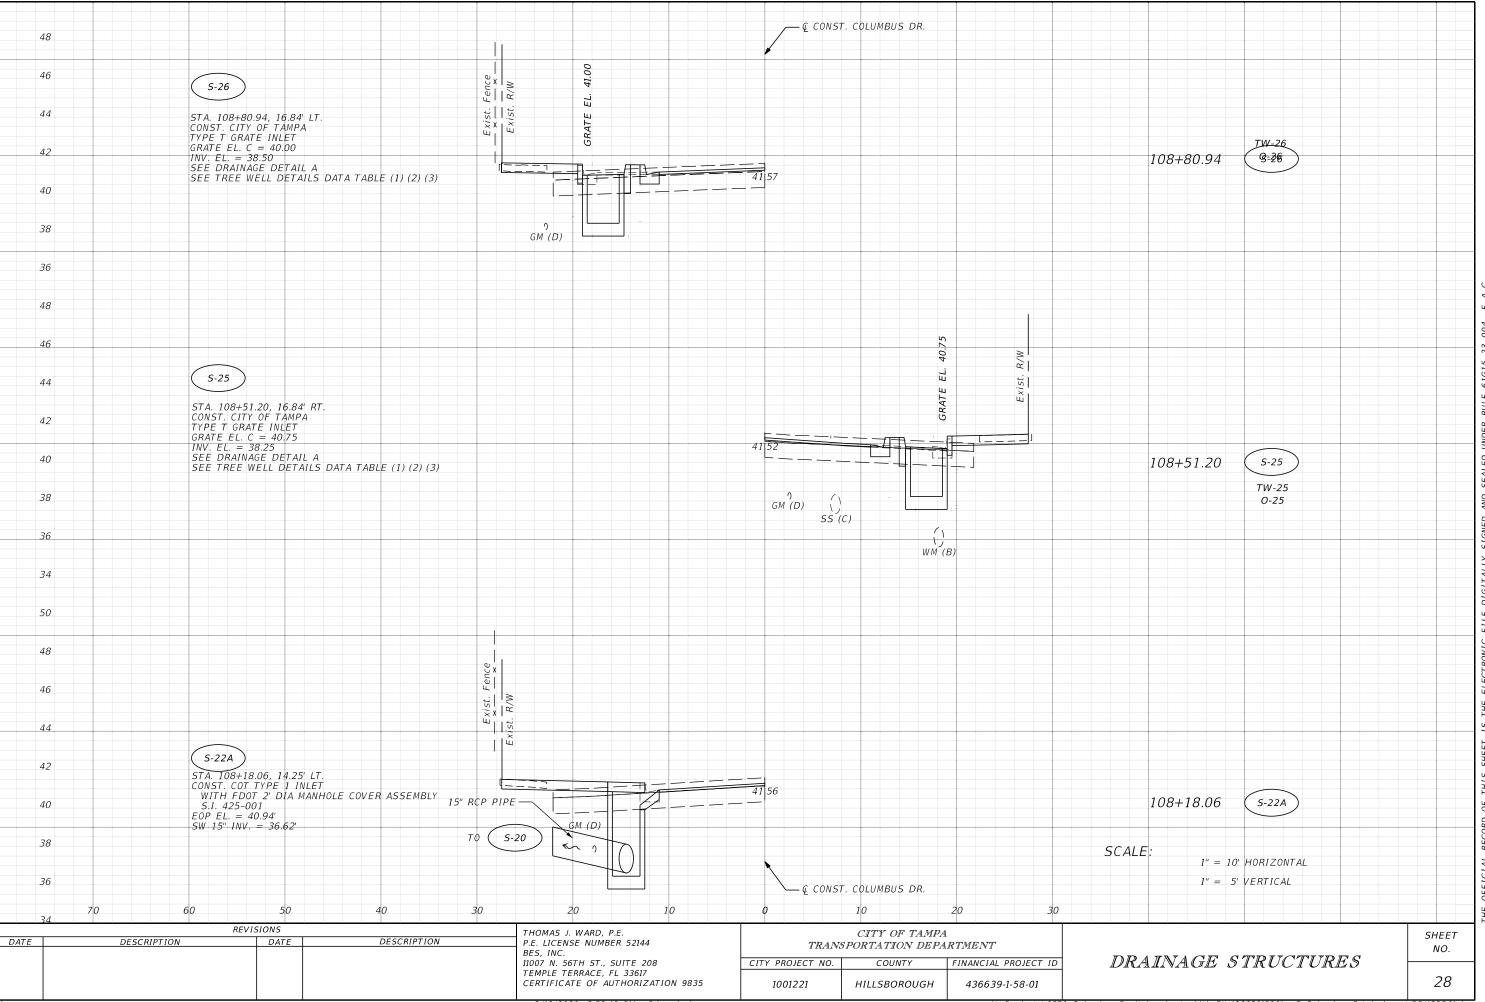


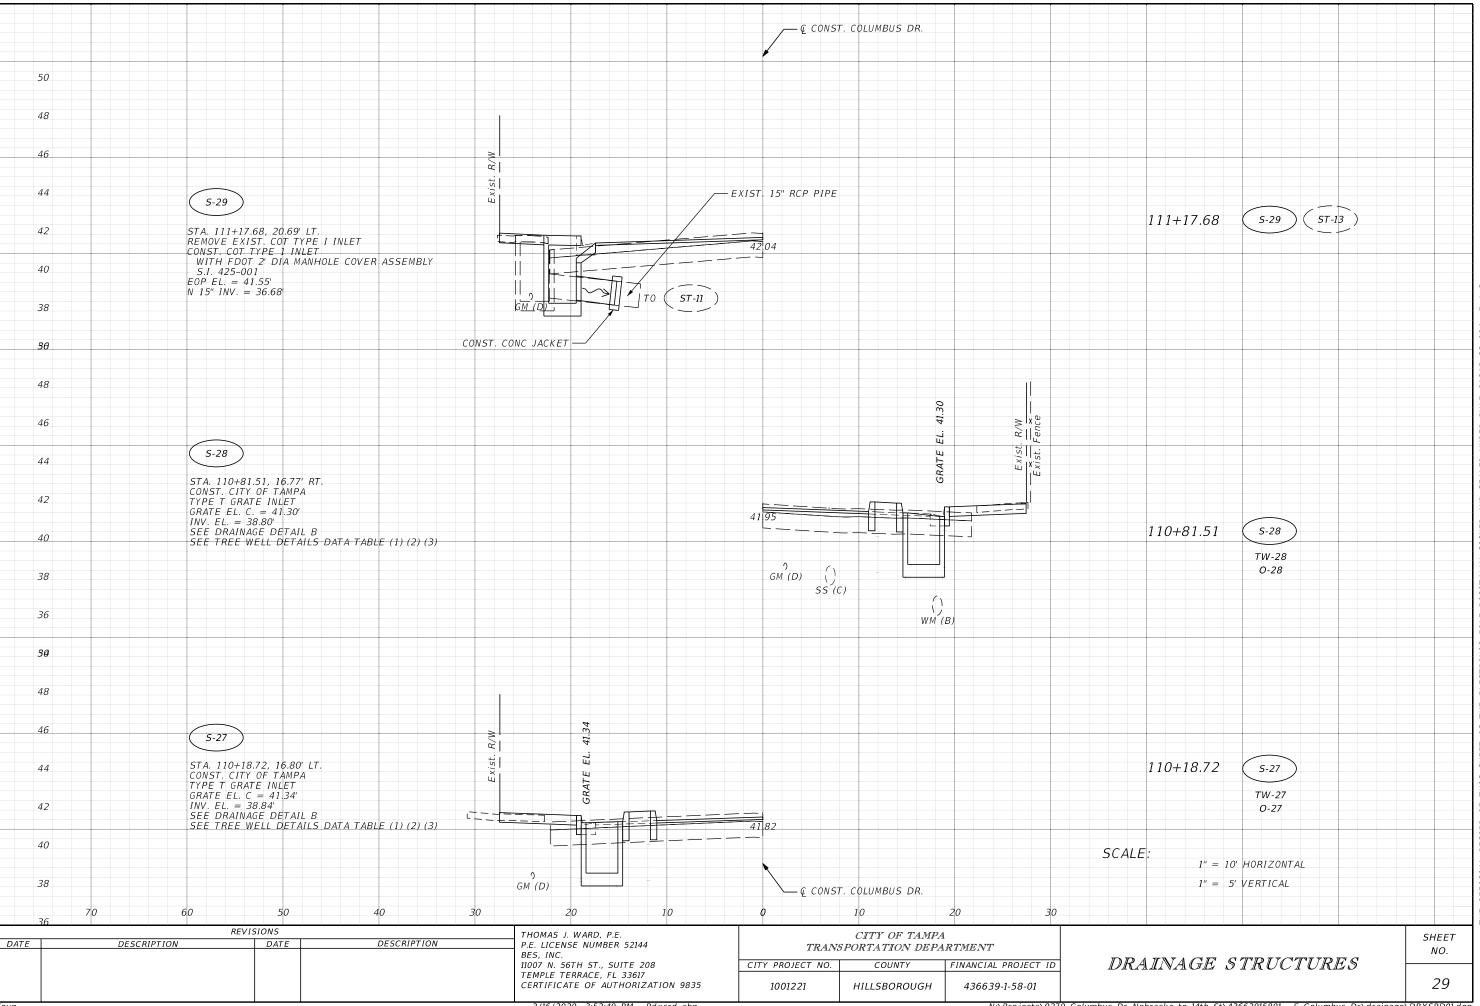


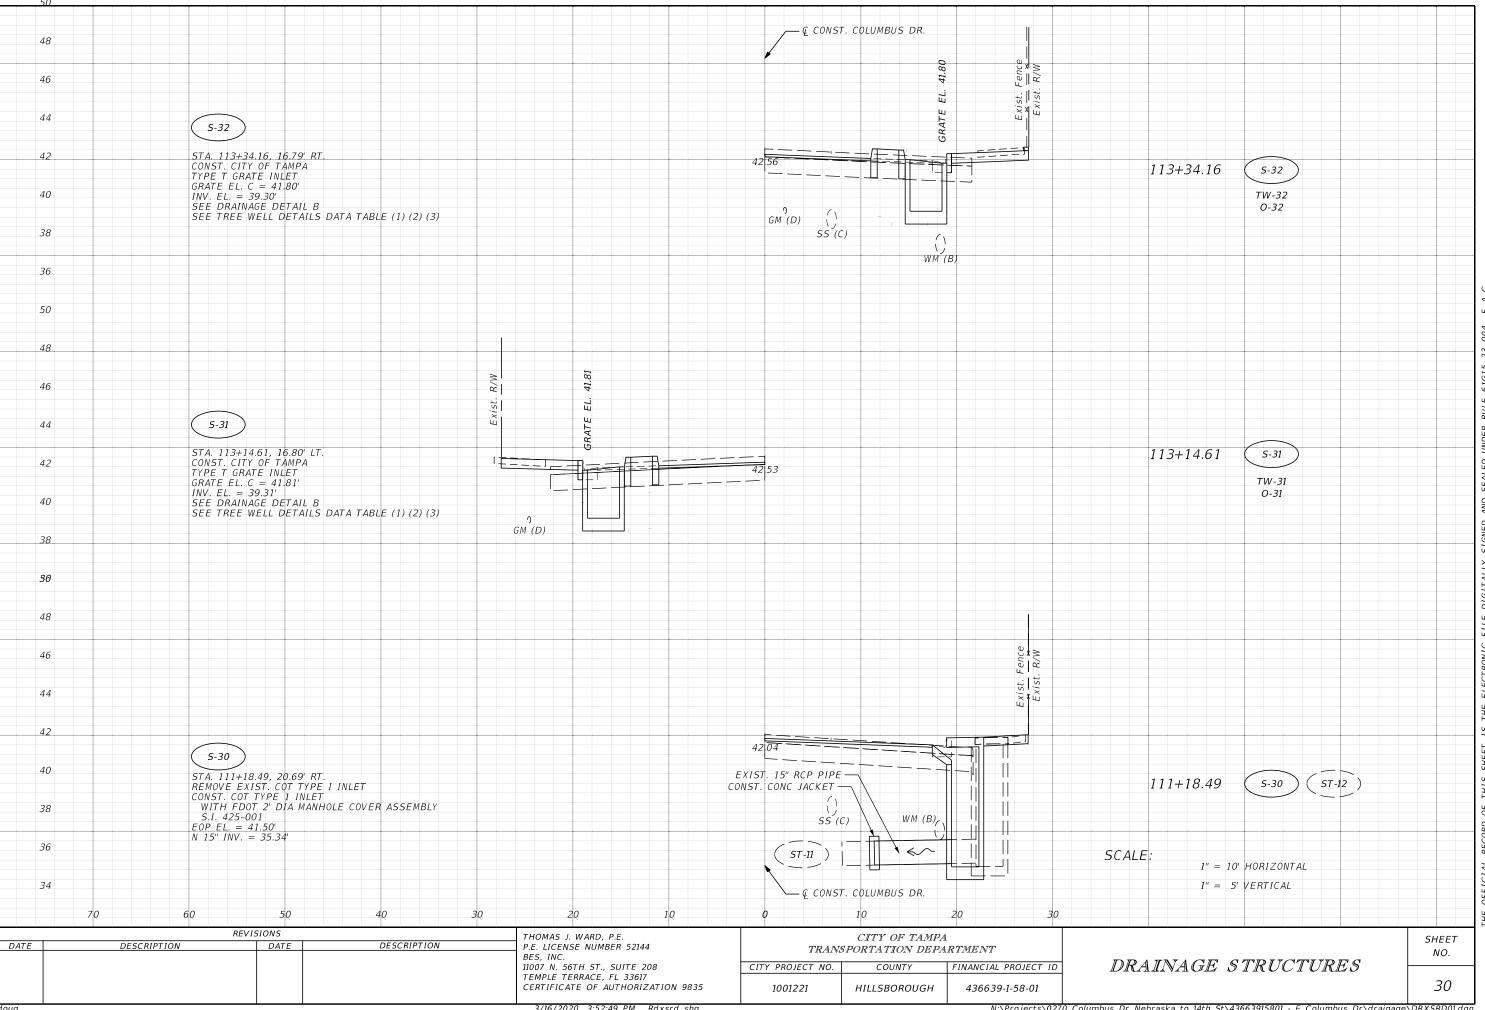


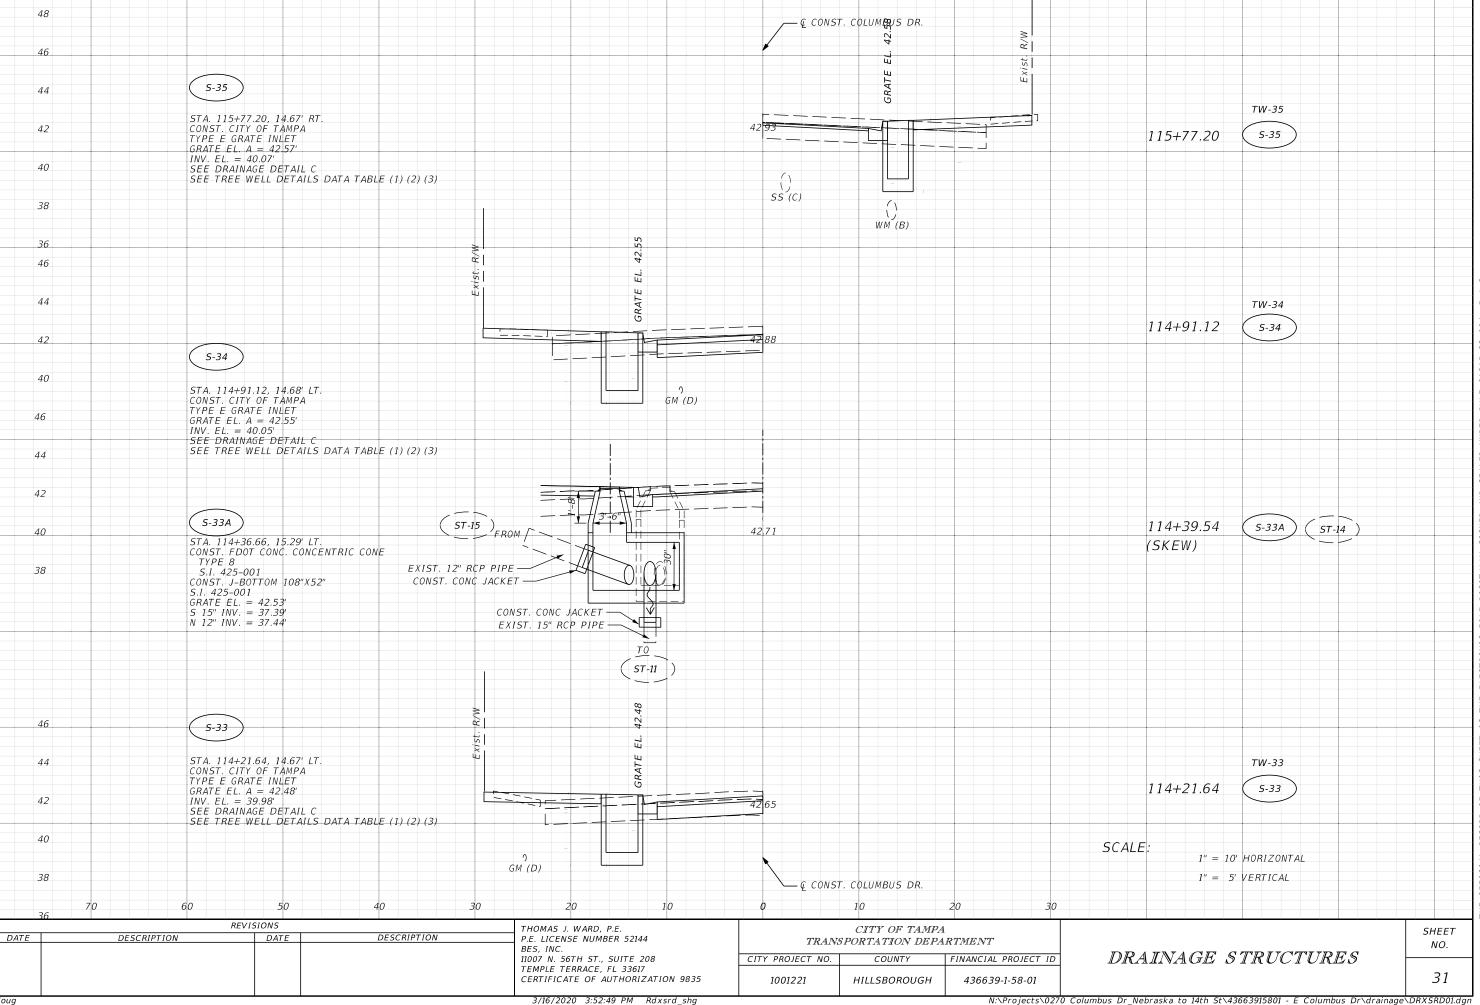


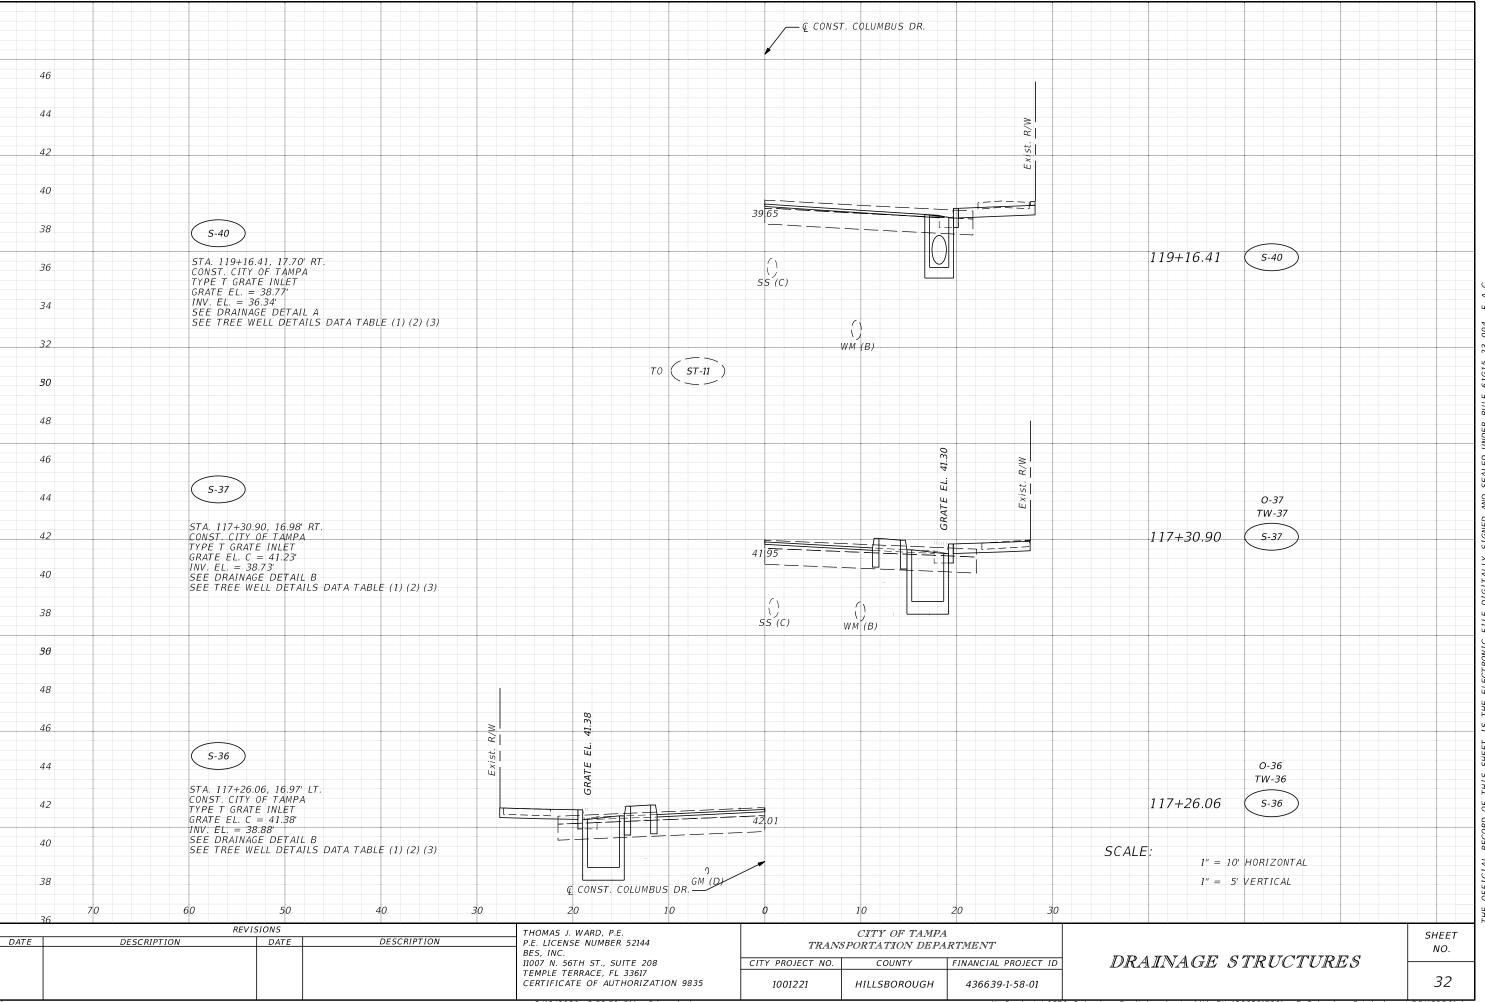


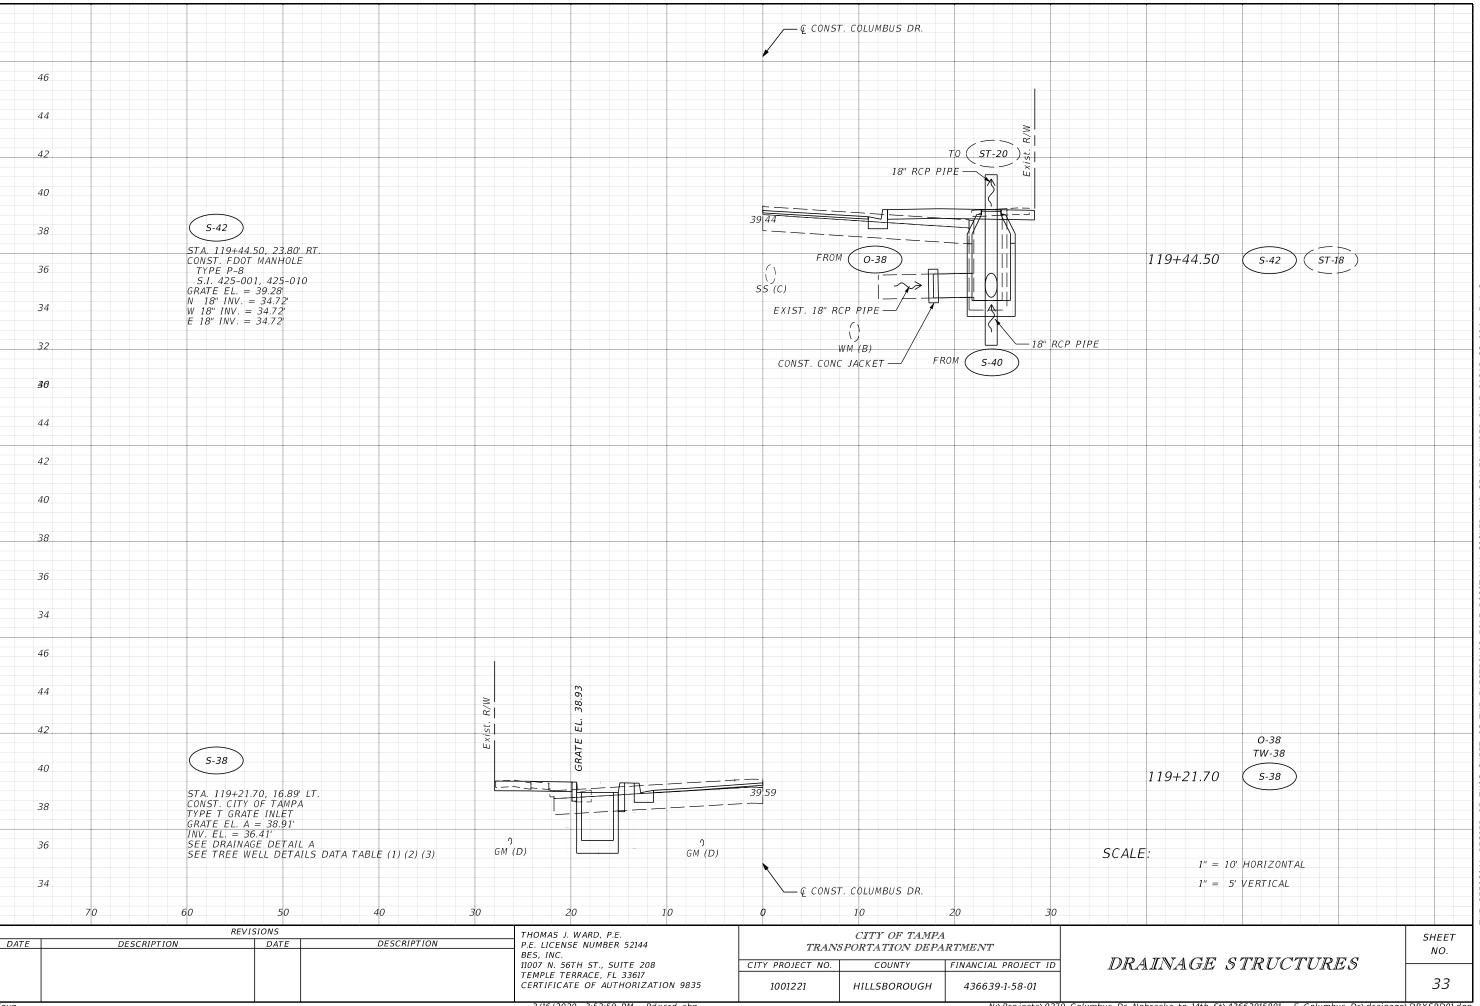


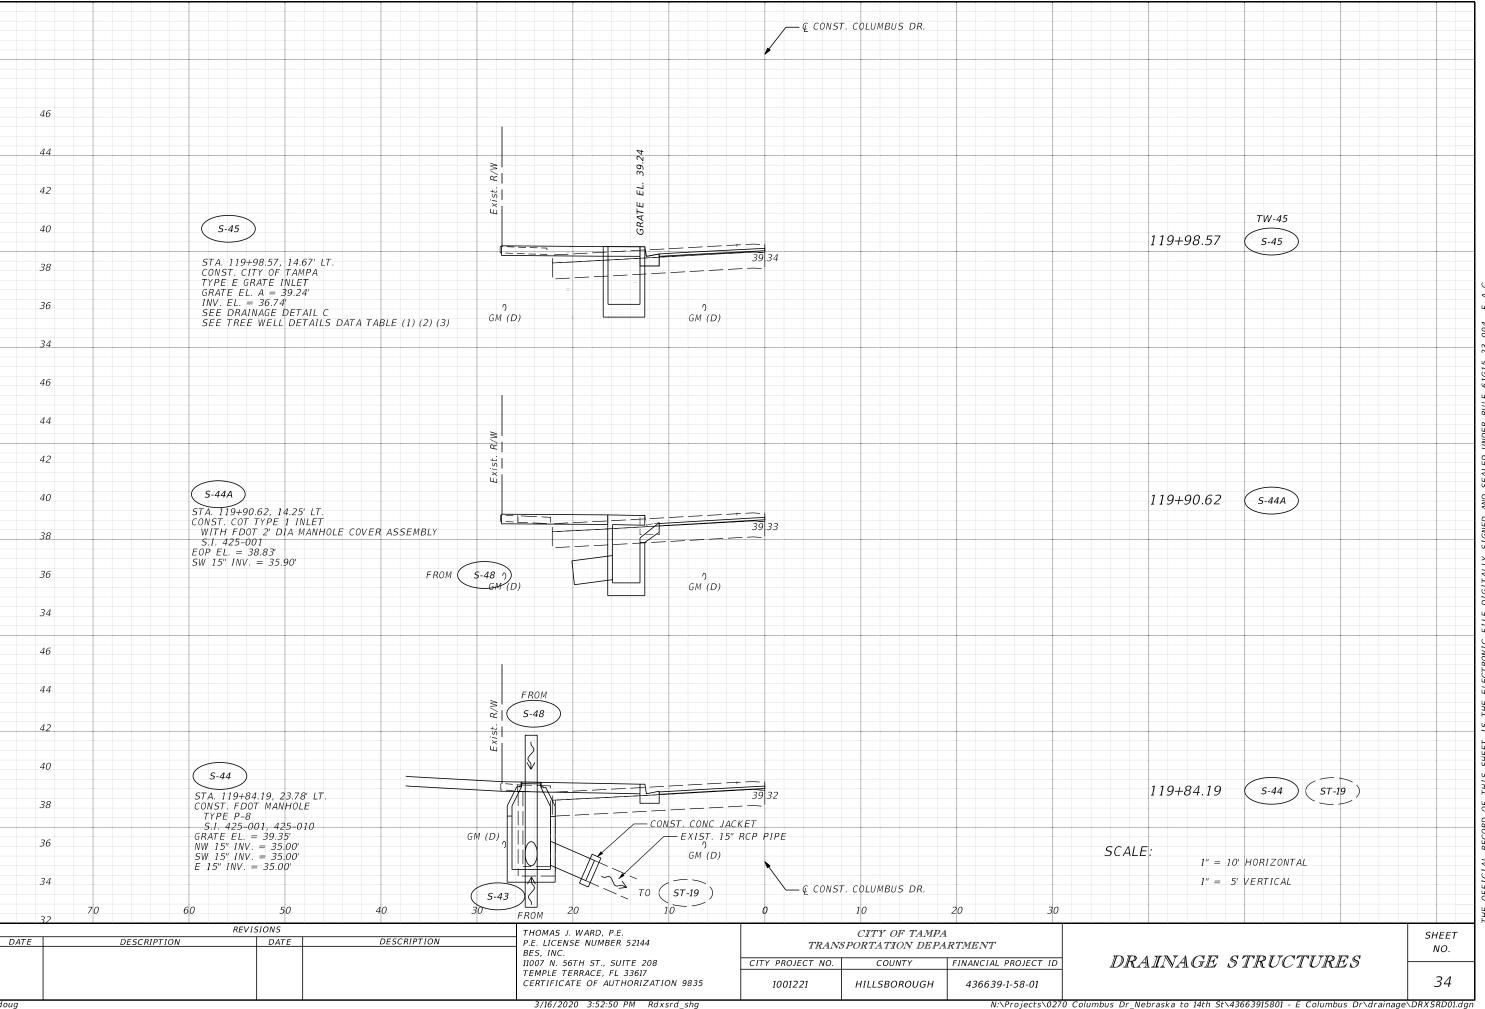


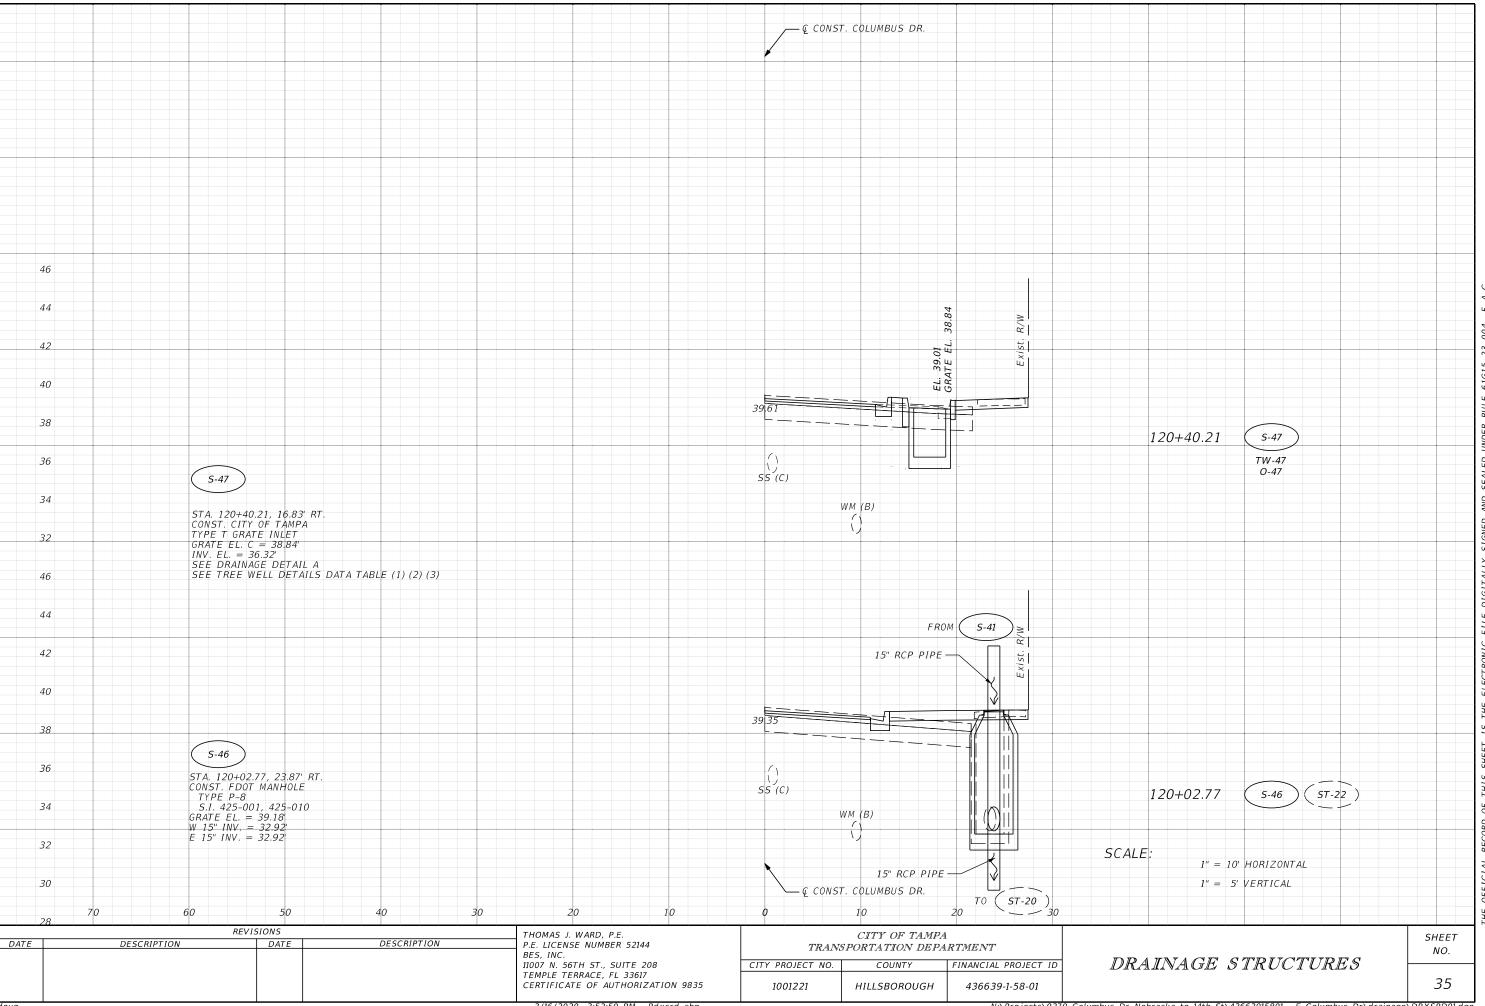


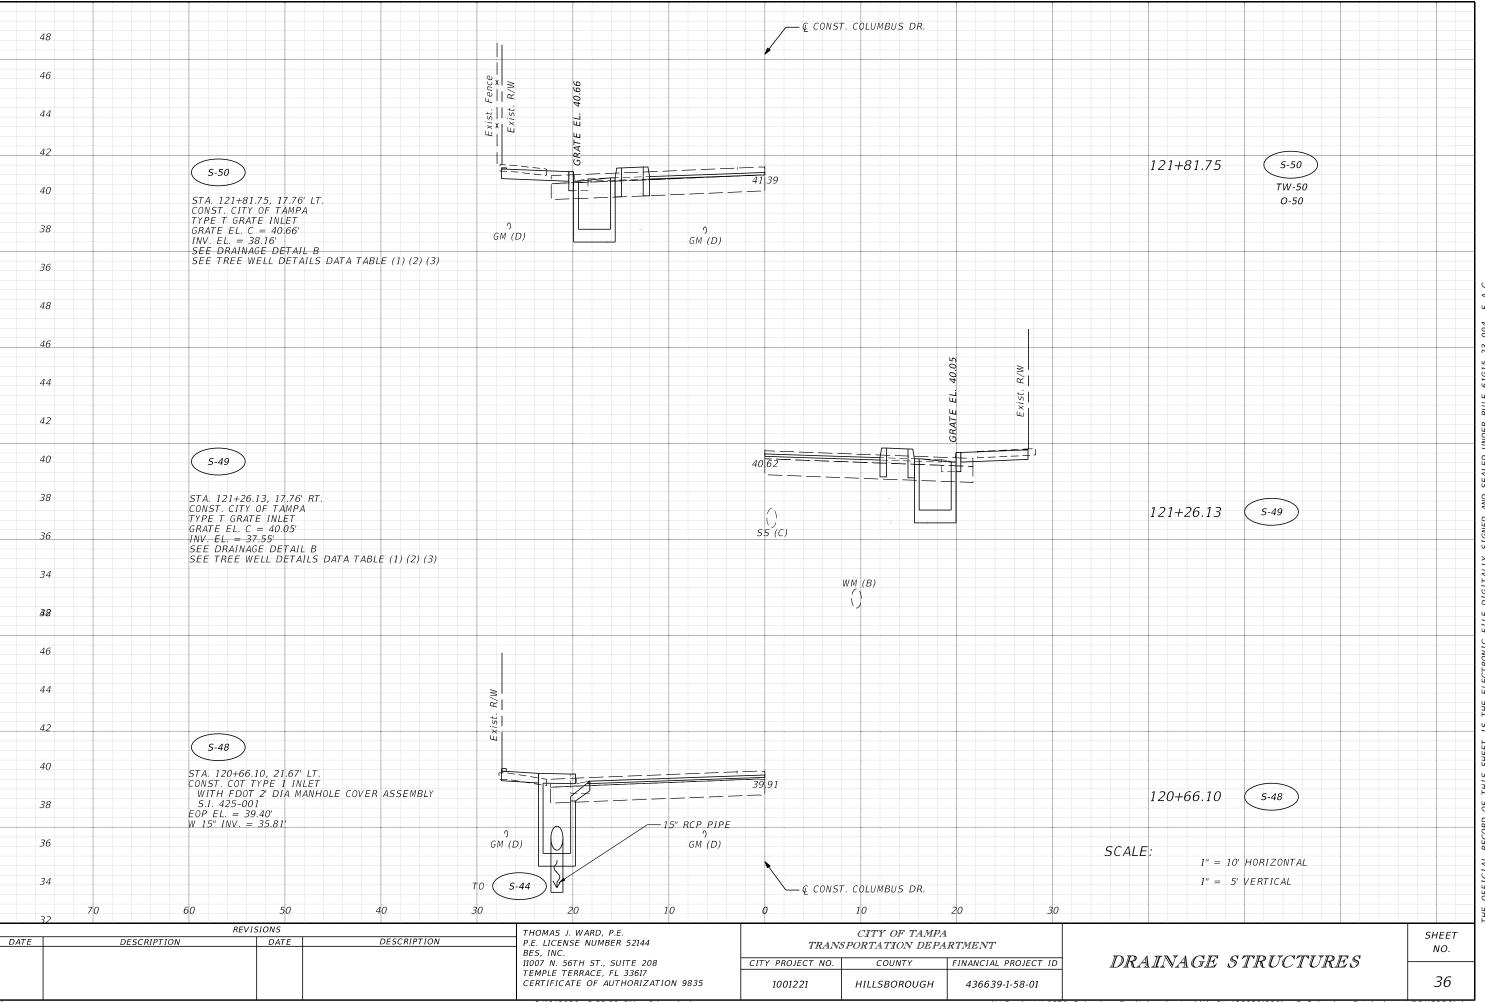


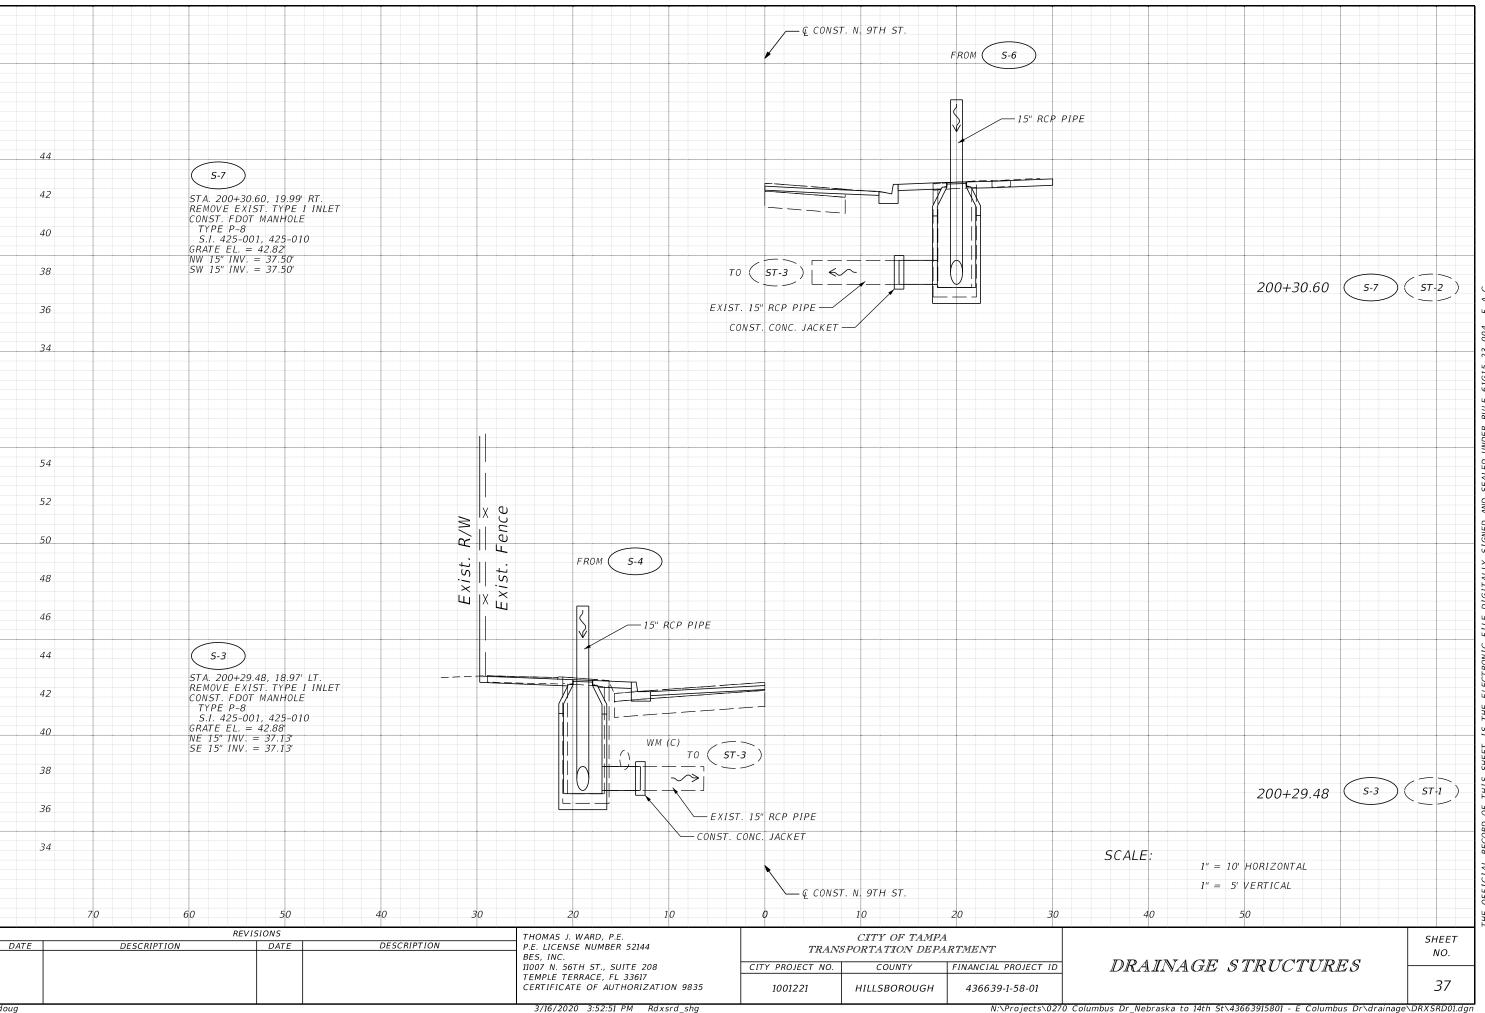


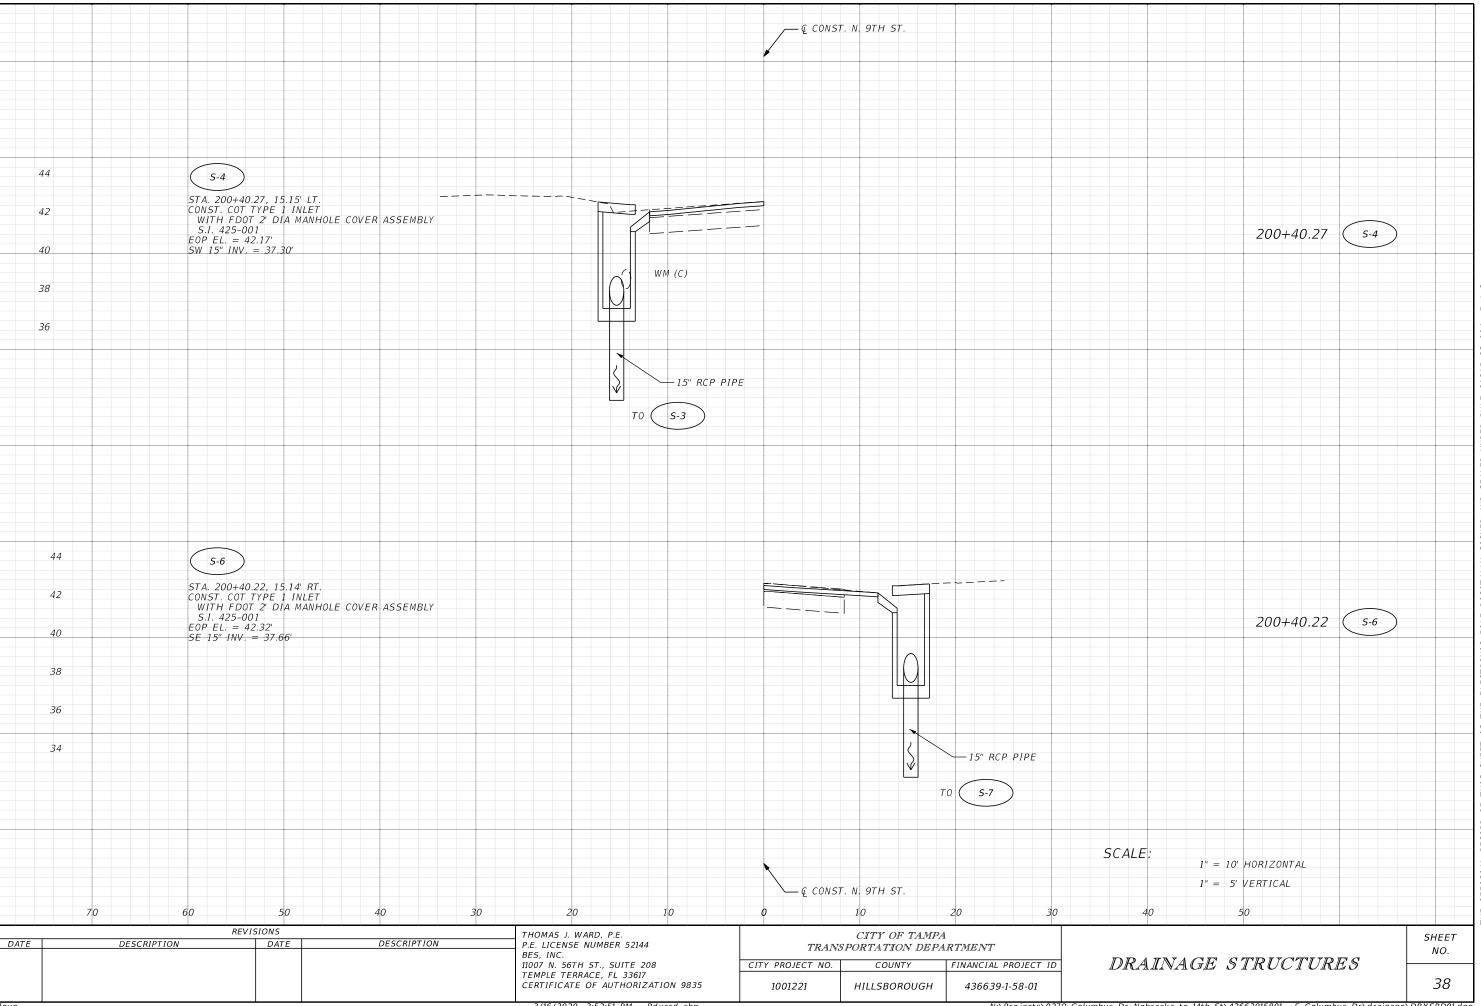


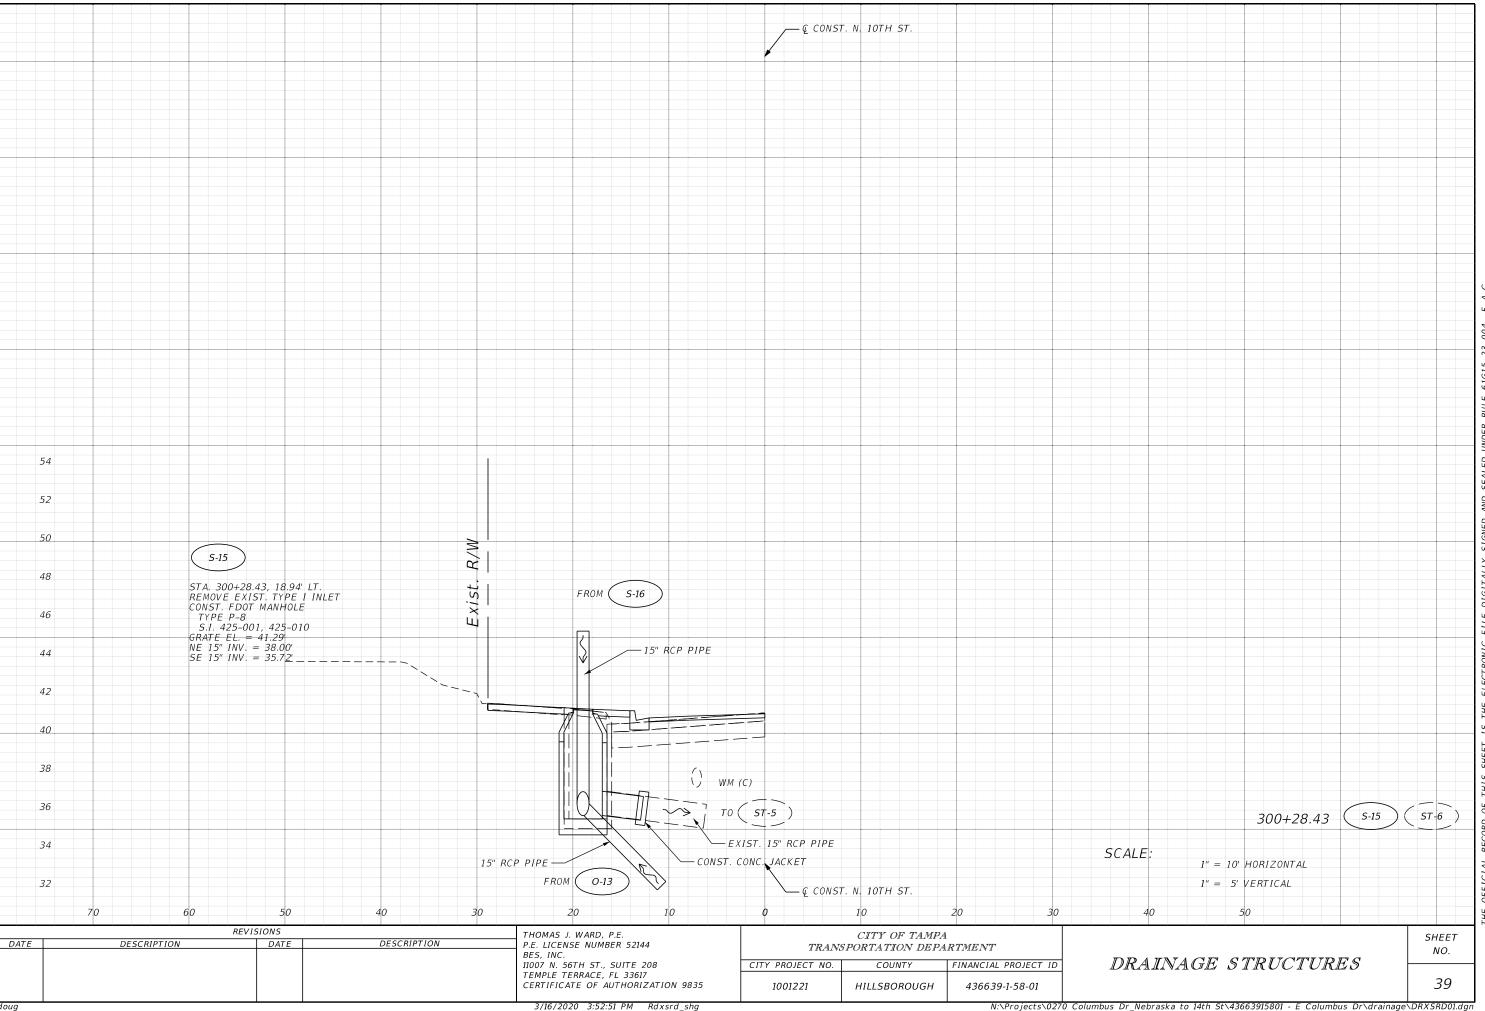


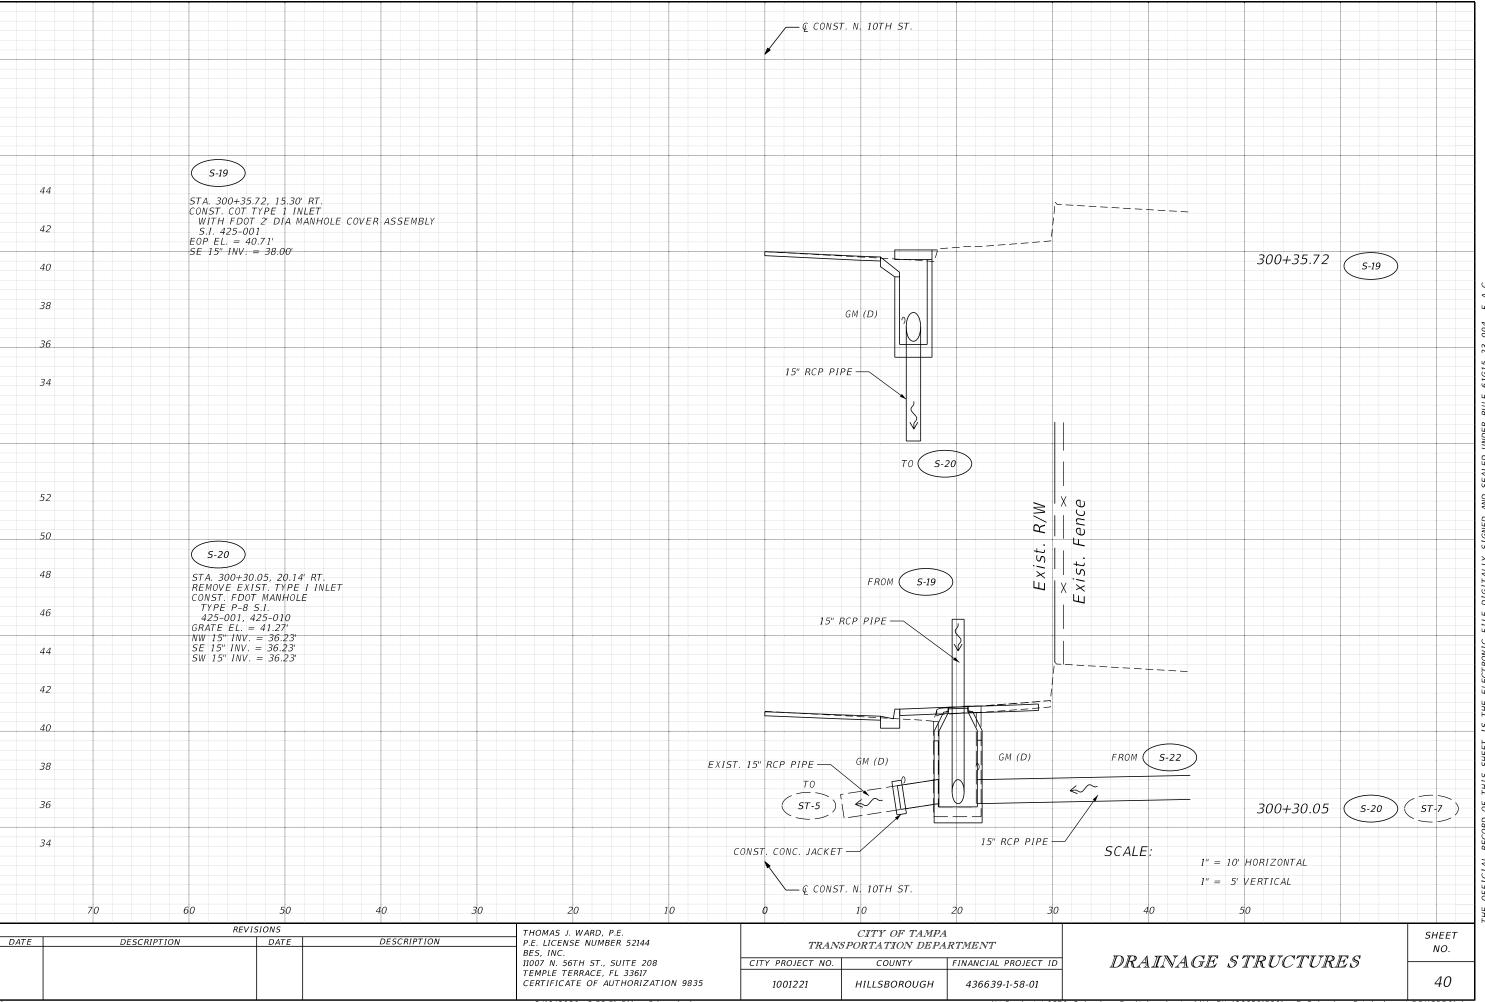


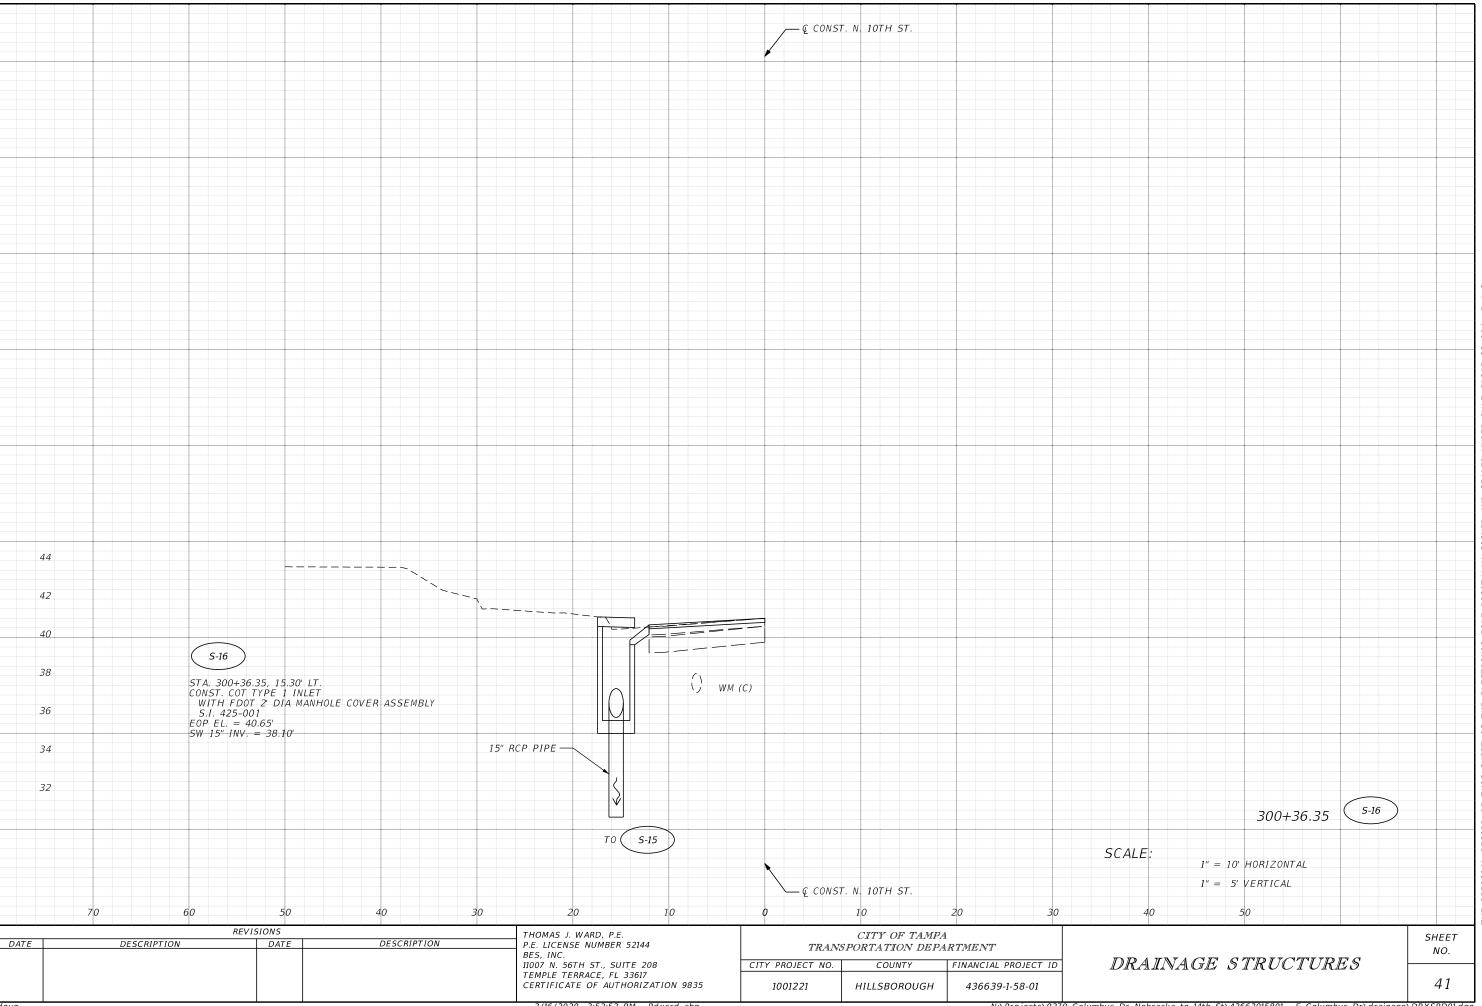


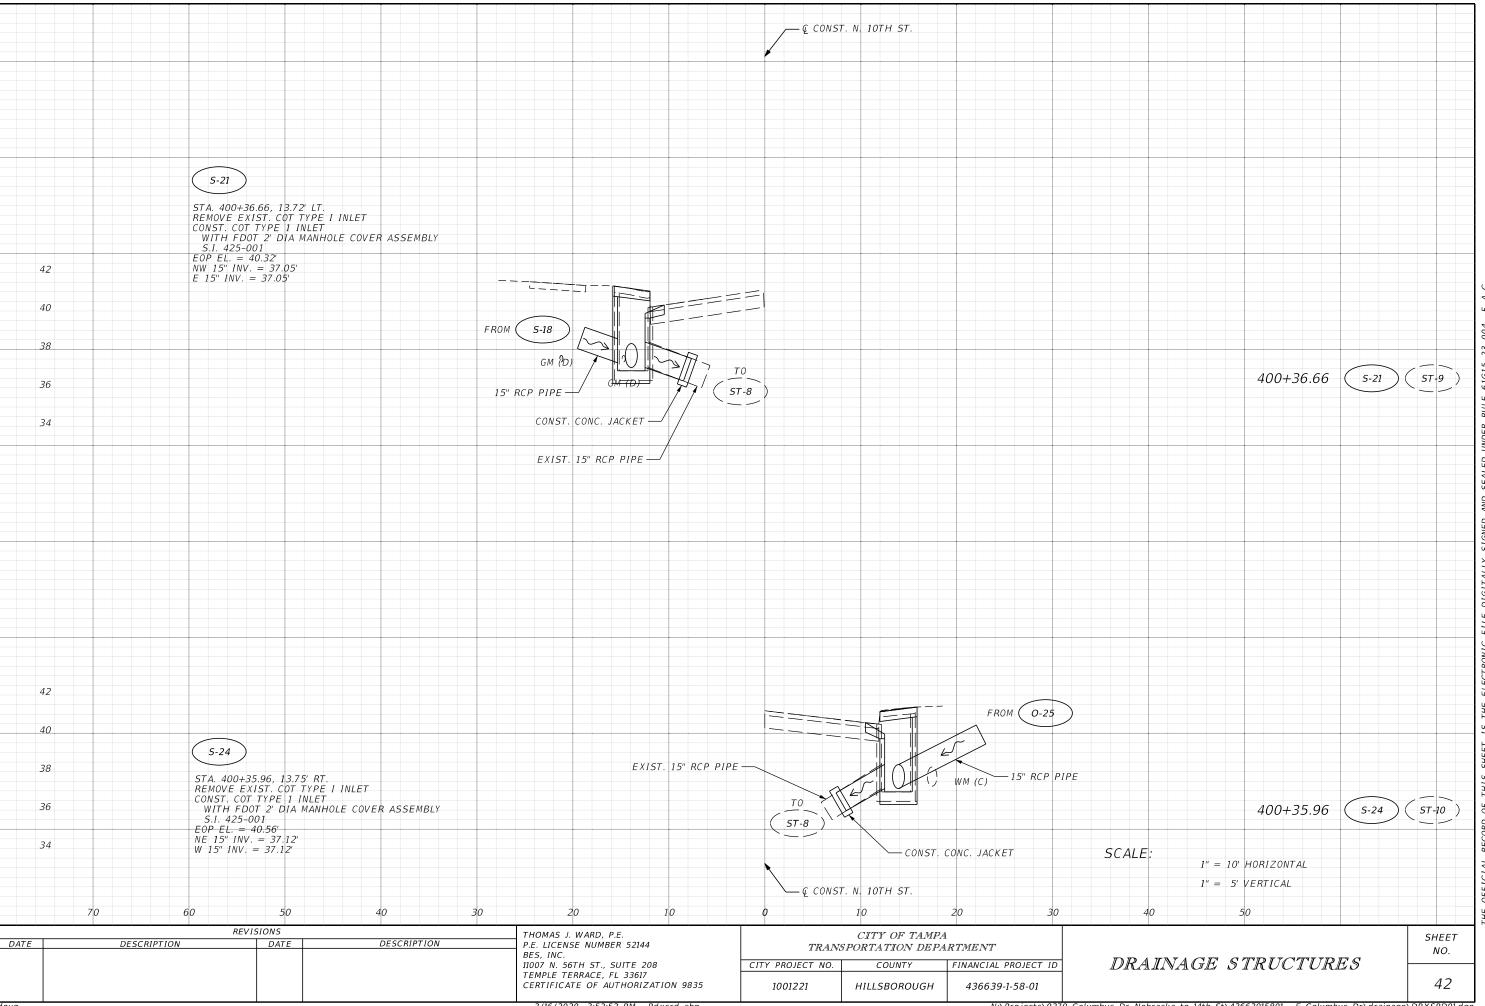

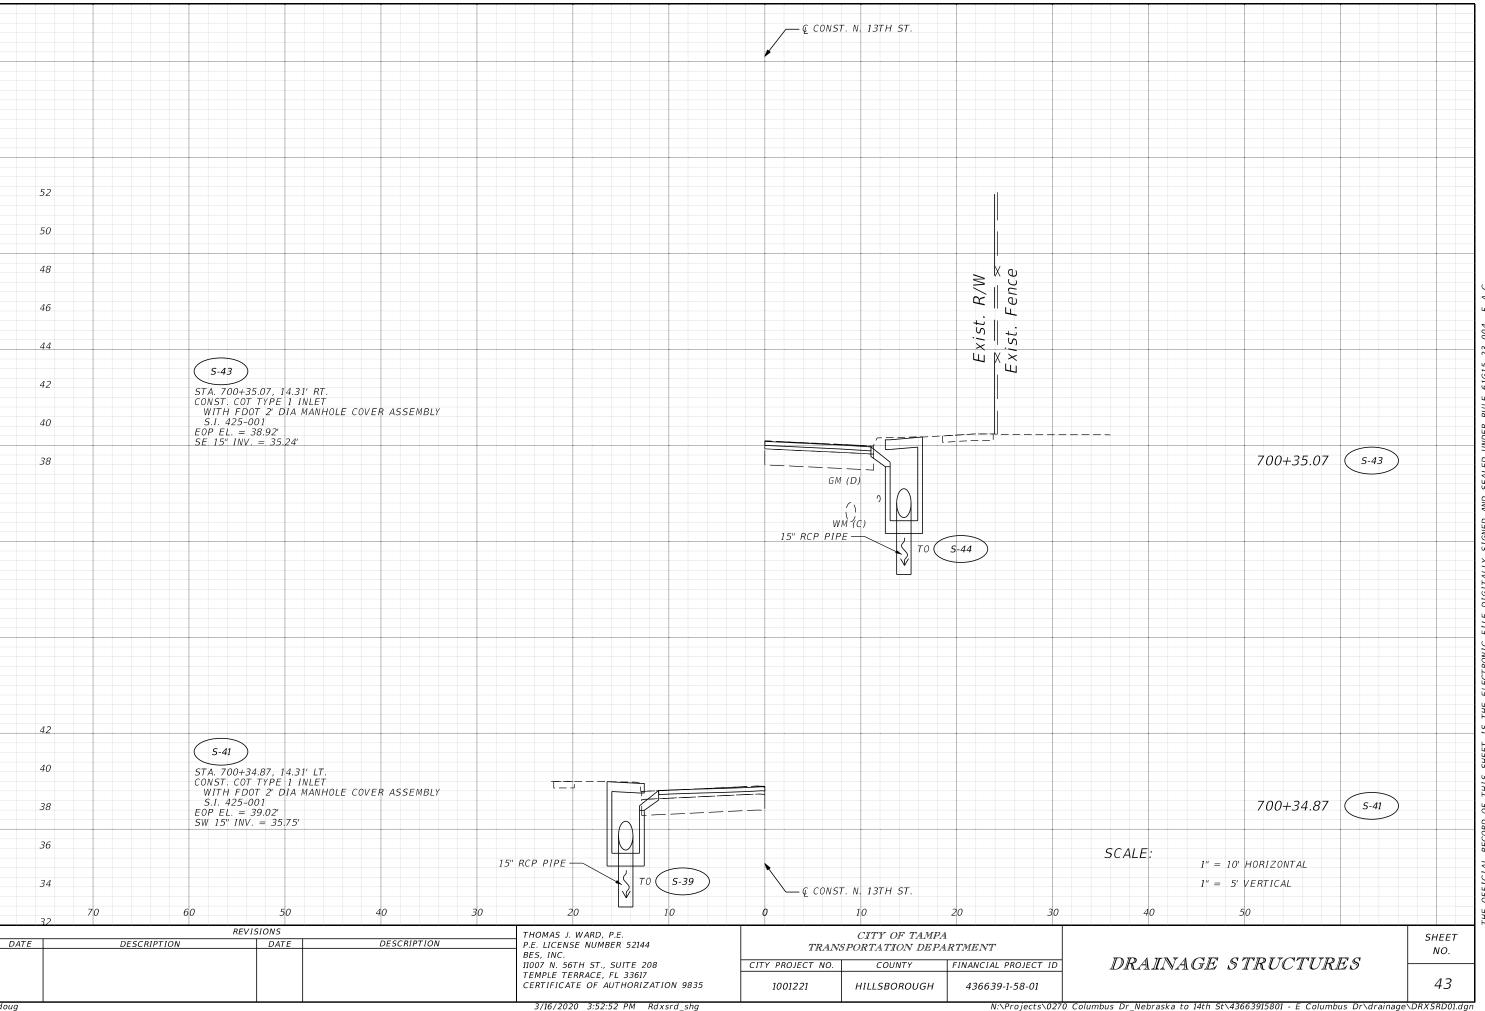

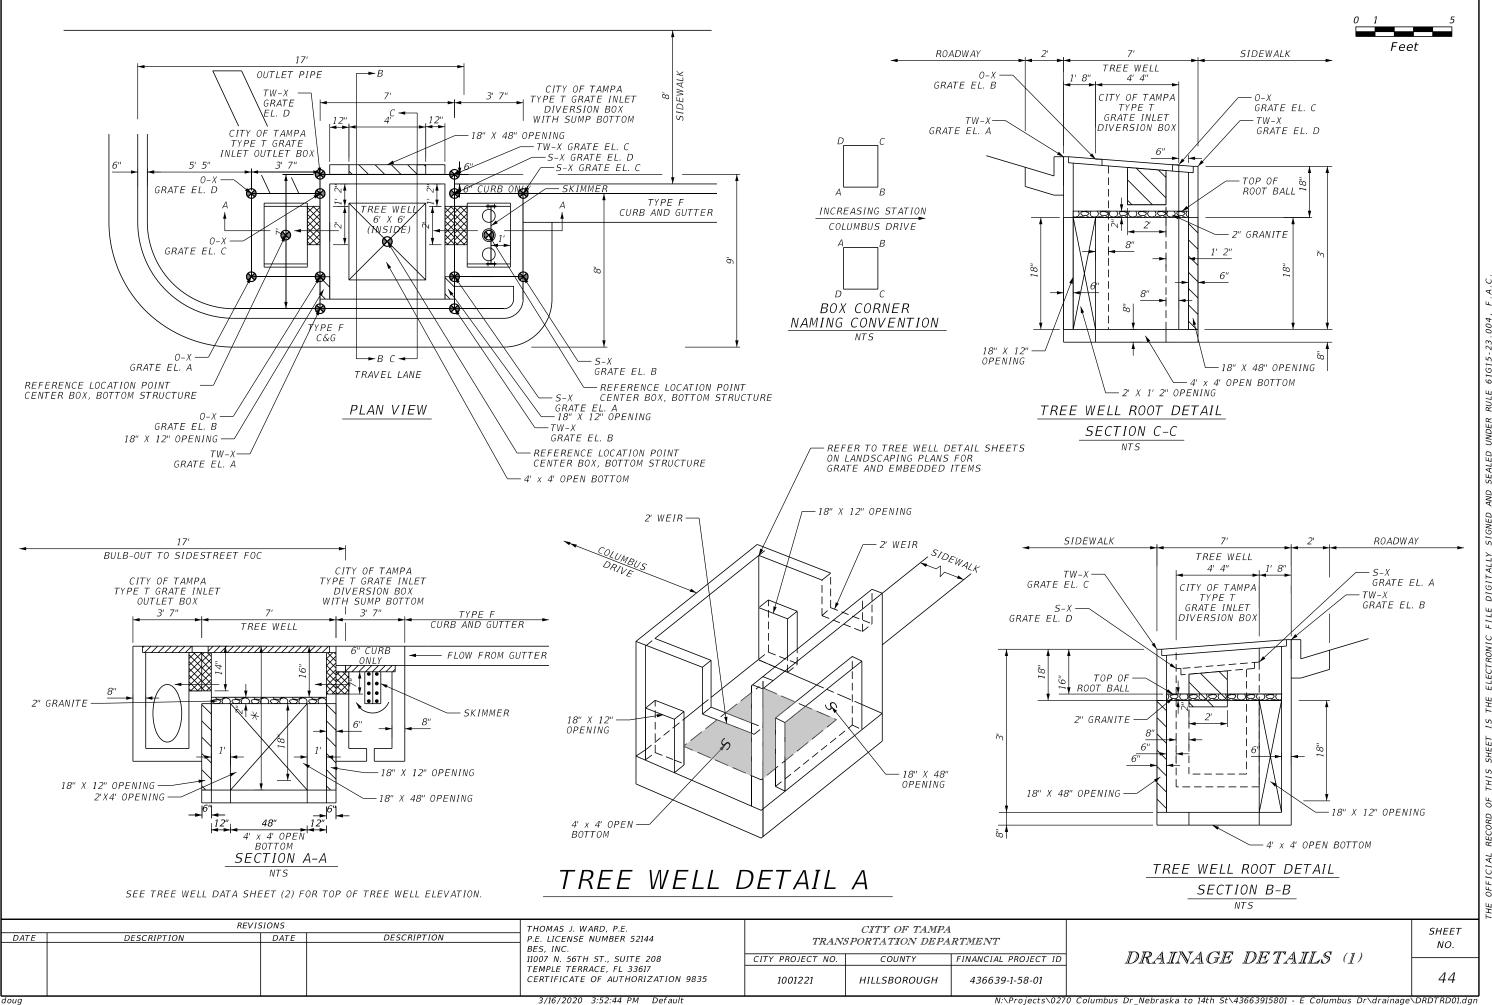

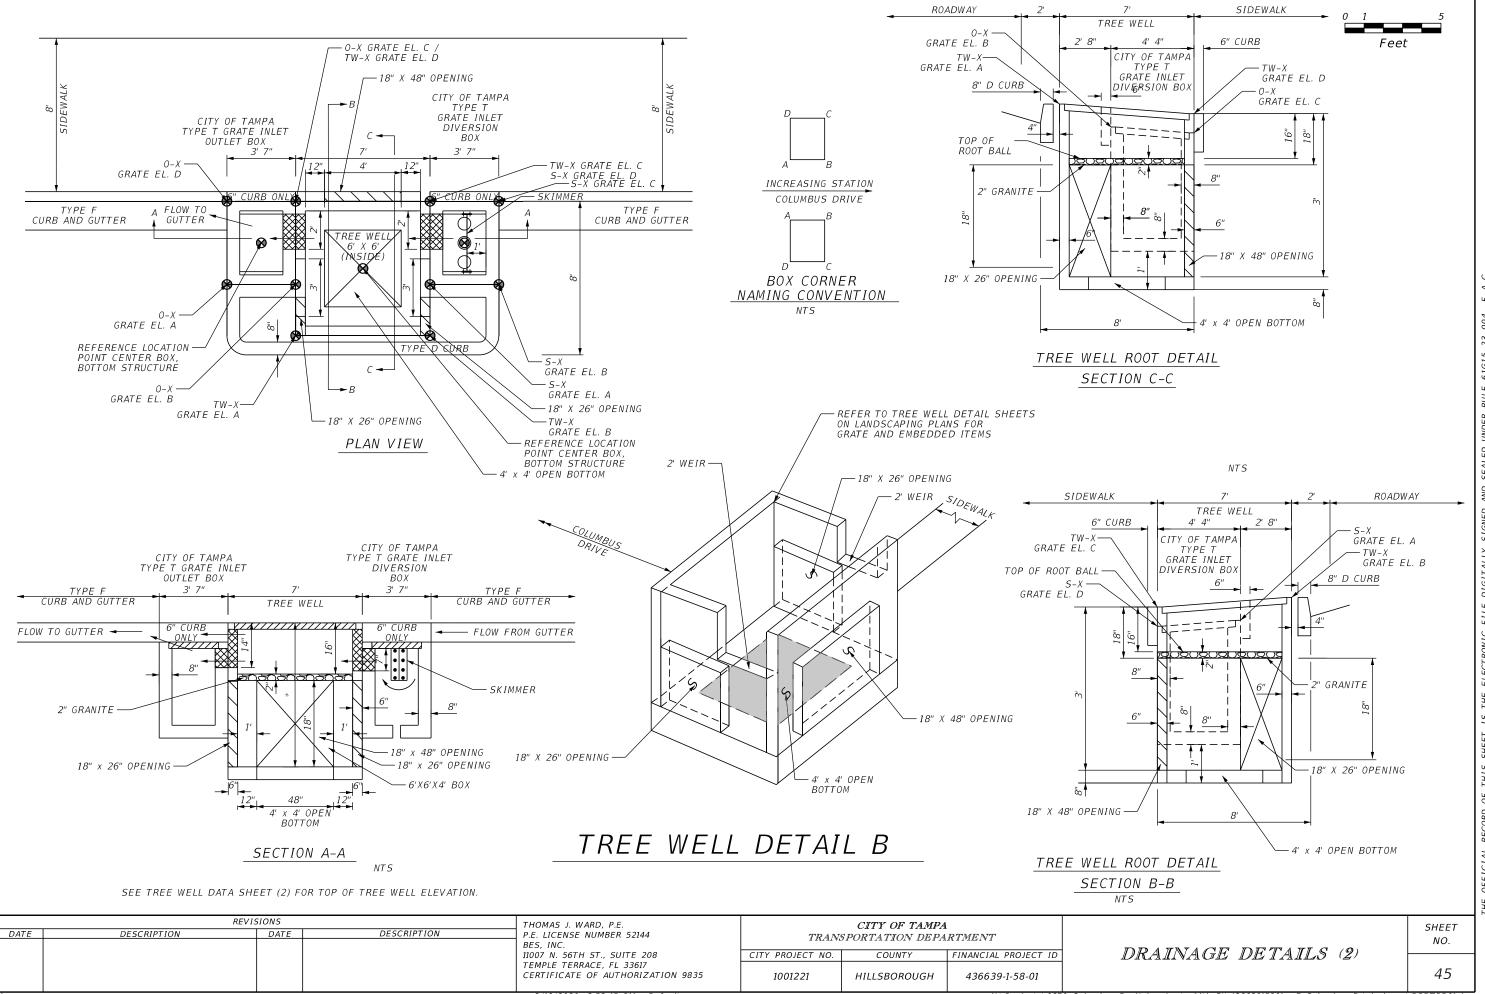

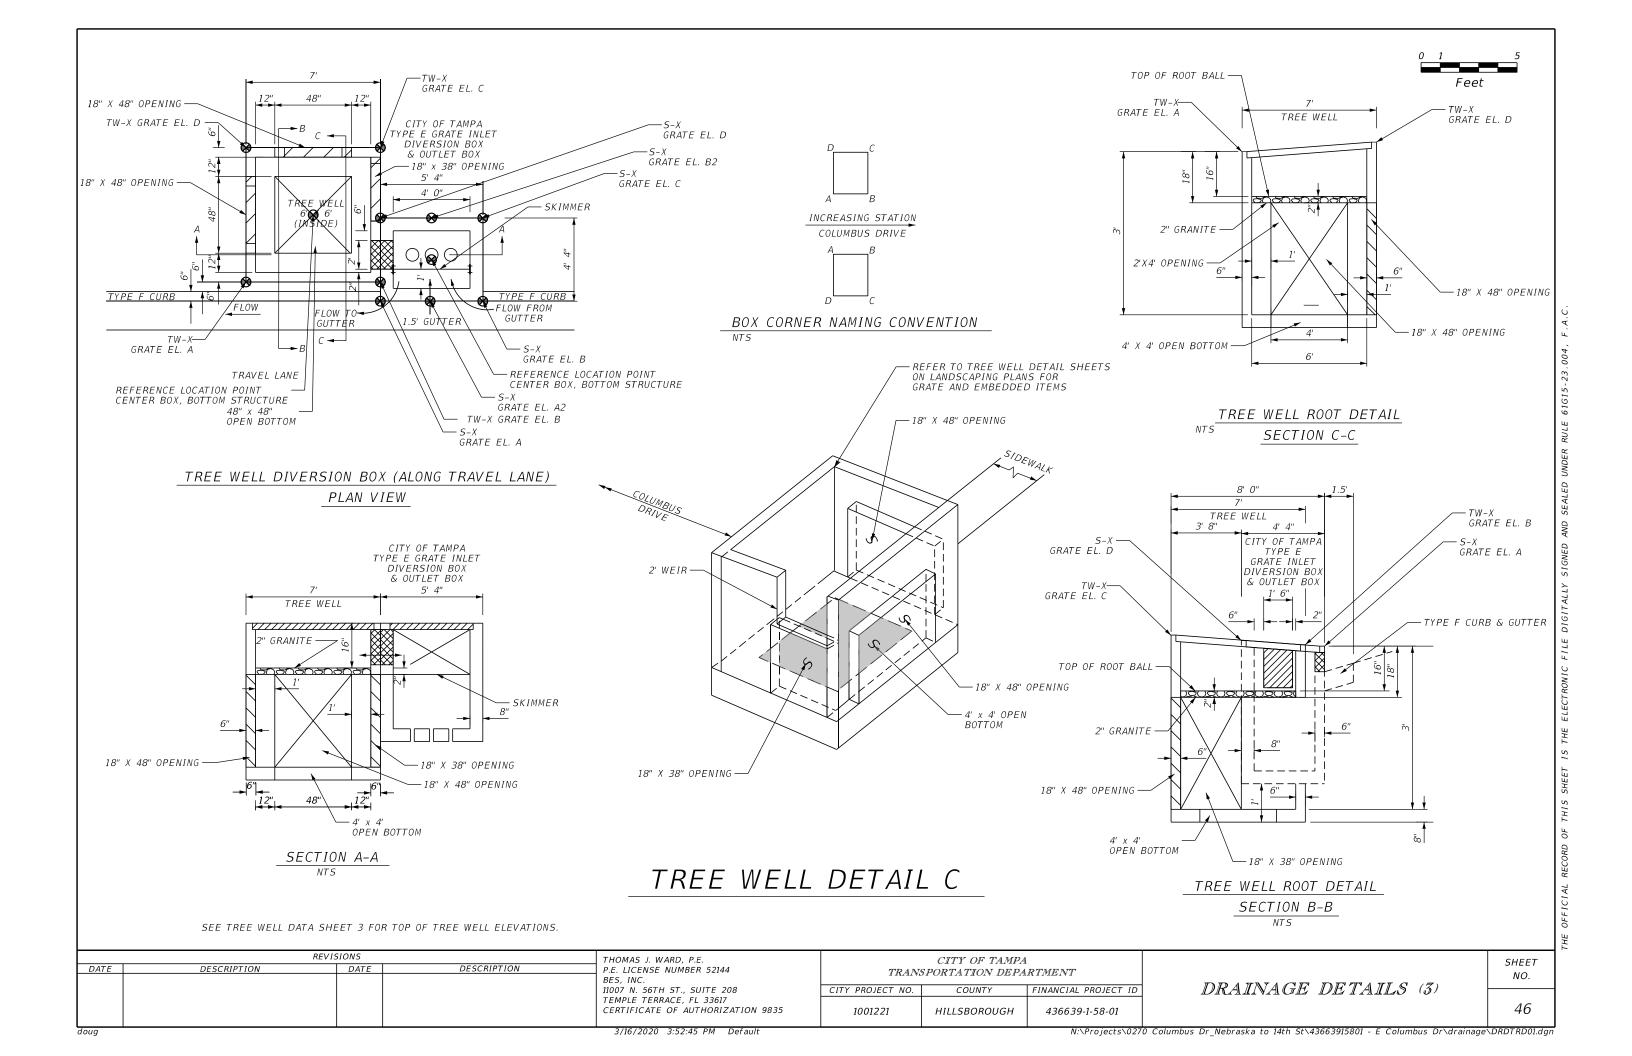

			TREE WE	LL DETAIL D	ATA SHE	ET (SHEET	1 OF 3)				
Detail Type	Diversion Box Structure No.	Station	City Of Tampa Type Grate Inlet	Offset	Side	Pavt /Grate @ El. A	Pavt /Grate @ El. B	Gutter /Grate @ El. C	Gutter /Grate @ El. D	Grate Top Elevation @ Reference Point Location	Interior Structure Bottom Elevation
Tree Well Detail B	S-1	104+02.95	Т	17.60	RT	42.32	42.32	42.12	42.12	42.22	39.62
Tree Well Detail C	S-2	104+13.78	Е	14.64	LT	42.68	42.68	42.76	42.76	42.72	40.18
Tree Well Detail C	S-8	104+76.08	Е	14.66	LT	42.48	42.48	42.58	42.58	42.53	39.98
Tree Well Detail C	S-9	105+11.26	Е	14.63	LT	42.37	42.37	42.45	42.45	42.41	39.87
Tree Well Detail B	S-10	105+11.38	Т	16.79	RT	42.00	42.00	41.80	41.80	41.90	39.30
Tree Well Detail B	S-11	106+26.57	Т	16.68	RT	41.65	41.65	41.45	41.45	41.55	38.95
Tree Well Detail B	S-12	106+38.59	Т	16.83	LT	41.68	41.68	41.48	41.48	41.58	38.98
Tree Well Detail A	S-13	107+37.55	Т	16.83	LT	41.27	41.27	41.21	41.21	41.24	38.71
Tree Well Detail A	S-14	107+37.89	Т	16.92	RT	41.24	41.24	41.20	41.20	41.22	38.70
Tree Well Detail C	S-17	107+68.28	Е	14.67	RT	41.51	41.51	41.53	41.53	41.52	39.01
Tree Well Detail C	S-23	108+10.10	Е	14.67	LT	41.35	41.35	41.35	41.35	41.35	38.85
Tree Well Detail A	S-25	108+51.20	Т	16.84	RT	40.85	40.85	40.75	40.75	40.80	38.25
Tree Well Detail A	S-26	108+80.94	Т	16.83	LT	41.10	41.10	41.00	41.00	41.05	38.50
Tree Well Detail B	S-27	110+18.72	Т	16.80	LT	41.40	41.40	41.34	41.34	41.37	38.84
Tree Well Detail B	S-28	110+81.51	Т	16.77	RT	41.48	41.48	41.30	41.30	41.39	38.80
Tree Well Detail B	S-31	113+14.61	Т	16.80	LT	41.99	41.99	41.81	41.81	41.90	39.31
Tree Well Detail B	S-32	113+34.16	Т	16.79	RT	42.00	42.00	41.80	41.80	41.90	39.30
Tree Well Detail C	S-33	114+21.64	Е	14.67	LT	42.48	42.48	42.52	42.52	42.50	39.98
Tree Well Detail C	S-34	114+91.12	Е	14.68	LT	42.55	42.55	42.61	42.61	42.58	40.05
Tree Well Detail C	S-35	115+77.20	Е	14.67	RT	42.57	42.57	42.63	42.63	42.60	40.07
Tree Well Detail B	S-36	117+26.06	Т	16.97	LT	41.58	41.58	41.38	41.38	41.48	38.88
Tree Well Detail B	S-37	117+30.90	Т	16.98	RT	41.45	41.45	41.23	41.23	41.34	38.73
Tree Well Detail A	S-38	119+21.70	Т	16.87	LT	38.91	38.91	38.93	38.93	38.92	36.41
Tree Well Detail C	S-45	119+98.57	Е	14.67	LT	39.24	39.24	39.28	39.28	39.26	36.74
Tree Well Detail A	S-47	120+40.21	Т	16.83	RT	38.82	38.82	38.84	38.84	38.83	36.32
Tree Well Detail B	S-49	121+26.13	Т	17.76	RT	40.23	40.23	40.05	40.05	41.25	37.55
Tree Well Detail B	S-50	121+81.75	Т	17.76	LT	40.84	40.84	40.66	40.66	40.75	38.16

REVISIONS				THOMAS J. WARD, P.E.	CITY OF TAMPA			
DATE	DESCRIPTION	DATE	DESCRIPTION	P.E. LICENSE NUMBER 52144	TRANS	SPORTATION DEPA	- I	
				BES, INC.   11007 N. 56TH ST., SUITE 208	CITY PROJECT NO.	COUNTY	FINANCIAL PROJECT ID	
				TEMPLE TERRACE, FL 33617 CERTIFICATE OF AUTHORIZATION 9835	1001221	HILLSBOROUGH	436639-1-58-01	

TREE WELL DETAILS
DATA TABLE (1)

SHEET NO. \_\_\_\_\_ THE OFFICIAL RECORD OF THIS SHEET IS THE ELECTRONIC FILE DIGITALLY SIGNED AND SEALED UNDER R

TREE WELL DETAIL DATA SHEET (SHEET 2 OF 3)												
Detail Type	Tree Well Structure No.	Station	FDOT Bottom with 8" Bottom Slab	FDOT Standard Index	Offset	Side	Grate @ El. A	Grate @ El. B	Grate @ El. C	Grate @ El. D	Grate Top Elevation @ Reference Point Location	Interior Structure Bottom Elevation
Tree Well Detail B	TW-1	104+08.16	6'x6'	425-010	15.99	RT	42.75	42.75	42.61	42.61	42.68	39.61
Tree Well Detail C	TW-2	104+07.60	6'x6'	425-010	16.95	LT	42.69	42.69	42.85	42.85	42.77	39.69
Tree Well Detail C	TW-8	104+82.16	6'x6'	425-010	16.99	LT	42.48	42.48	42.62	42.62	42.55	39.48
Tree Well Detail C	TW-9	105+17.42	6'x6'	425-010	16.96	LT	42.38	42.38	42.52	42.52	42.45	39.38
Tree Well Detail B	TW-10	105+16.67	6'x6'	425-010	15.45	RT	42.34	42.34	42.30	43.30	42.32	39.30
Tree Well Detail B	TW-11	106+31.86	6'x6'	425-010	15.35	RT	42.09	42.09	41.95	41.95	42.02	38.95
Tree Well Detail B	TW-12	106+43.89	6'x6'	425-010	15.50	LT	42.10	42.10	41.96	41.96	42.03	38.96
Tree Well Detail A	TW-13	107+42.84	6'x6'	425-010	16.50	LT	41.65	41.65	41.71	41.71	41.68	38.65
Tree Well Detail A	TW-14	107+43.18	6'x6'	425-010	16.58	RT	41.55	41.55	41.65	41.65	41.60	38.55
Tree Well Detail C	TW-17	107+74.45	6'x6'	425-010	17.00	RT	41.52	41.52	41.56	41.56	41.54	38.52
Tree Well Detail C	TW-23	108+03.94	6'x6'	425-010	17.00	LT	41.35	41.35	41.35	41.35	41.35	38.35
Tree Well Detail A	TW-25	108+45.91	6'x6'	425-010	16.50	RT	41.26	41.26	41.34	41.34	41.30	38.26
Tree Well Detail A	TW-26	108+75.64	6'x6'	425-010	16.50	LT	41.43	41.43	41.50	41.50	41.43	38.43
Tree Well Detail B	TW-27	110+13.43	6'x6'	425-010	15.47	LT	41.80	41.80	41.78	41.78	41.79	38.80
Tree Well Detail B	TW-28	110+76.22	6'x6'	425-010	15.44	RT	41.90	41.90	41.80	41.80	41.85	38.90
Tree Well Detail B	TW-31	113+09.32	6'x6'	425-010	15.46	LT	42.40	42.40	42.30	42.30	42.35	39.40
Tree Well Detail B	TW-32	113+28.87	6'x6'	425-010	15.46	RT	42.00	42.00	42.30	42.30	42.35	39.00
Tree Well Detail C	TW-33	114+97.29	6'x6'	425-010	17.01	LT	42.49	42.49	42.55	42.55	42.52	39.49
Tree Well Detail C	TW-34	114+97.29	6'x6'	425-010	17.01	LT	42.56	42.56	42.66	42.66	42.61	39.56
Tree Well Detail C	TW-35	115+83.37	6'x6'	425-010	17.00	RT	42.58	42.58	42.72	42.72	42.65	39.58
Tree Well Detail B	TW-36	117+31.35	6'x6'	425-010	15.65	LT	41.96	41.96	41.82	41.82	41.89	38.96
Tree Well Detail B	TW-37	117+36.19	6'x6'	425-010	15.66	RT	41.85	41.85	41.67	41.67	41.34	38.85
Tree Well Detail A	TW-38	119+27.07	6'x6'	425-010	16.48	LT	39.37	39.37	39.43	39.43	39.40	36.37
Tree Well Detail C	TW-45	120+04.74	6'x6'	425-010	17.00	LT	39.25	39.25	39.31	39.31	39.28	36.25
Tree Well Detail A	TW-47	120+34.92	6'x6'	425-010	16.50	RT	39.29	39.29	39.31	39.31	39.30	36.29
Tree Well Detail B	TW-49	121+20.84	6'x6'	425-010	16.42	RT	40.56	40.56	40.50	40.50	40.53	37.56
Tree Well Detail B	TW-50	121+76.46	6'x6'	425-010	16.43	LT	41.20	41.20	41.10	41.10	41.15	38.20

	REVIS	SIONS		THOMAS J. WARD, P.E.		CITY OF TAMPA		
DATE	DESCRIPTION	DATE	DESCRIPTION	P.E. LICENSE NUMBER 52144 BES. INC.	TRANS	PORTATION DEPA	·	
				11007 N. 56TH ST., SUITE 208	CITY PROJECT NO.	COUNTY	FINANCIAL PROJECT ID	
				TEMPLE TERRACE, FL 33617 CERTIFICATE OF AUTHORIZATION 9835	1001221	HILLSBOROUGH	436639-1-58-01	

TREE WELL DETAILS
DATA TABLE (2)

SHEET NO. THE OFFICIAL RECORD OF THIS SHEET IS THE ELECTRONIC FILE DIGITALLY SIGNED AND SEALED UN

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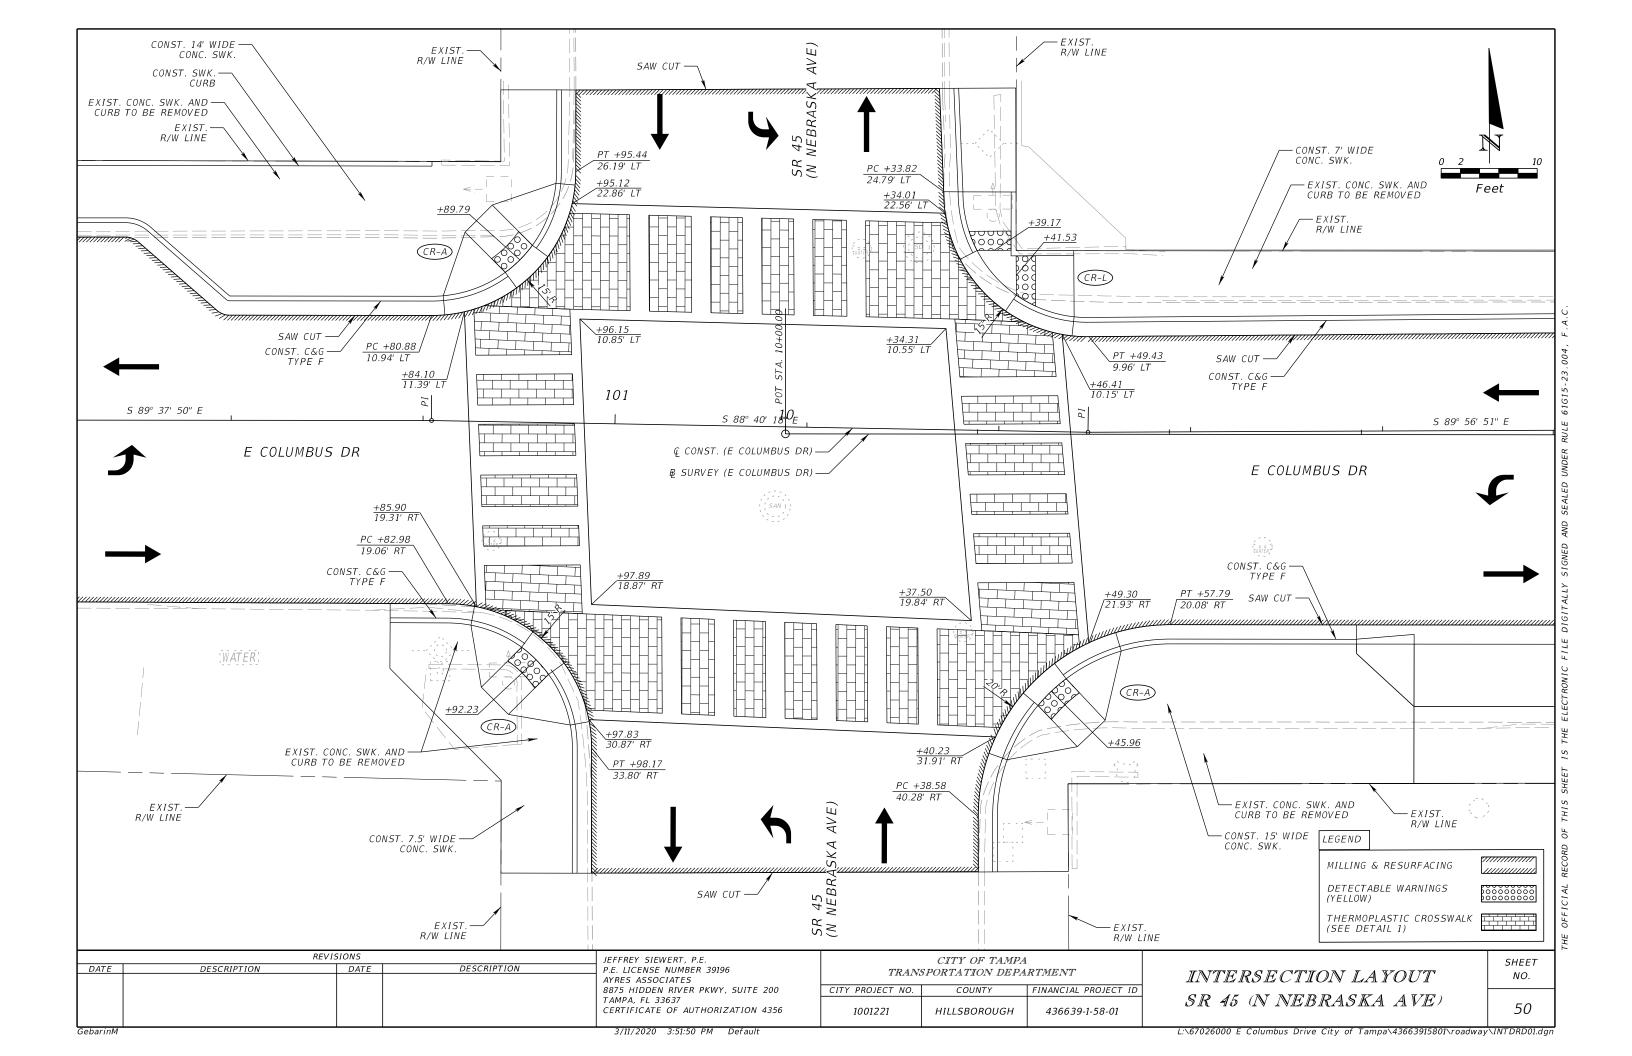
				TRE	E WELL DETAIL	DATA SHEET (SH	IEET 3 OF 3)					
Detail Type	Outlet Box Structure No.	Station	City of Tampa Grate Inlet Type	Offset	Side	Pavt/Grate El. A	Pavt/Grate El. B	Gutter/Grate El . C	Gutter/Grate El . D	Grate Top Elevation @ Reference Point Location	Outlet Pipe Size	Interior Structure Bottom/ Outlet Pipe Invert El.
Tree Well Detail B	0-1	104+13.51	Т	17.03	RT	42.30	42.30	42.11	42.11	42.20	NA	39.61
Tree Well Detail C	S-2	104+13.78	E	14.64	LT	42.68	42.68	42.76	42.76	42.72	NA	40.18
Tree Well Detail C	S-8	104+76.08	E	14.66	LT	42.48	42.48	42.58	42.58	42.53	NA	39.98
Tree Well Detail C	S-9	105+11.26	E	14.63	LT	42.37	42.37	42.45	42.45	42.41	NA	39.87
Tree Well Detail B	0-10	105+21.96	Т	16.78	RT	41.96	41.96	41.80	41.80	41.88	NA	39.30
Tree Well Detail B	O-11	106+37.16	Т	16.69	RT	41.63	41.63	41.43	41.43	41.53	NA	38.93
Tree Well Detail B	0-12	106+49.18	Т	16.83	LT	41.64	41.64	41.45	41.45	41.55	NA	38.95
Tree Well Detail A	0-13	107+48.14	Т	16.83	LT	41.64	41.64	41.70	41.70	41.67	15.00	39.14
Tree Well Detail A	O-14	107+48.47	Т	16.89	RT	41.62	41.62	41.64	41.64	41.63	15.00	39.12
Tree Well Detail C	S-17	107+68.28	E	14.67	RT	41.51	41.51	41.53	41.53	41.52	NA	39.01
Tree Well Detail C	S-23	108+10.10	E	14.67	LT	41.35	41.35	41.35	41.35	41.35	NA	38.85
Tree Well Detail A	0-25	108+40.62	Т	16.83	RT	41.28	41.28	41.34	41.34	41.31	18.00	38.78
Tree Well Detail A	O-26	108+70.35	Т	16.83	LT	41.42	41.42	41.48	41.48	41.45	15.00	38.92
Tree Well Detail B	0-27	110+08.14	Т	16.80	LT	41.38	41.38	41.20	41.20	41.29	NA	38.70
Tree Well Detail B	O-28	110+70.93	Т	16.77	RT	41.47	41.47	41.27	41.27	41.38	NA	38.77
Tree Well Detail B	0-31	113+04.03	Т	16.80	LT	41.97	41.97	41.79	41.79	41.88	NA	39.29
Tree Well Detail B	0-32	113+23.58	Т	16.80	RT	41.97	41.97	41.79	41.79	41.88	NA	39.29
Tree Well Detail C	S-33	114+21.64	E	14.67	LT	42.48	42.48	42.52	42.52	42.50	NA	39.98
Tree Well Detail C	S-34	114+91.12	E	14.68	LT	42.55	42.55	42.61	42.61	42.58	NA	40.05
Tree Well Detail C	S-35	115+77.20	E	14.67	RT	42.57	42.57	42.63	42.63	42.60	NA	40.07
Tree Well Detail B	O-36	117+36.64	Т	16.99	LT	41.44	41.44	41.24	41.24	41.34	NA	38.74
Tree Well Detail B	0-37	117+41.48	Т	17.00	RT	41.33	41.33	41.17	41.17	41.25	NA	38.67
Tree Well Detail A	O-38	119+32.29	Т	16.88	LT	39.39	39.39	39.41	39.41	39.40	15.00	36.89
Tree Well Detail C	S-45	119+98.57	E	14.67	LT	39.24	39.24	39.28	39.28	39.26	NA	36.78
Tree Well Detail A	O-47	120+29.63	Т	16.83	RT	39.30	39.30	39.30	39.30	39.30	18.00	36.80
Tree Well Detail B	O-49	121+15.55	Т	17.75	RT	40.08	40.08	39.90	39.90	39.99	NA	37.40
Tree Well Detail B	0-51	121+71.17	Т	17.76	LT	40.71	40.71	40.53	40.53	40.62	NA	38.03


R	THOMAS J. WARD, P.E.		
DESCRIPTION	DATE	DESCRIPTION	P.E. LICENSE NUMBER 52144
			BES, INC.
			11007 N. 56TH ST., SUITE 208   TEMPLE TERRACE, FL 33617
			CERTIFICATE OF AUTHORIZATION 9835
	•	REVISIONS  DESCRIPTION  DATE	


CITY OF TAMPA TRANSPORTATION DEPARTMENT						
CITY PROJECT NO.	COUNTY	FINANCIAL PROJECT ID				
1001221	HILLSBOROUGH	436639-1-58-01				


TREE WELL DETAILS


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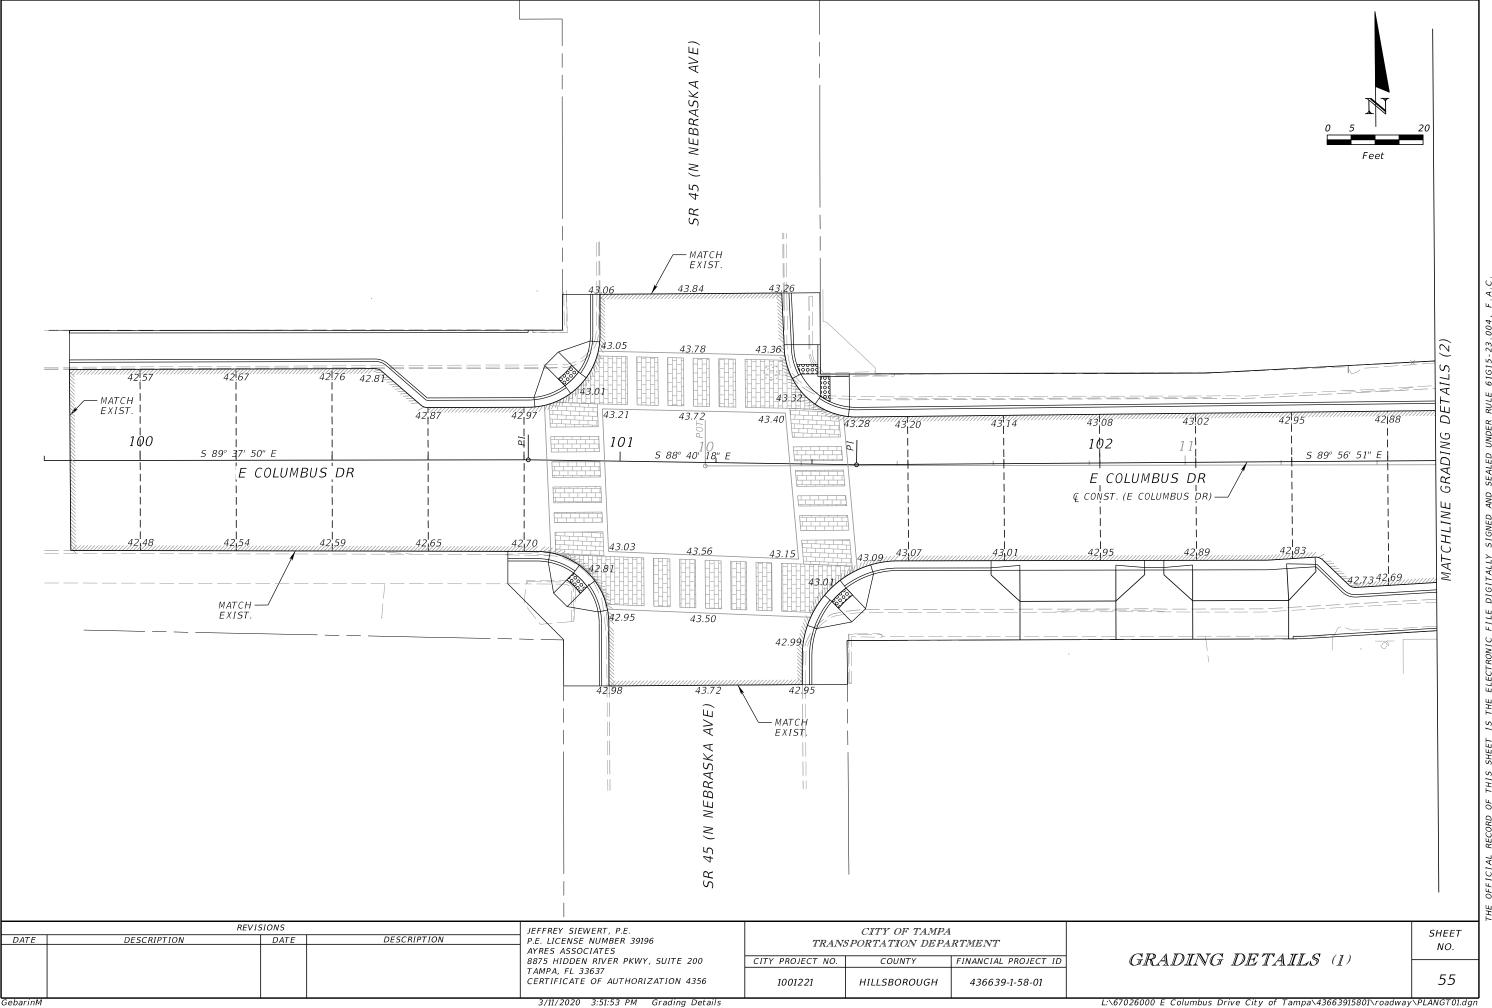





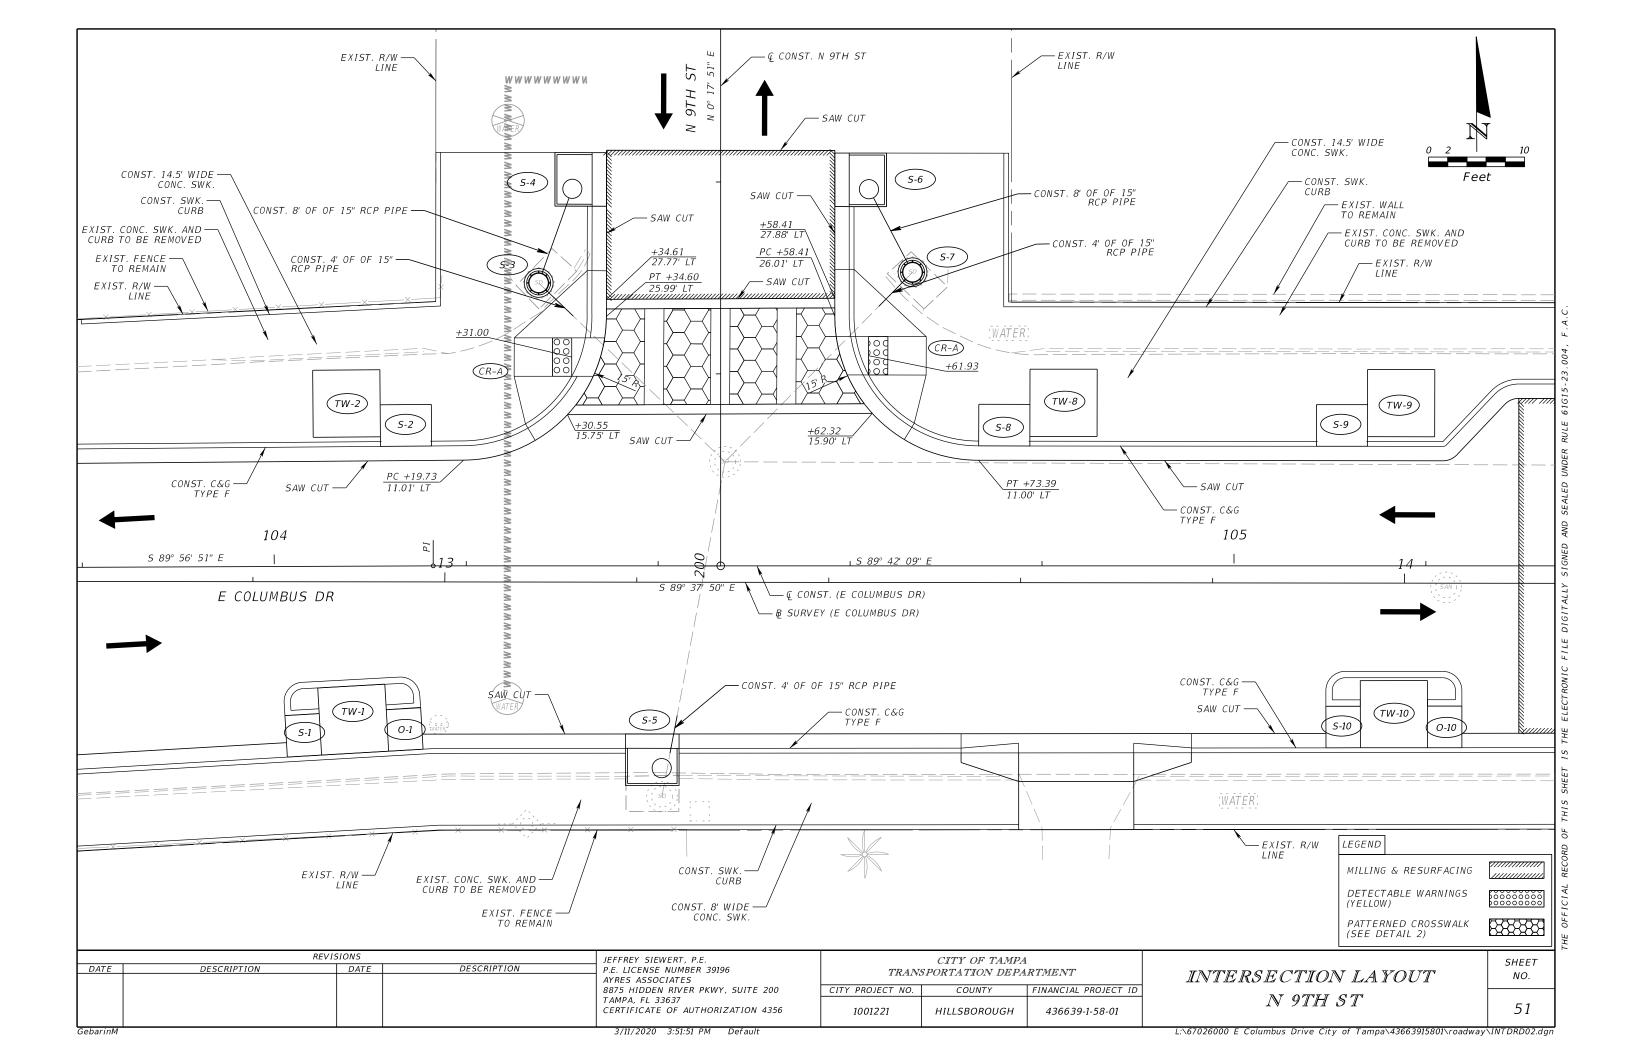


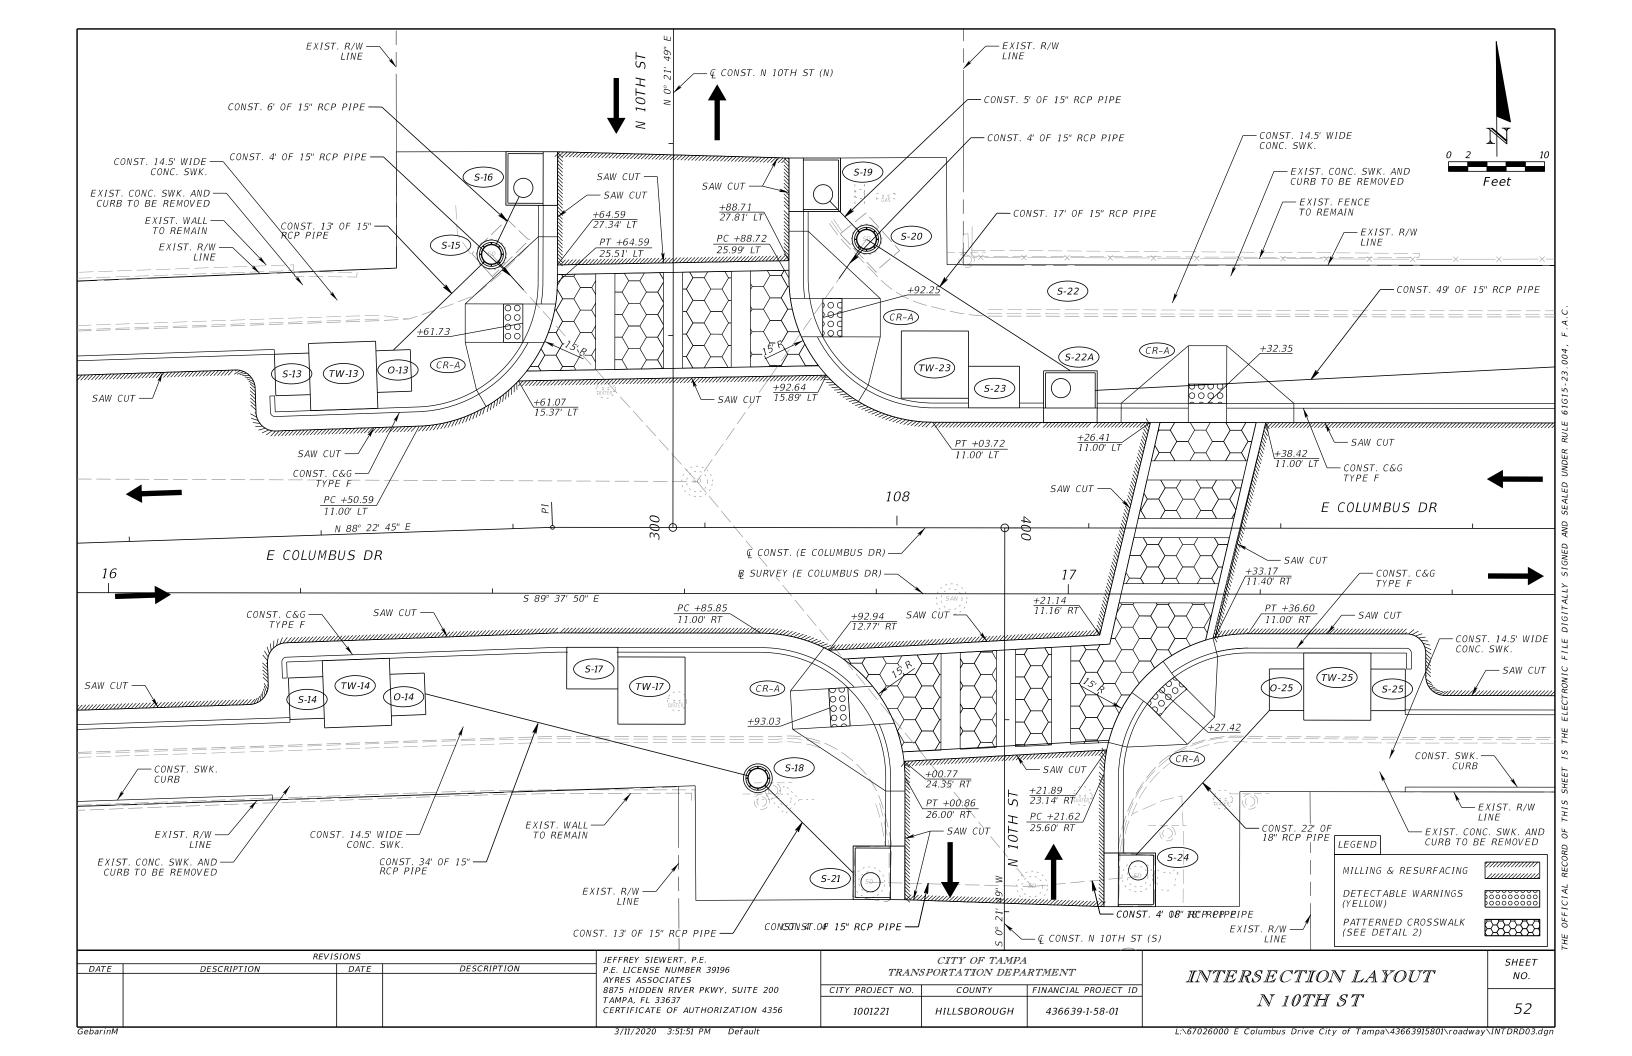


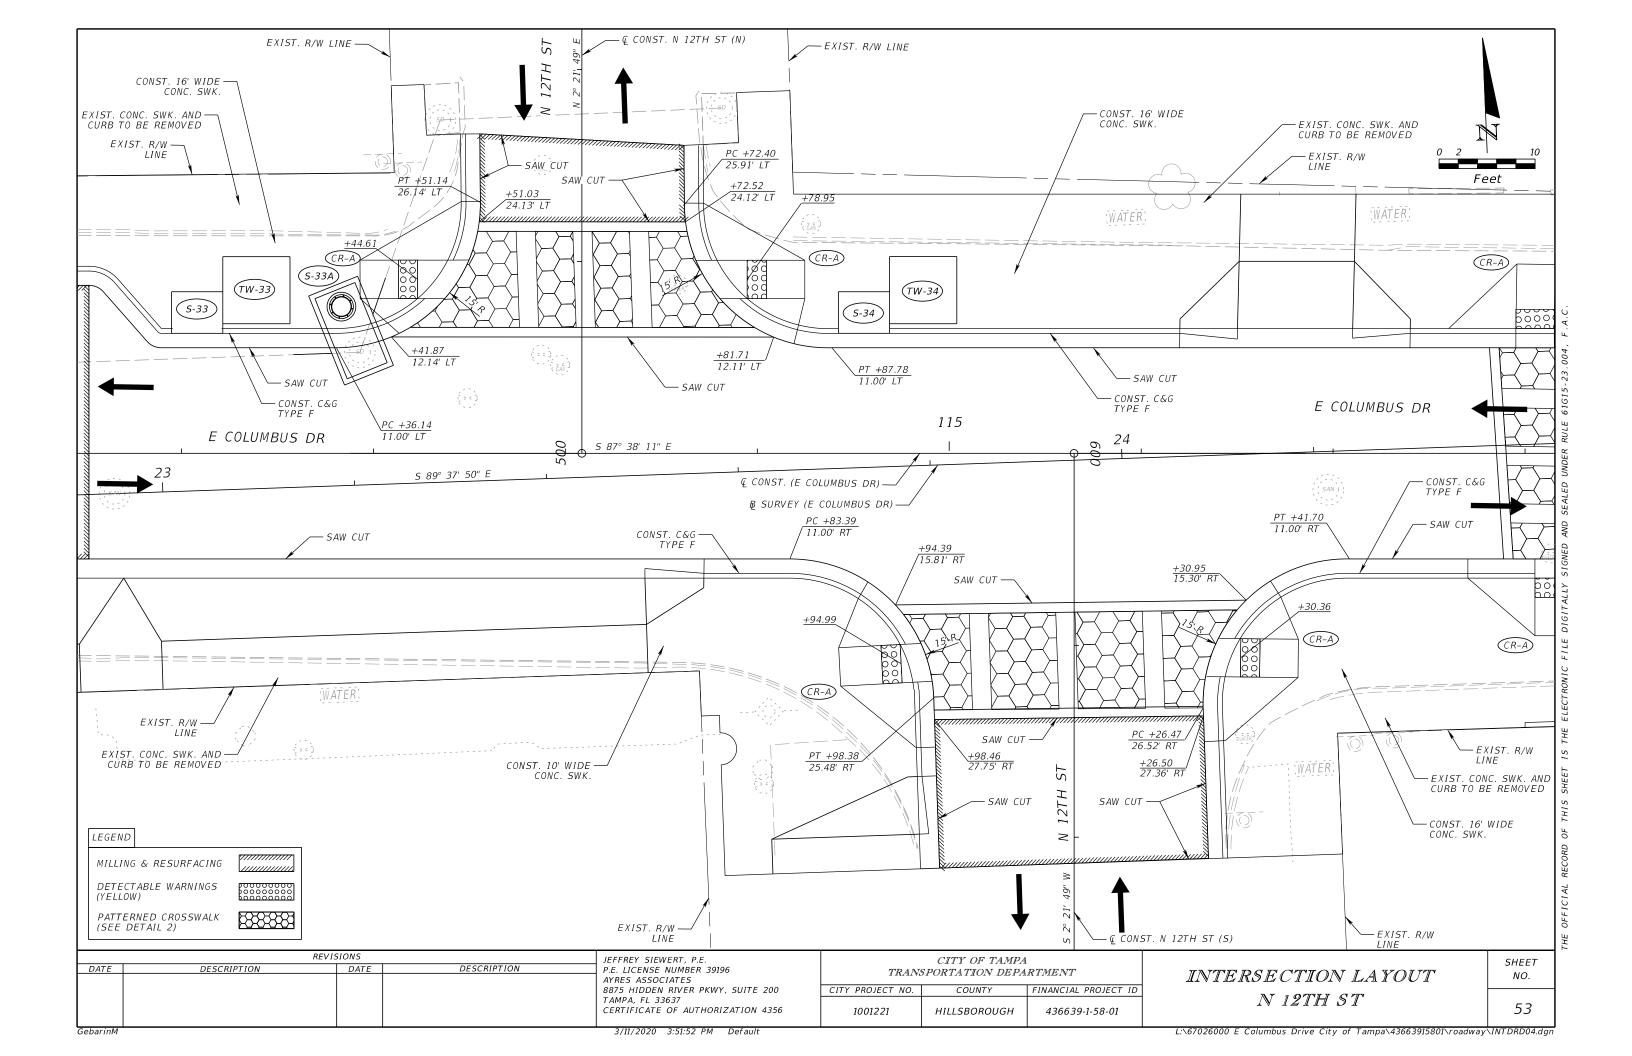

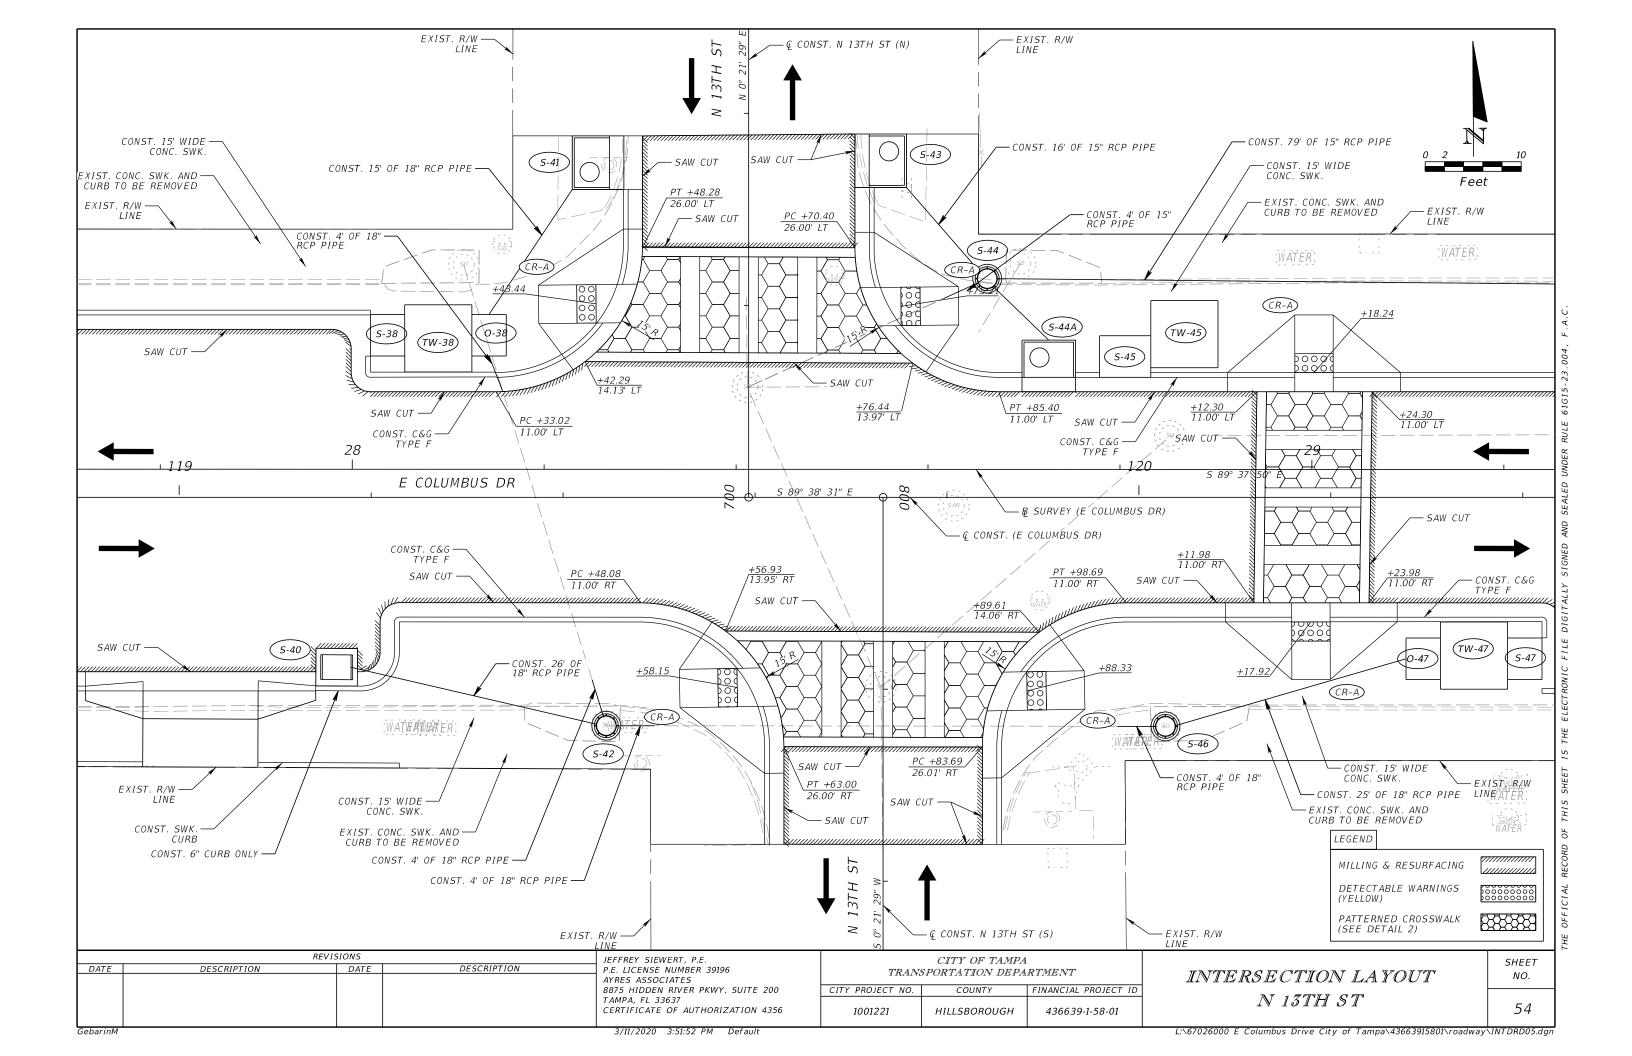

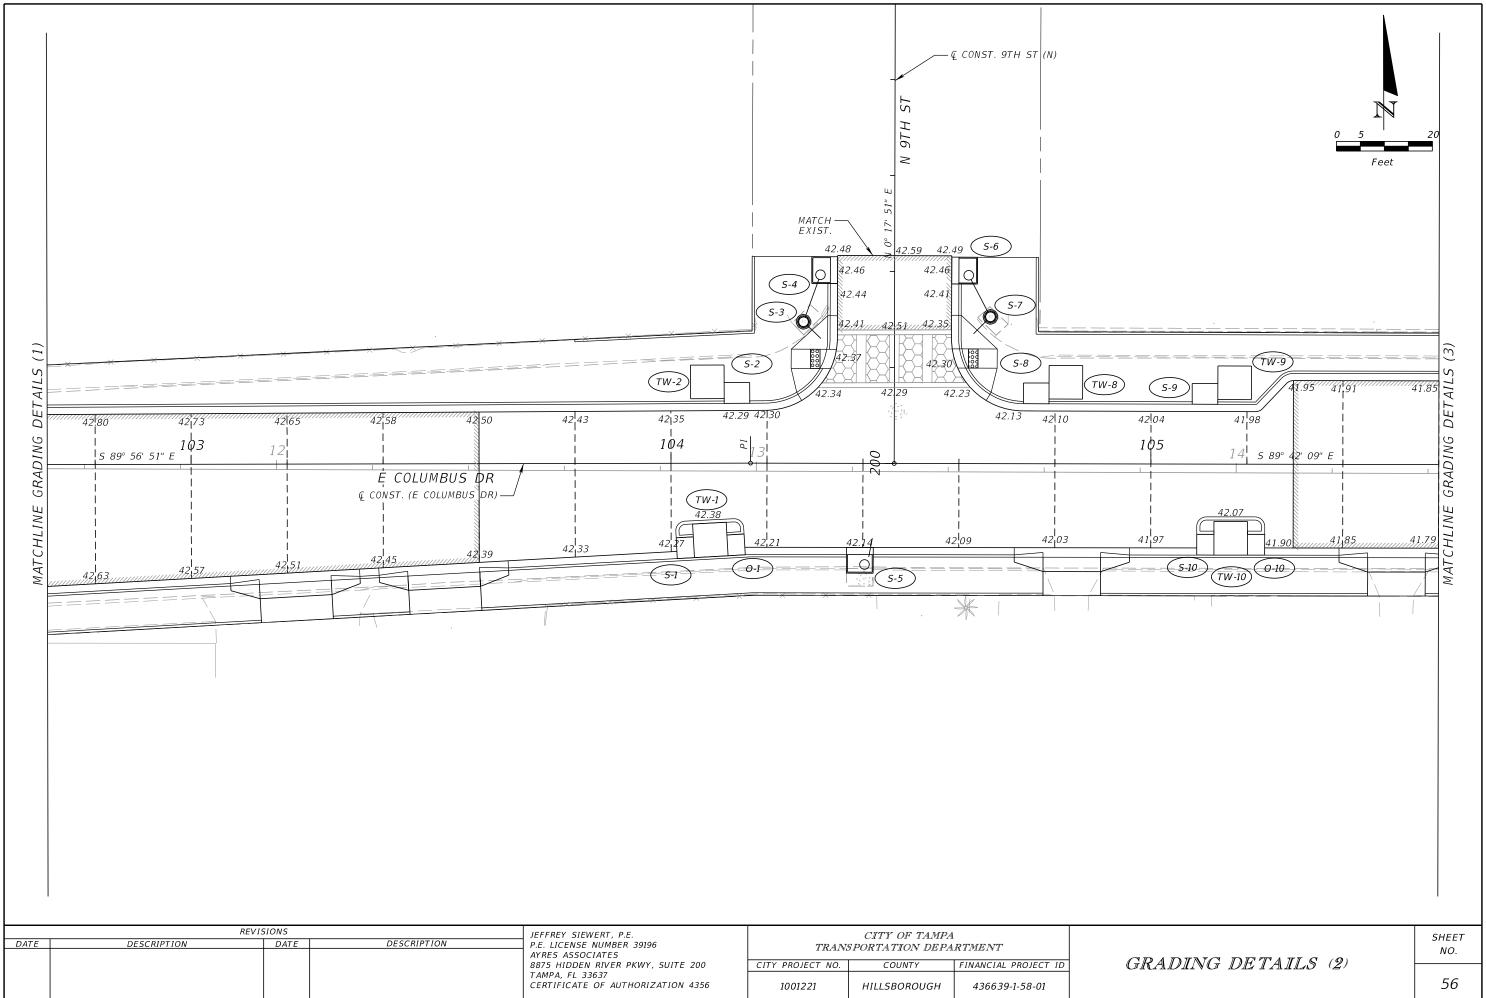


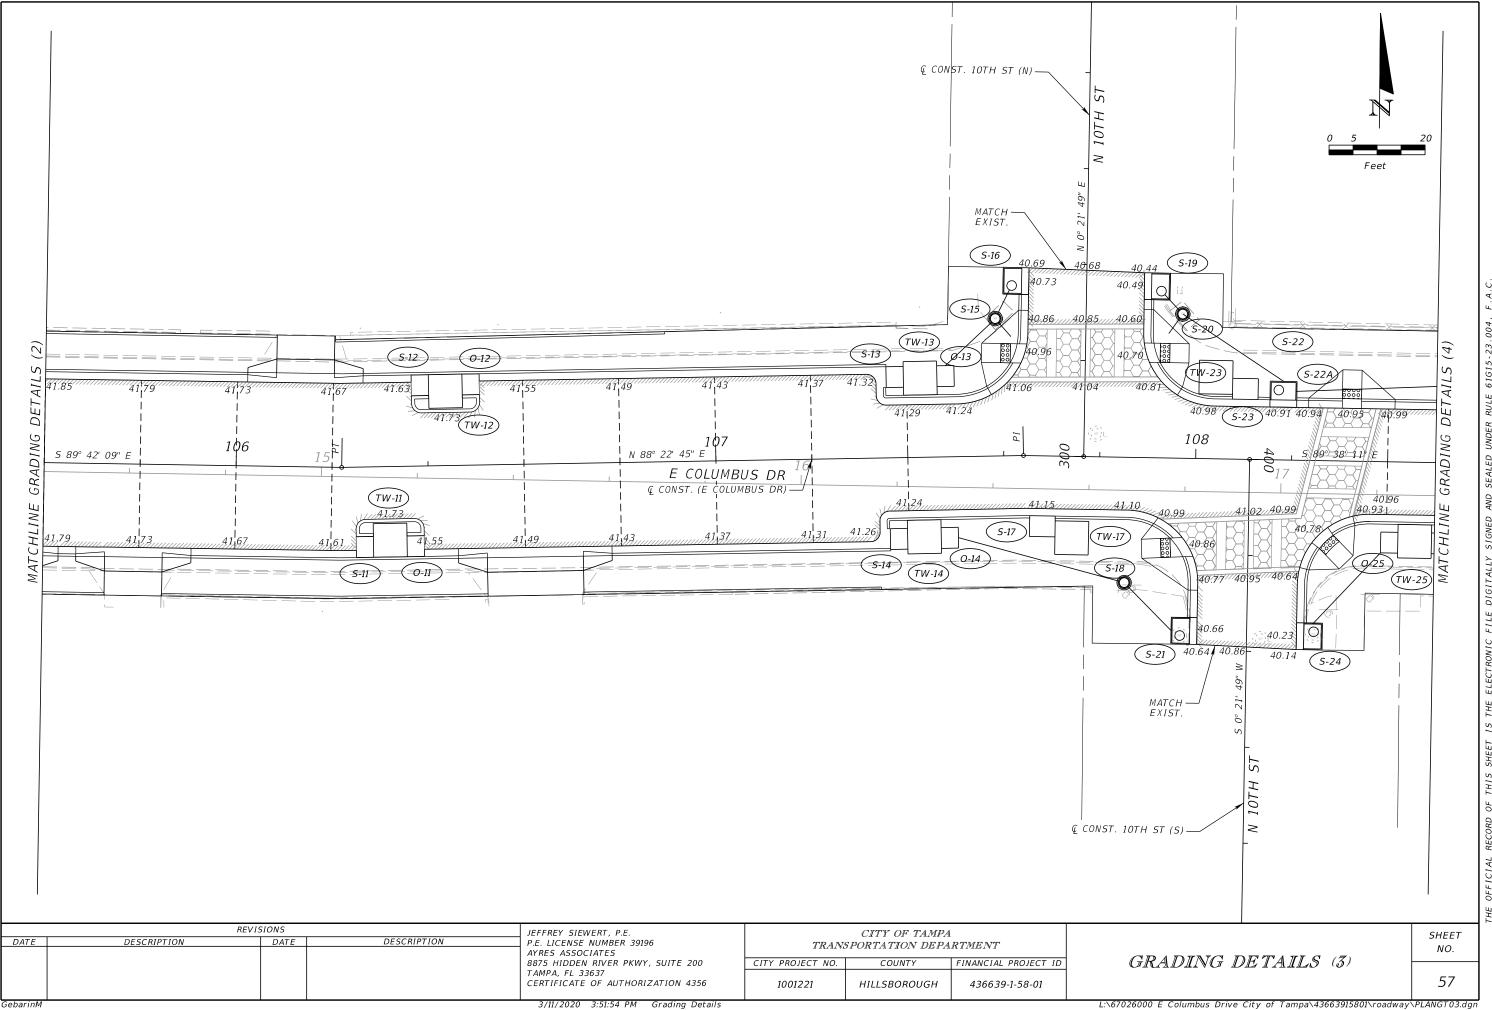

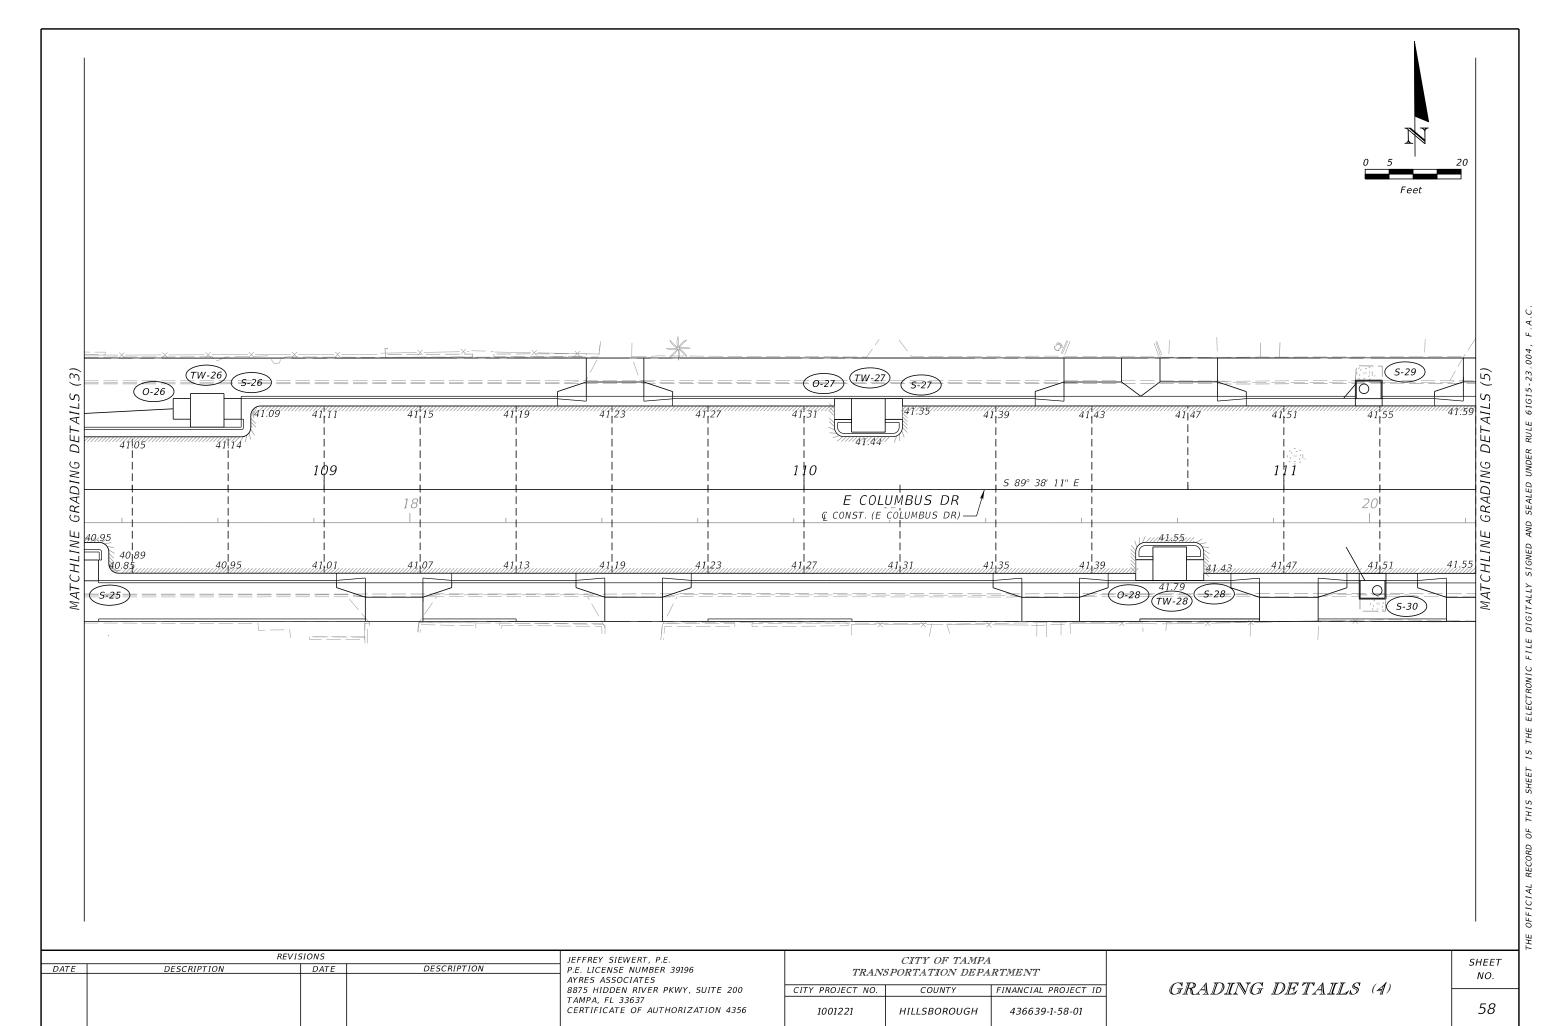


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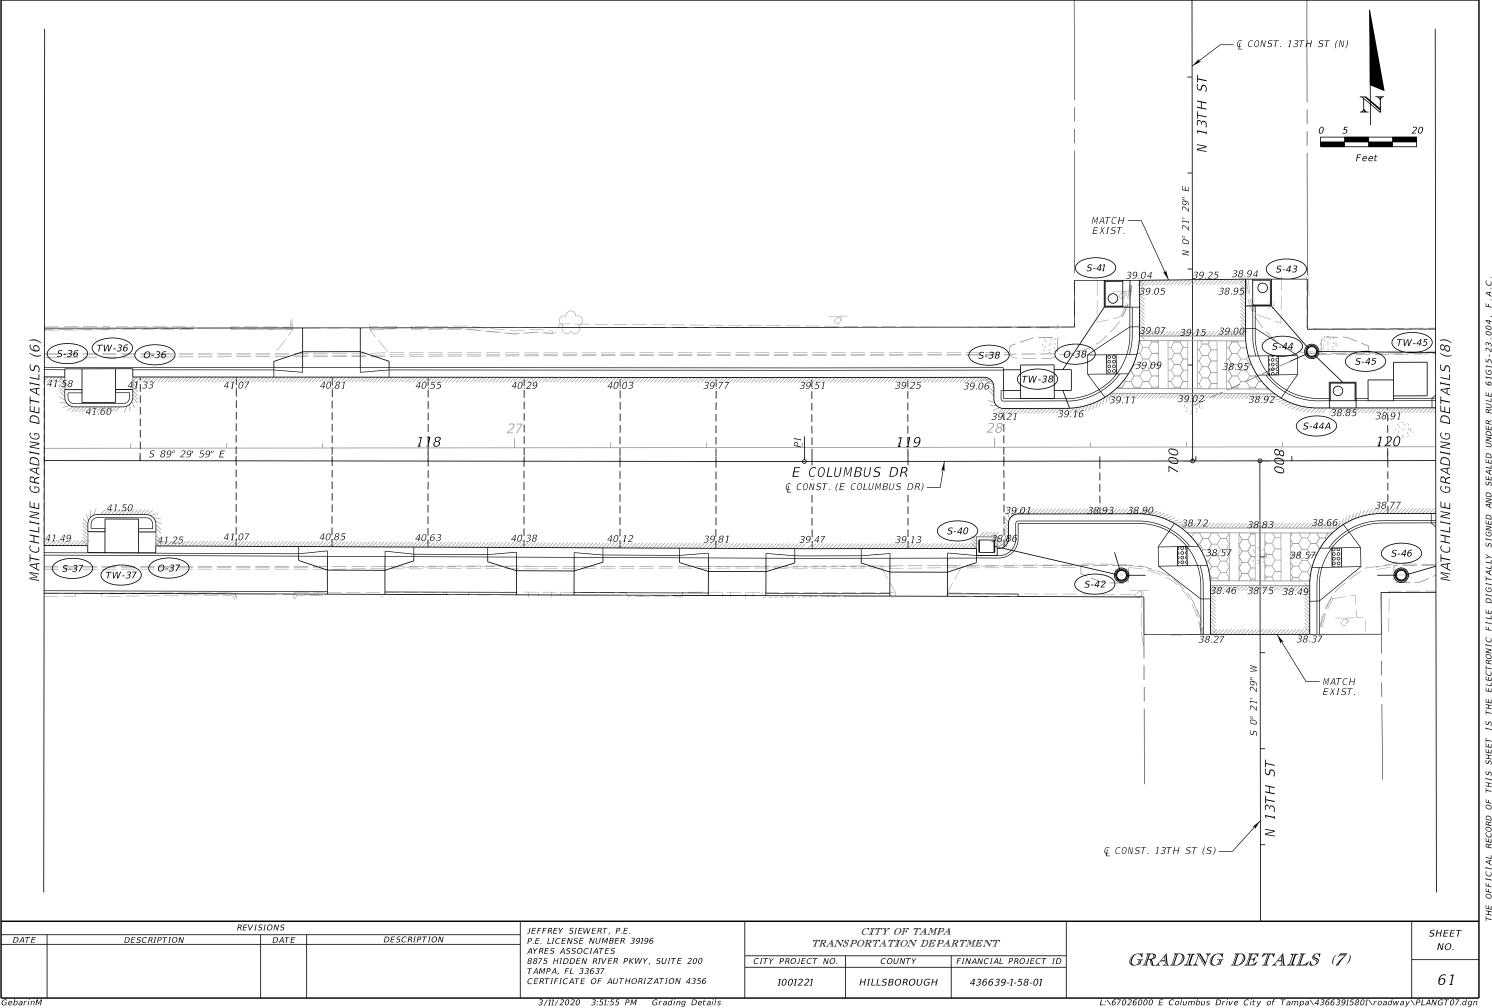
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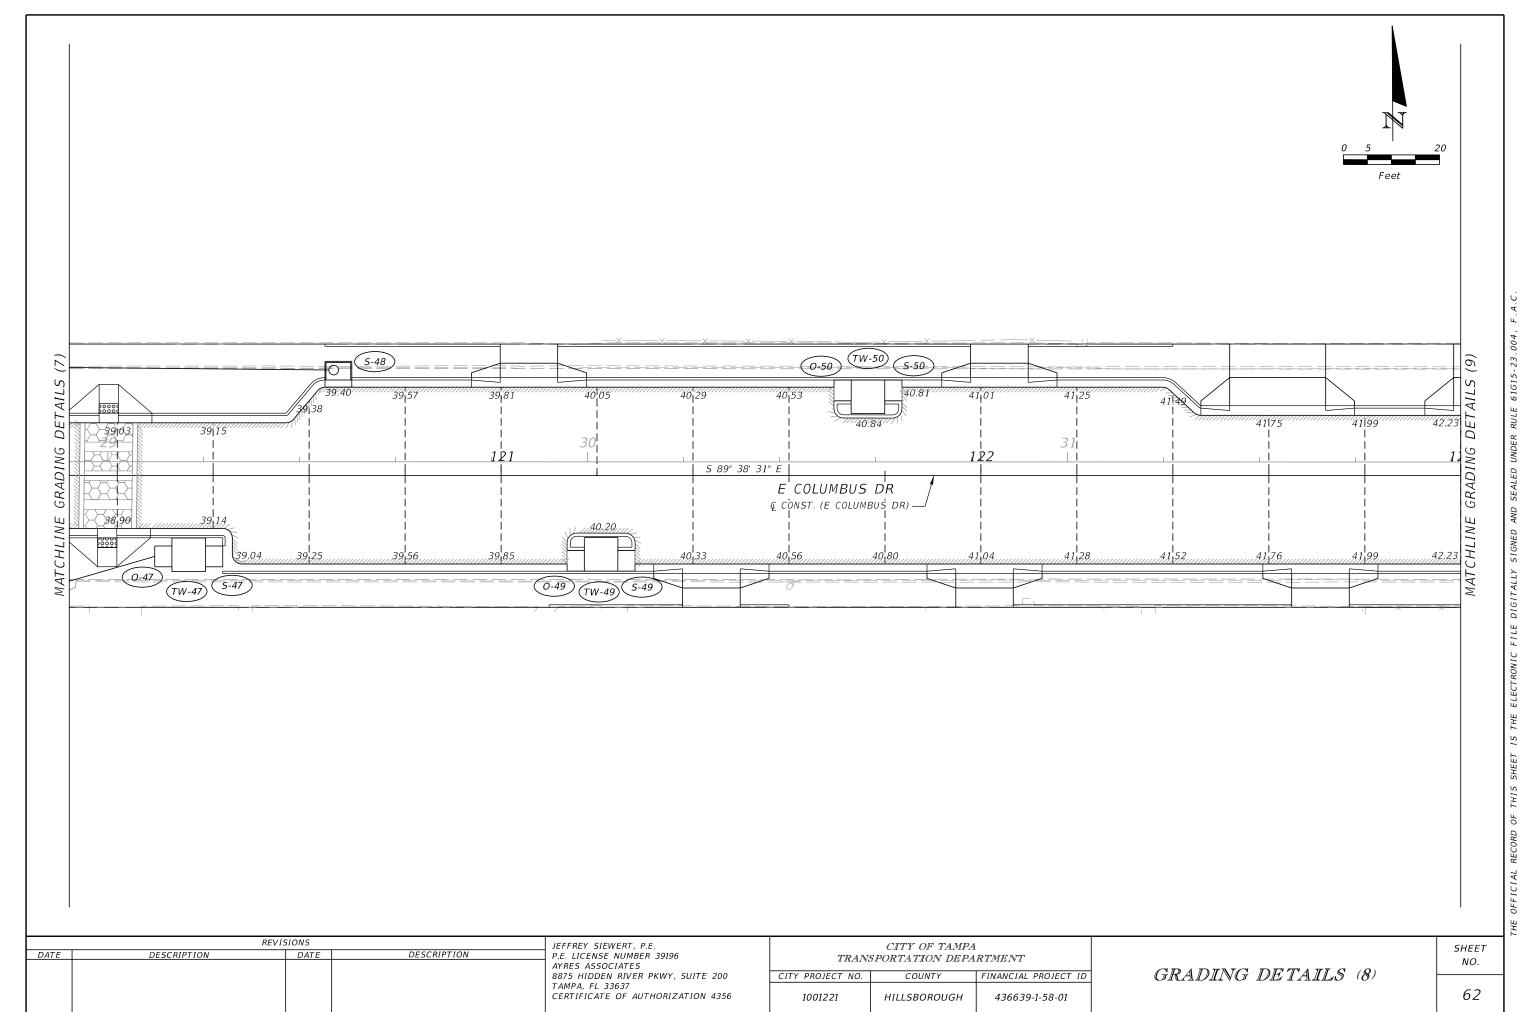


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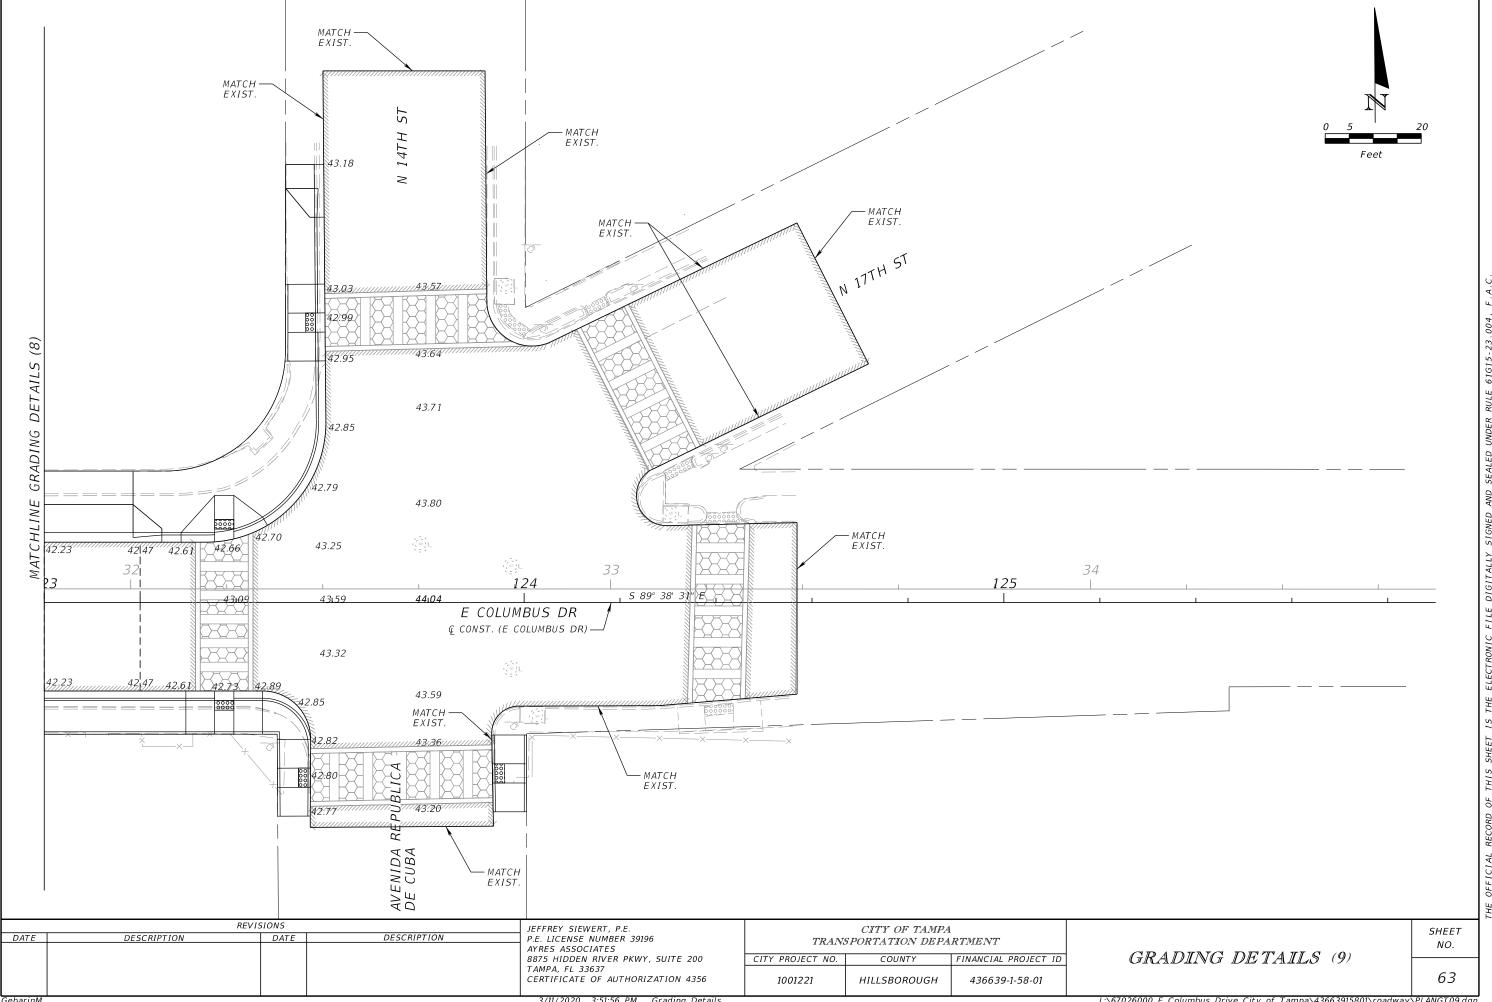


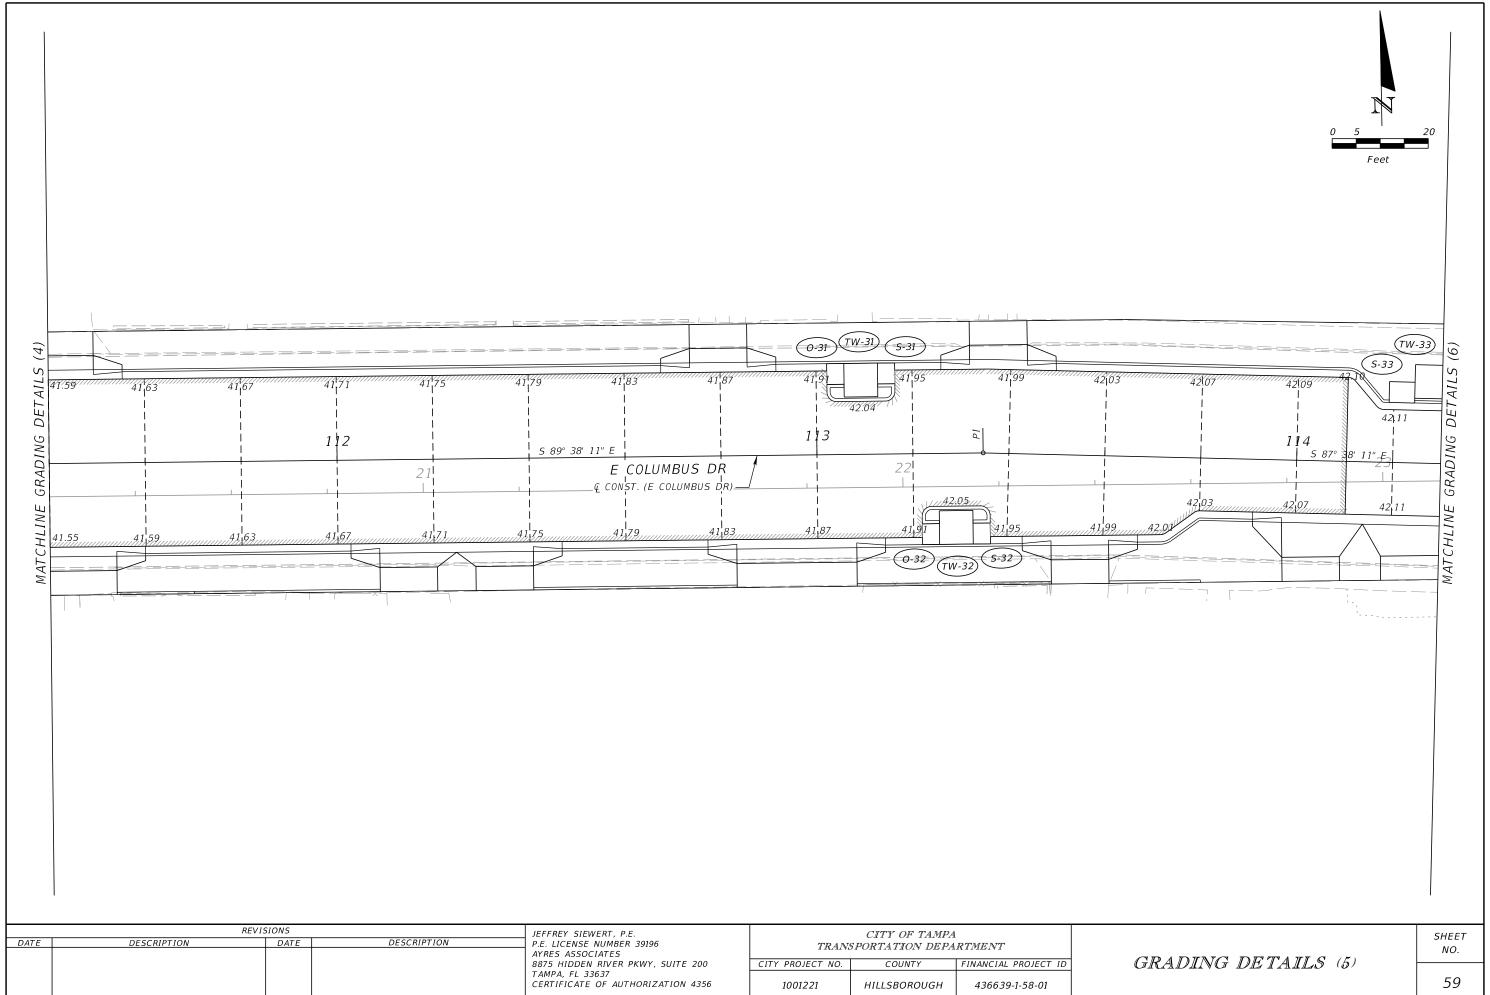



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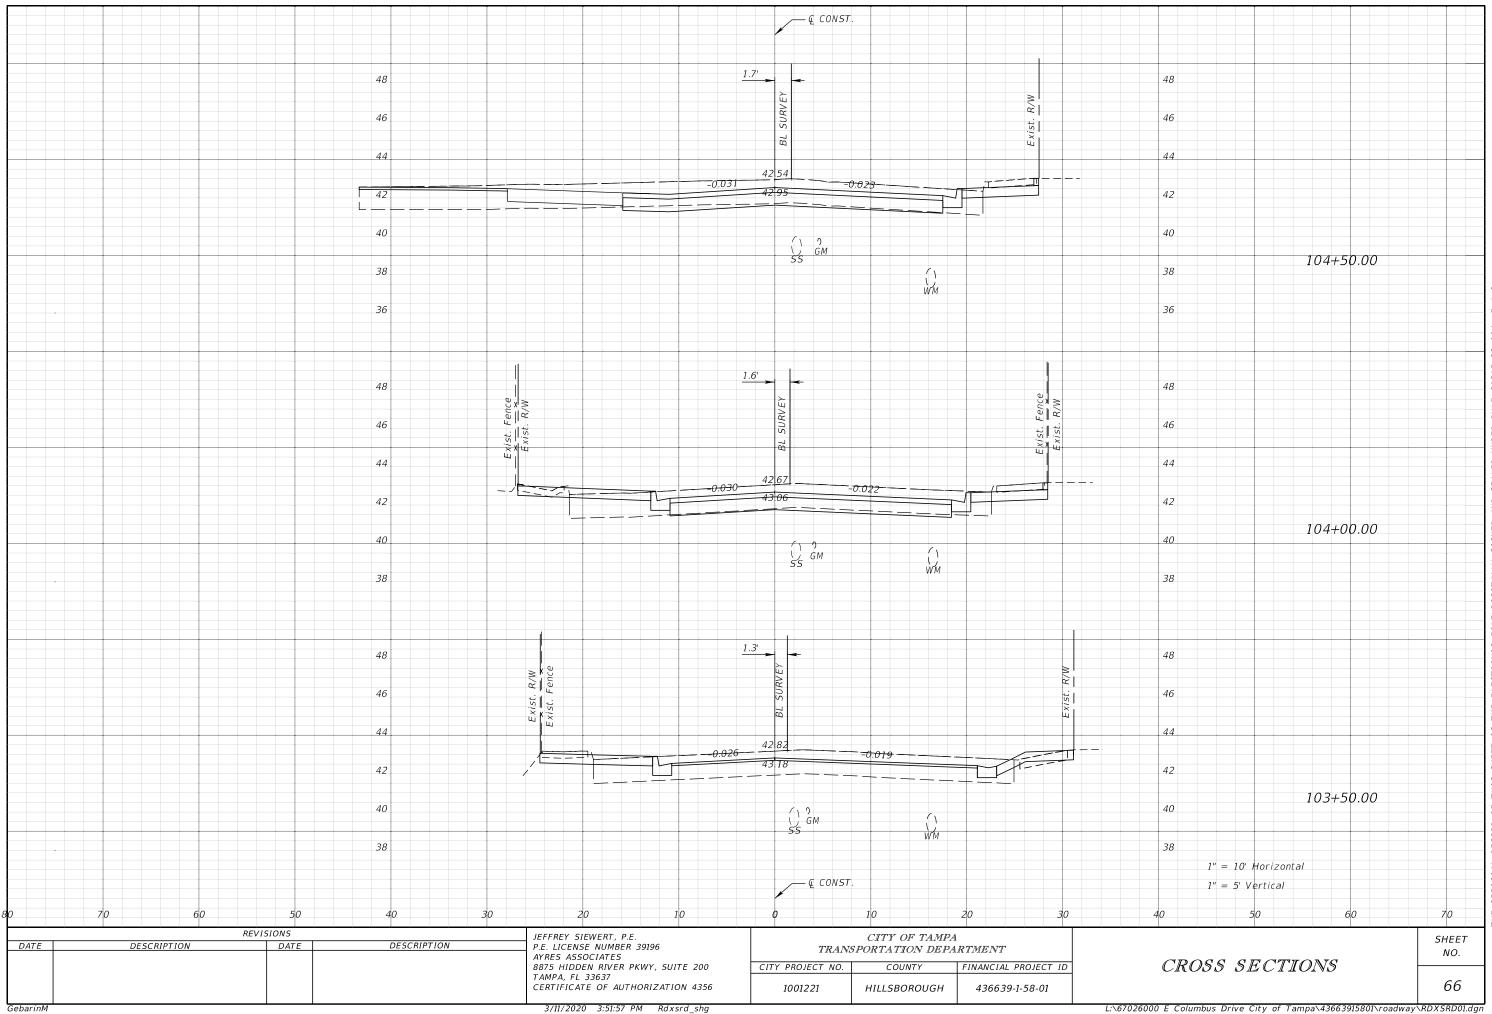
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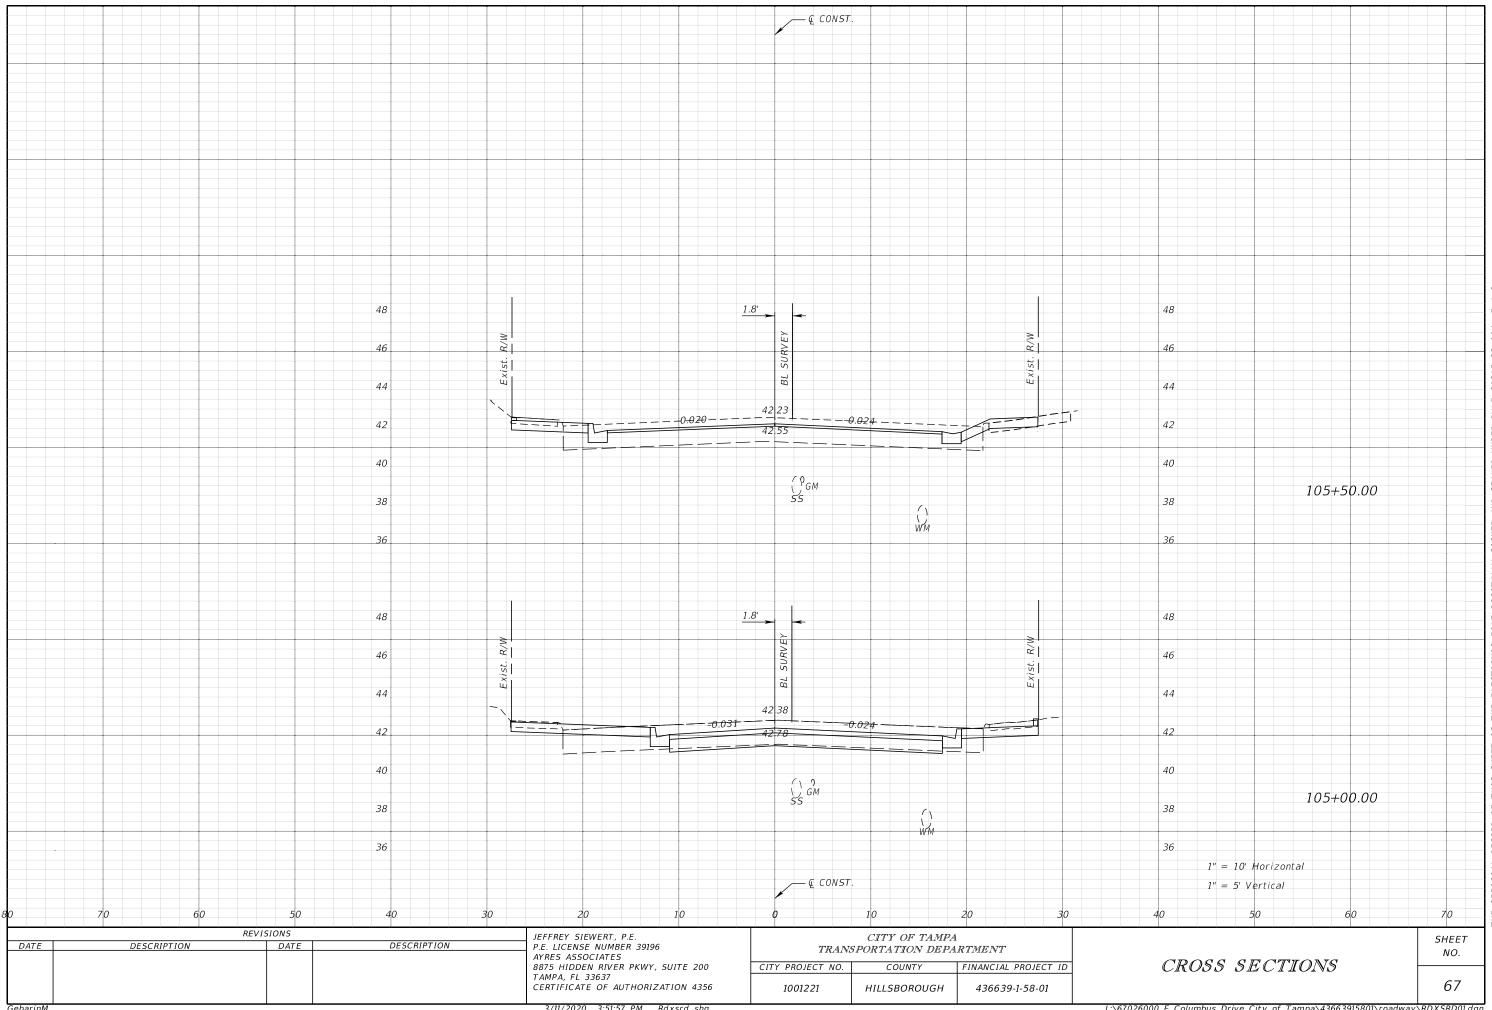
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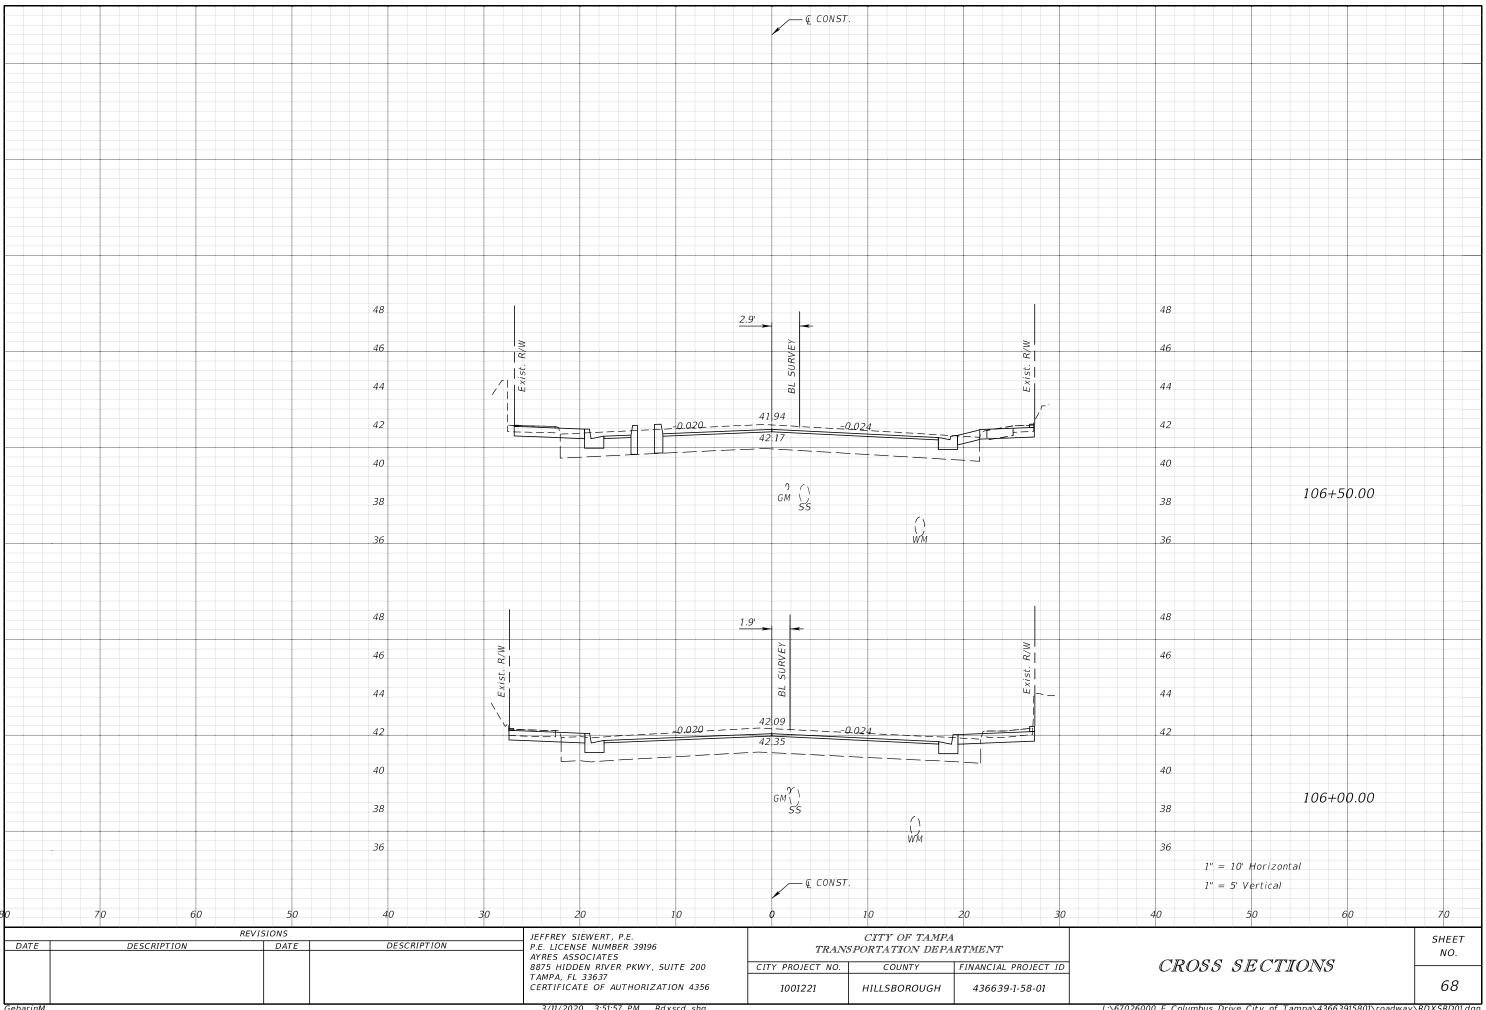





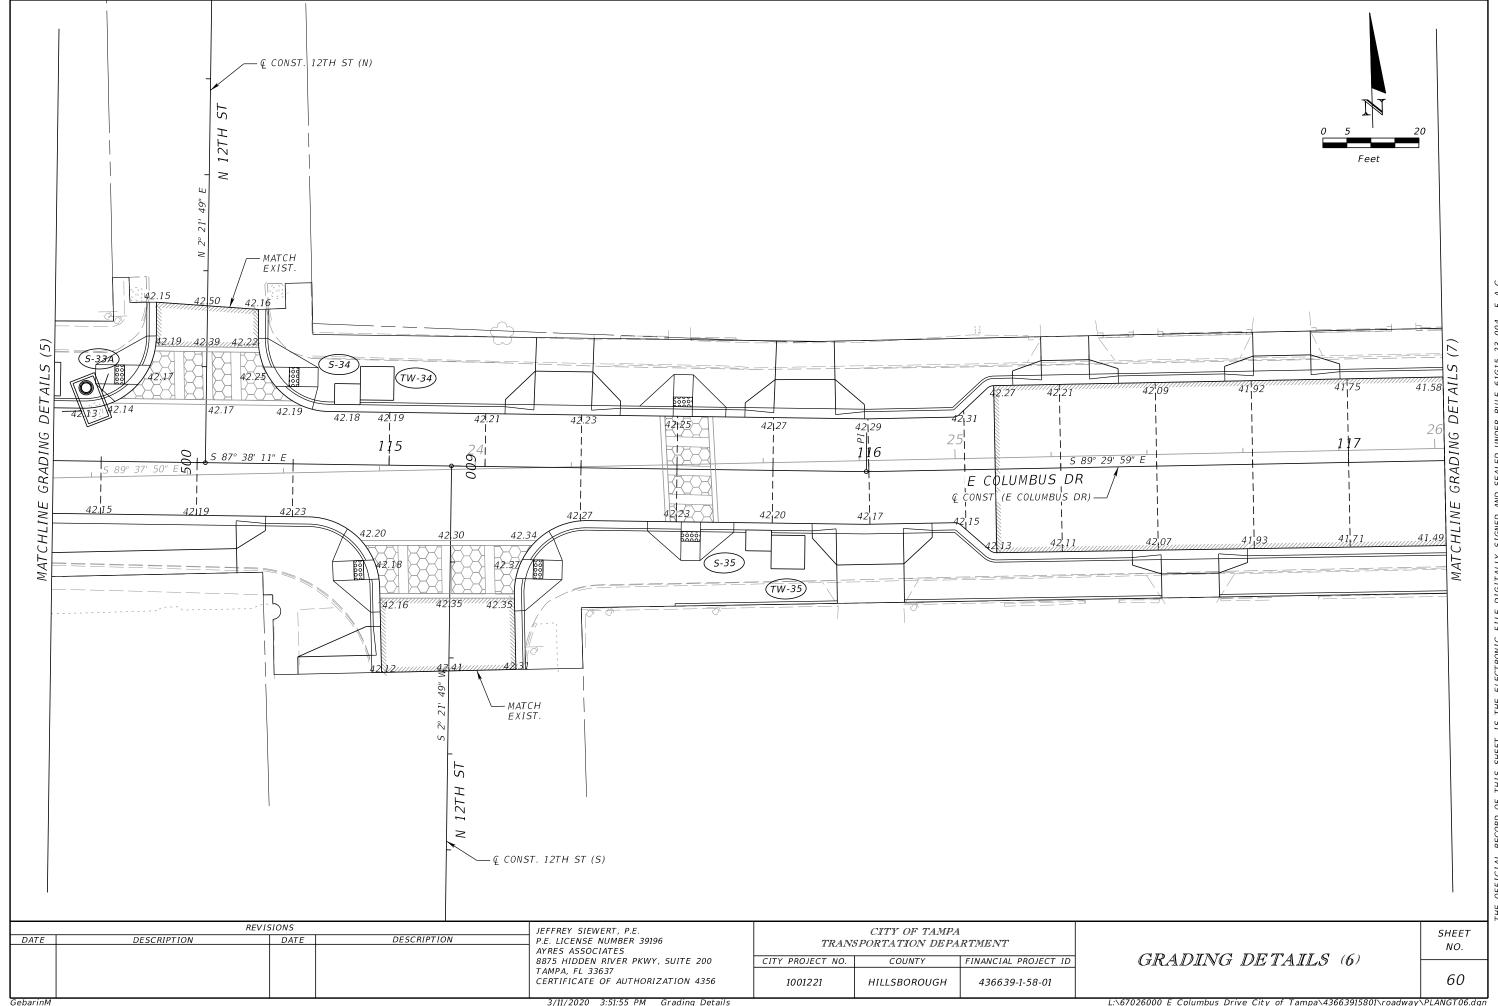





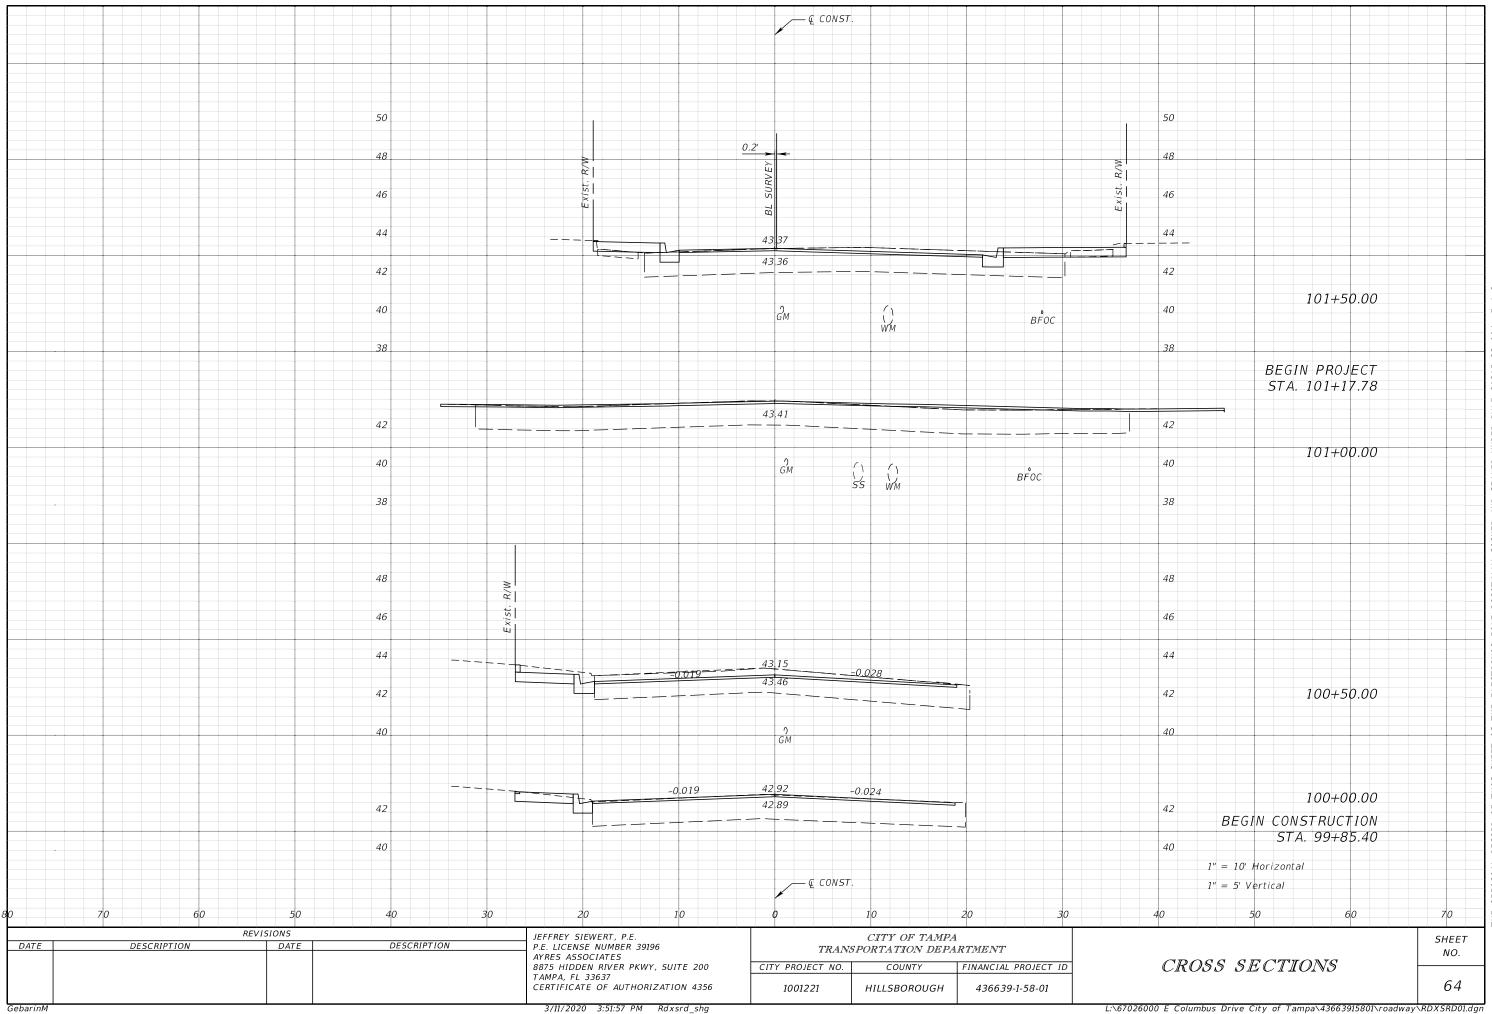


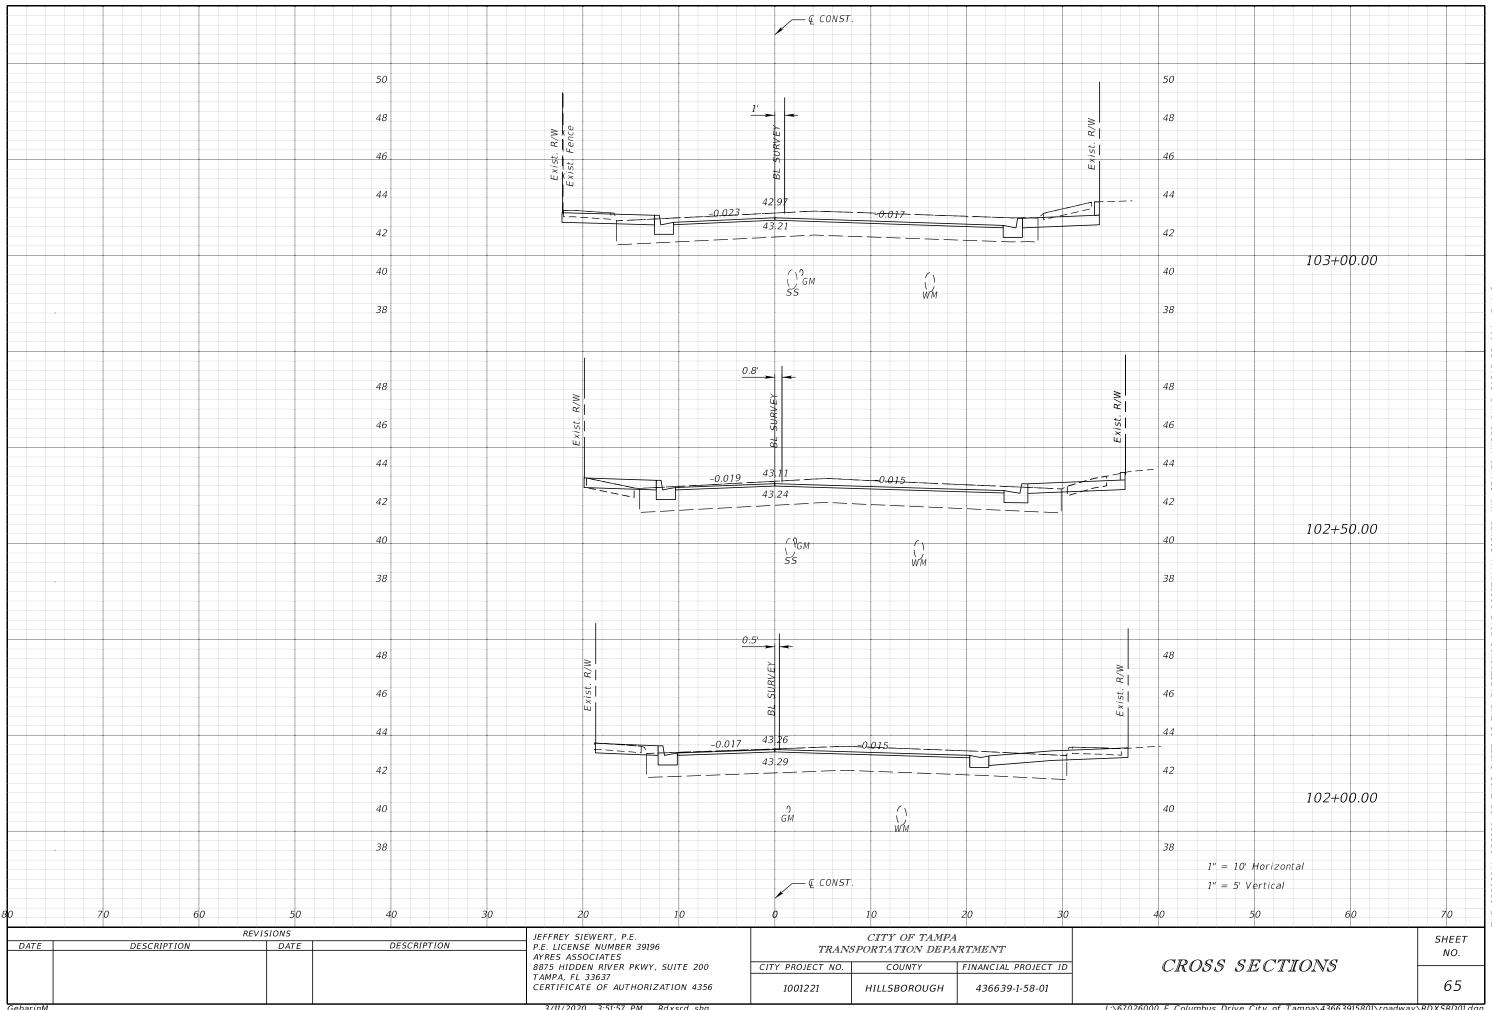


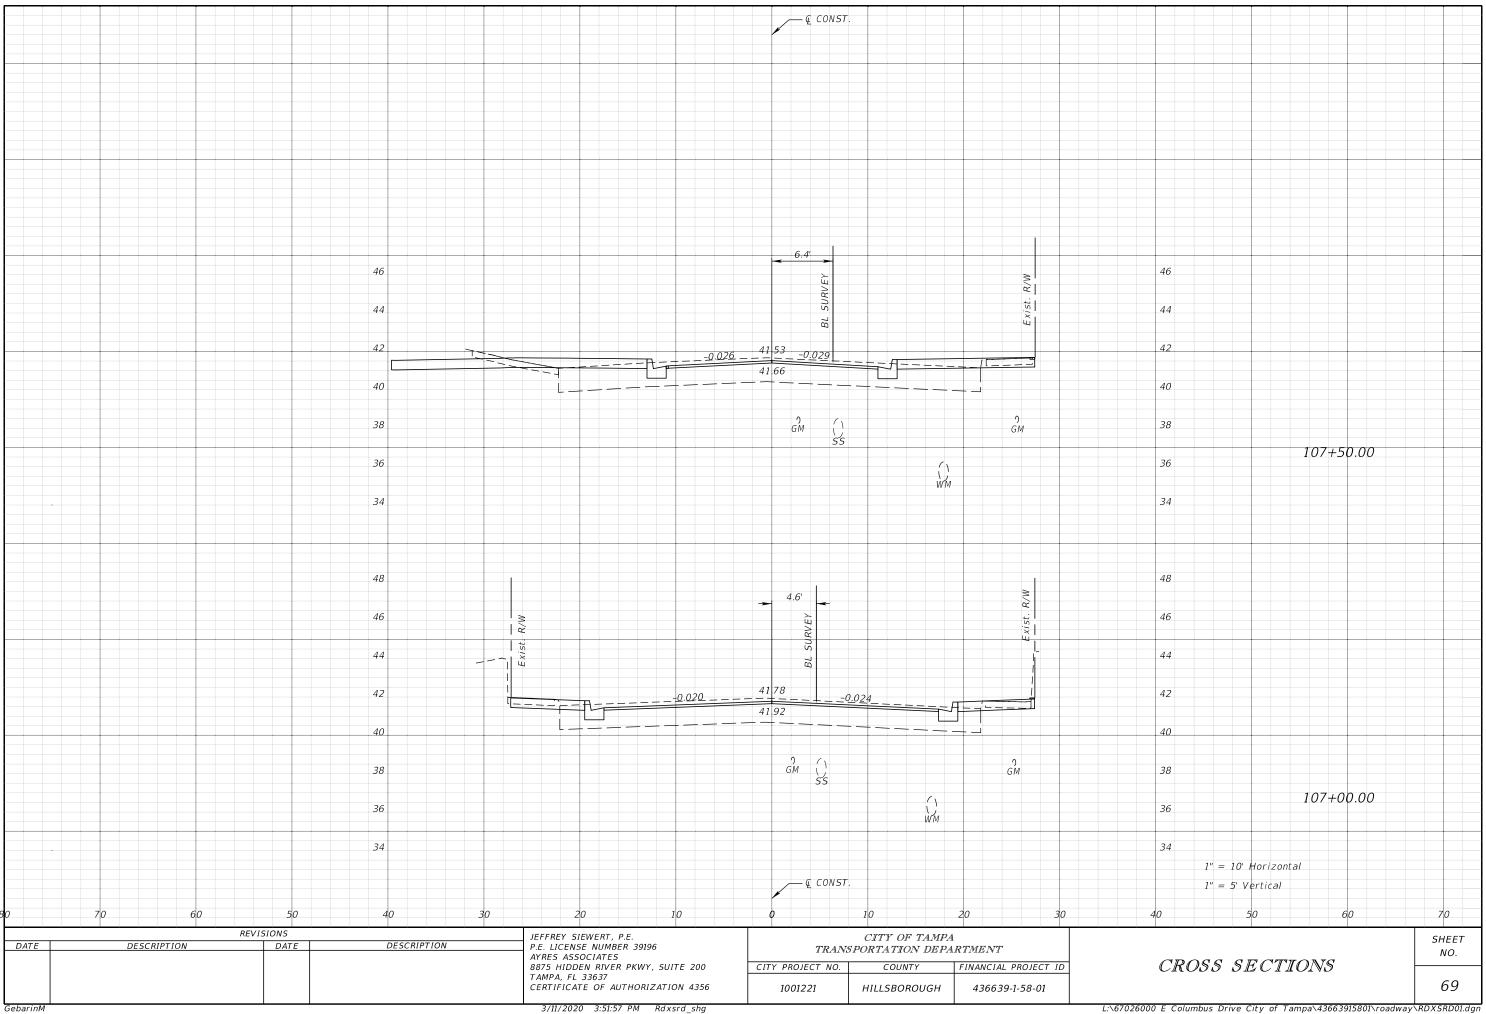


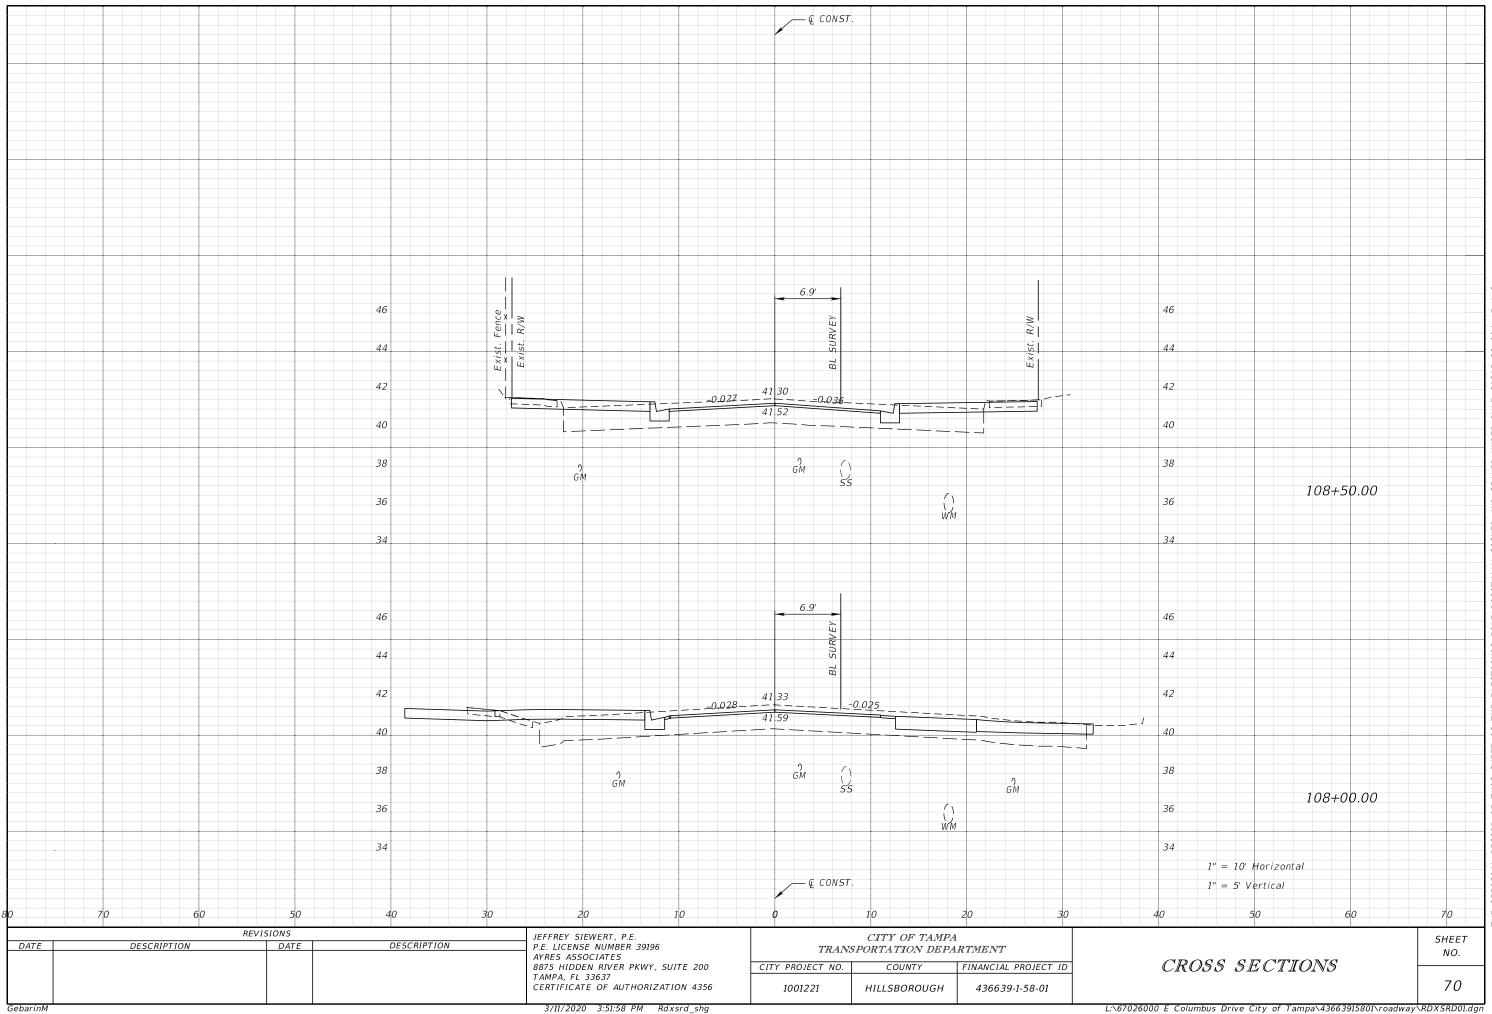


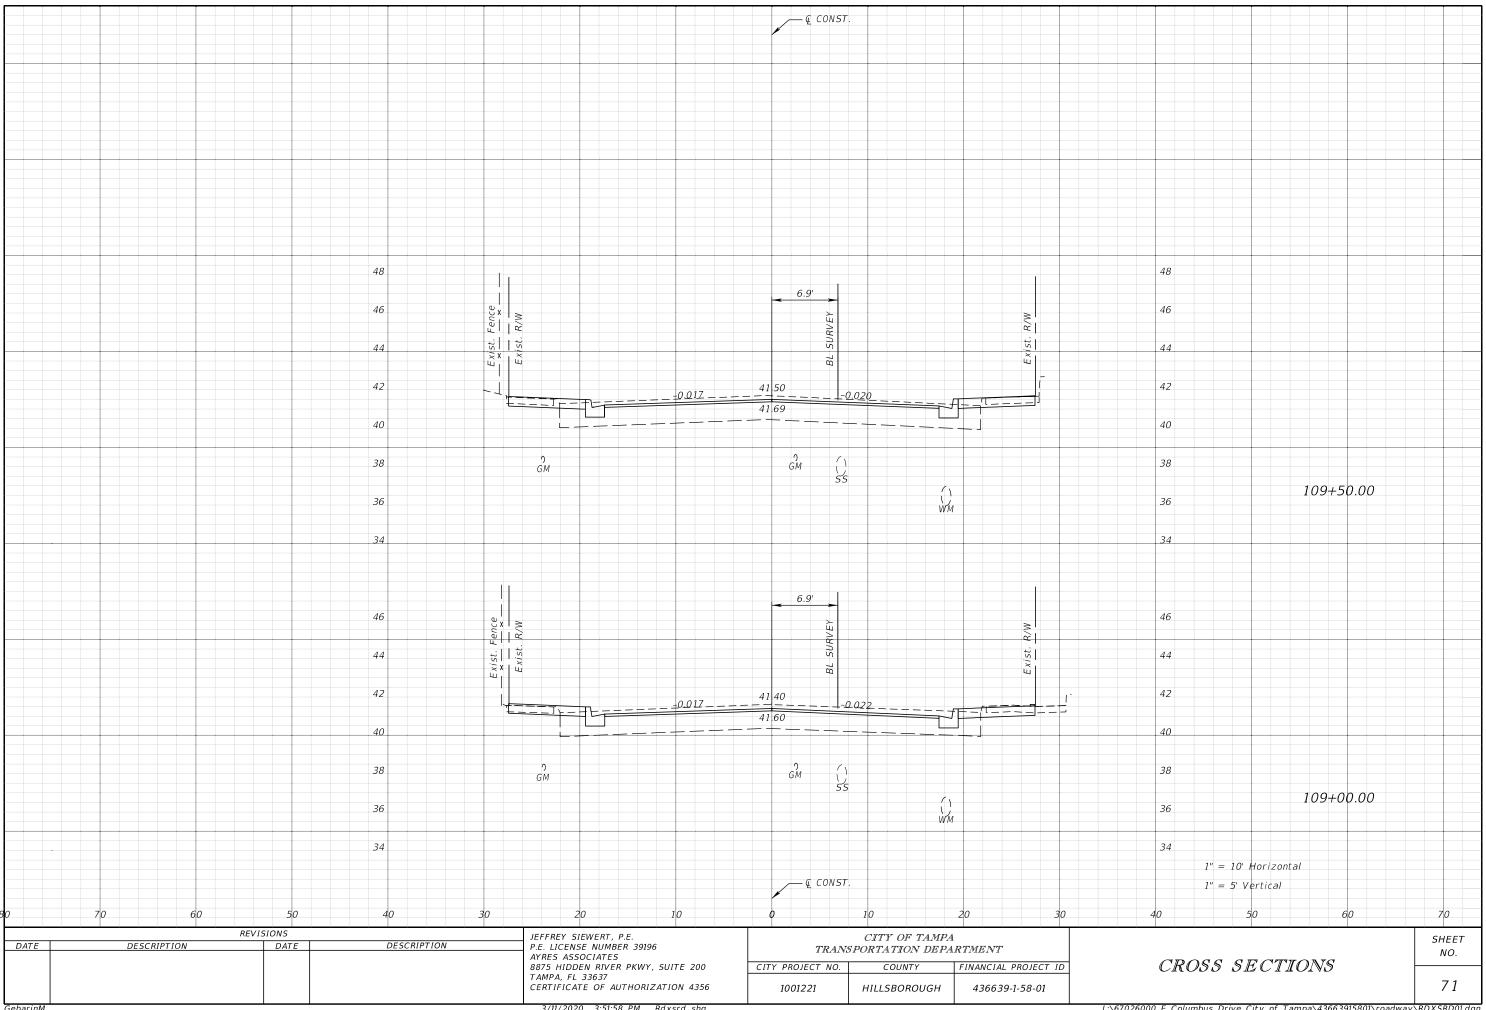


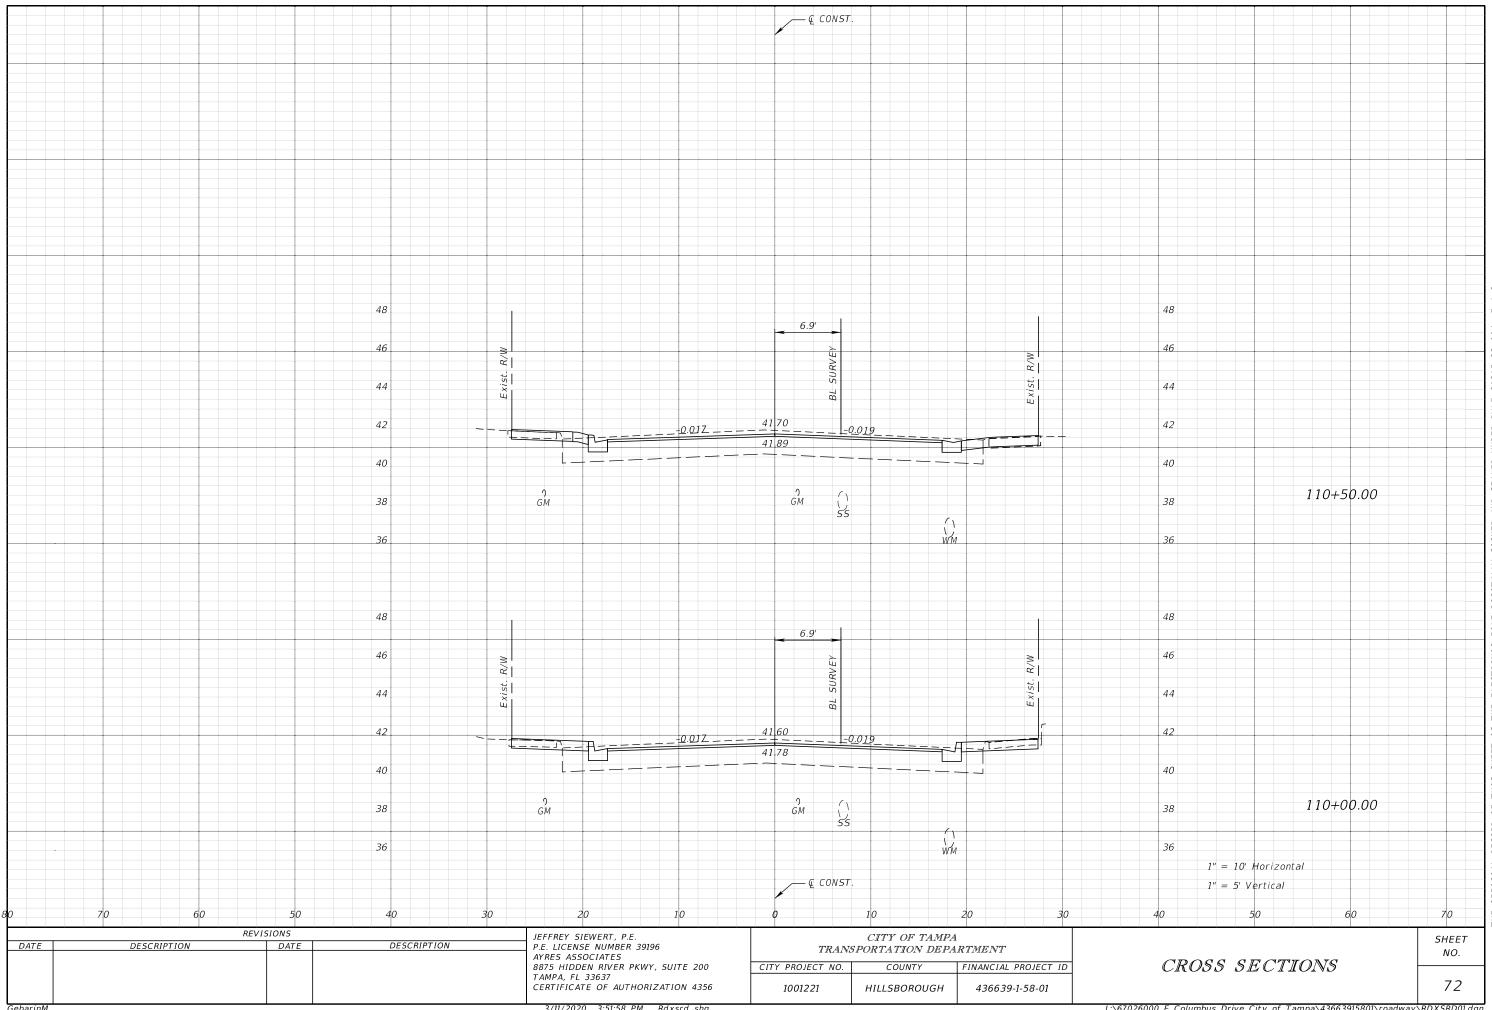


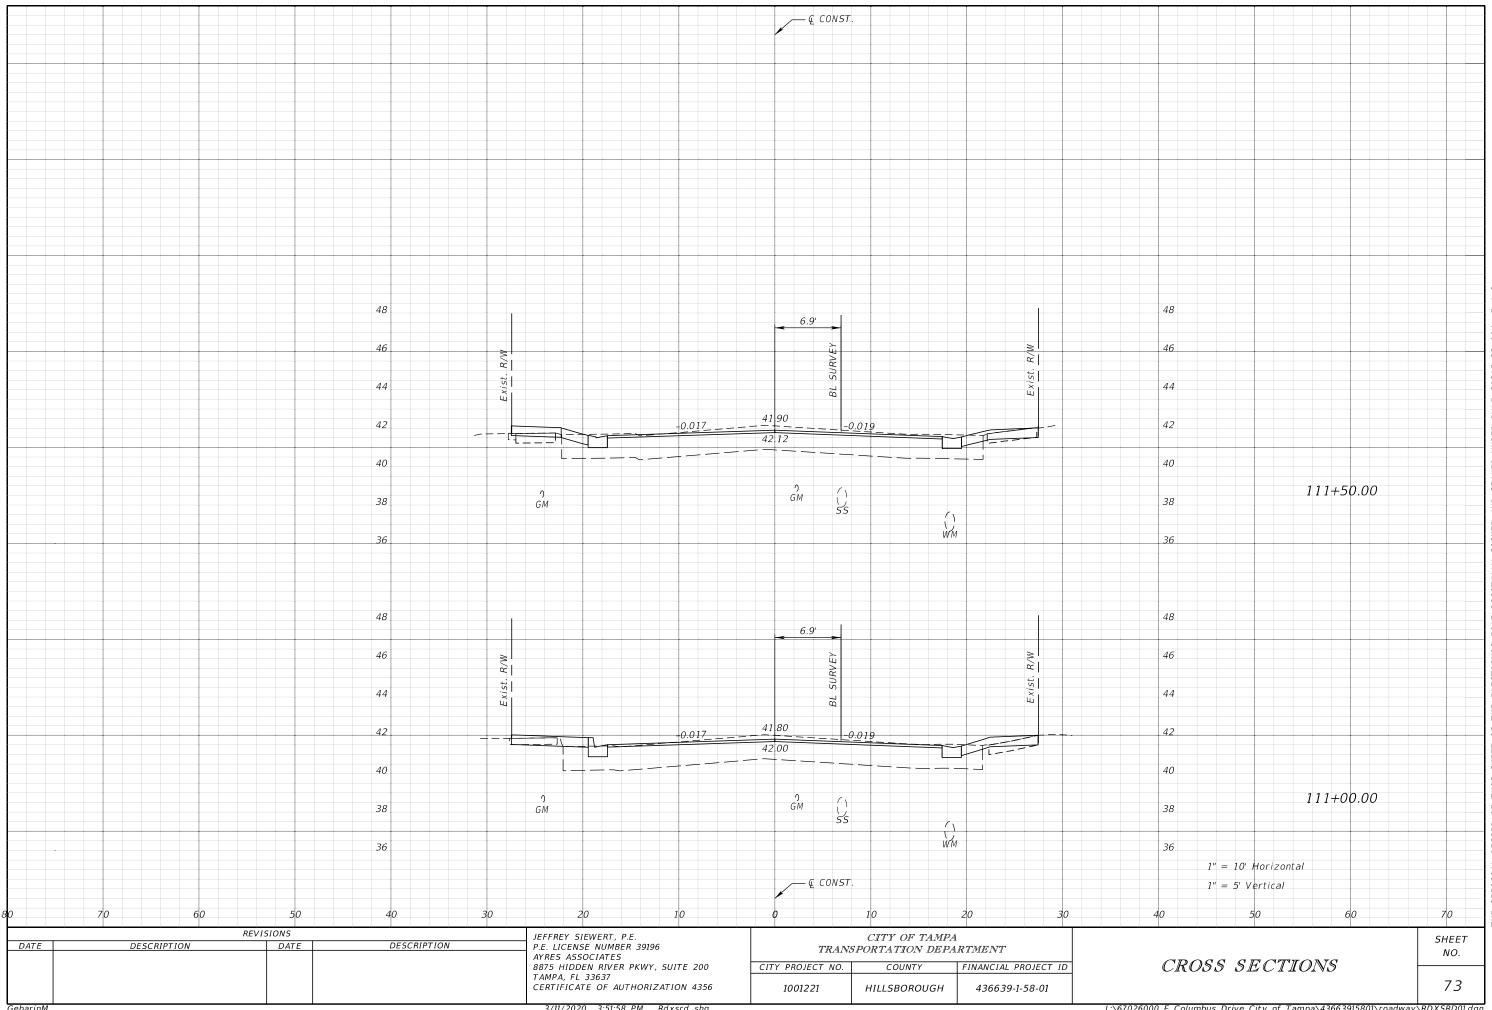


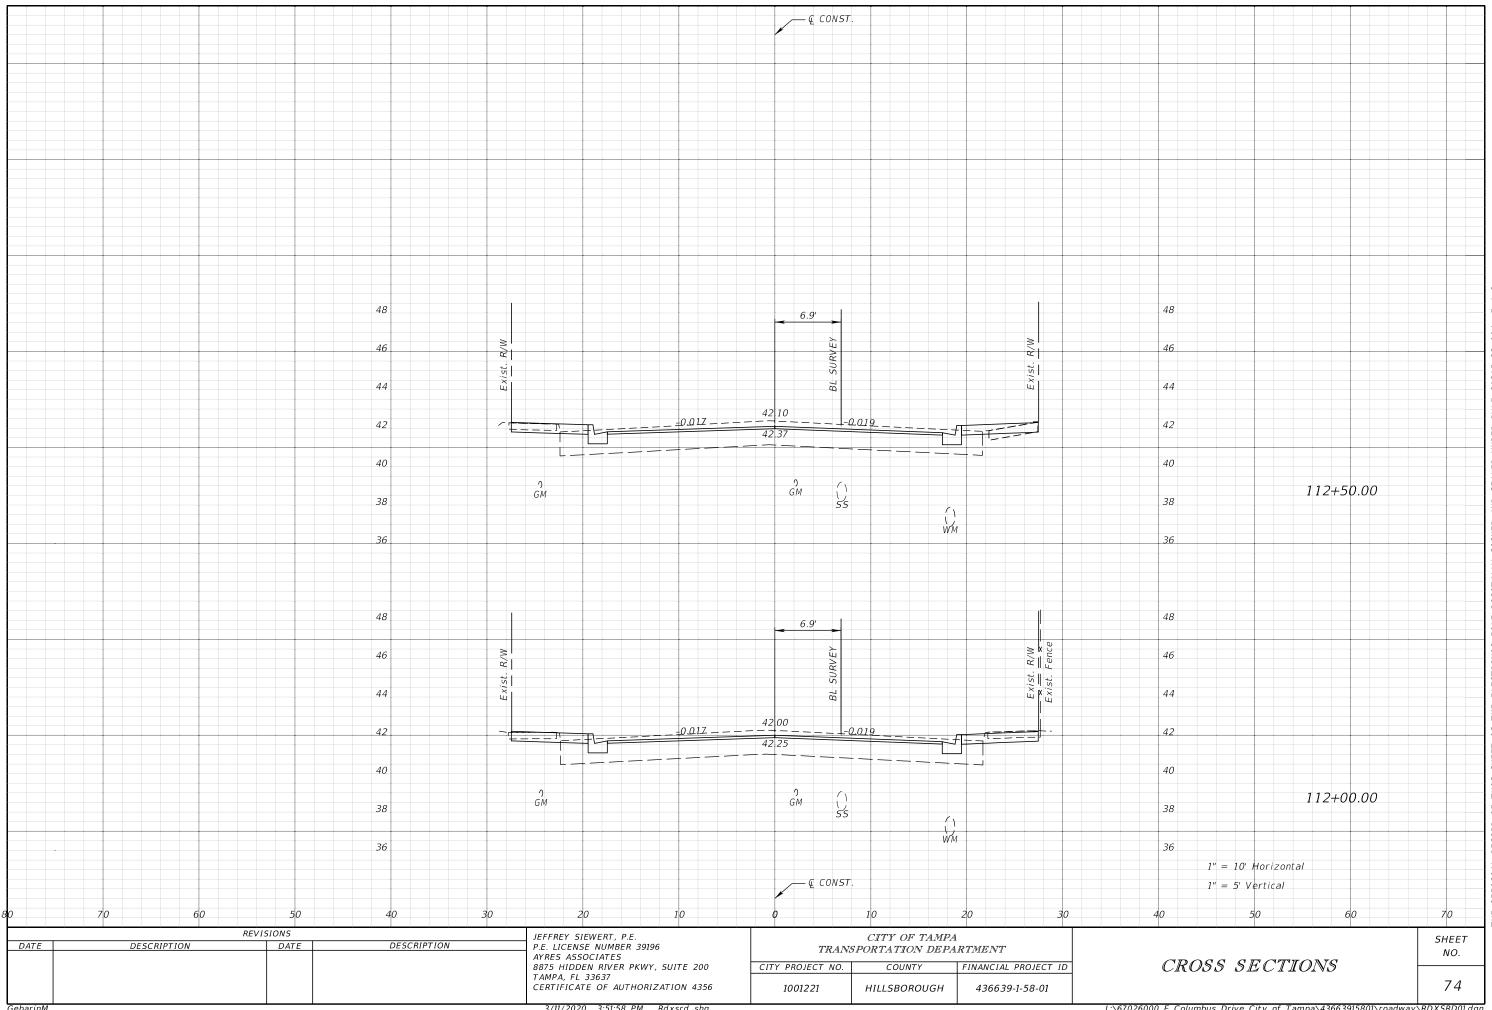


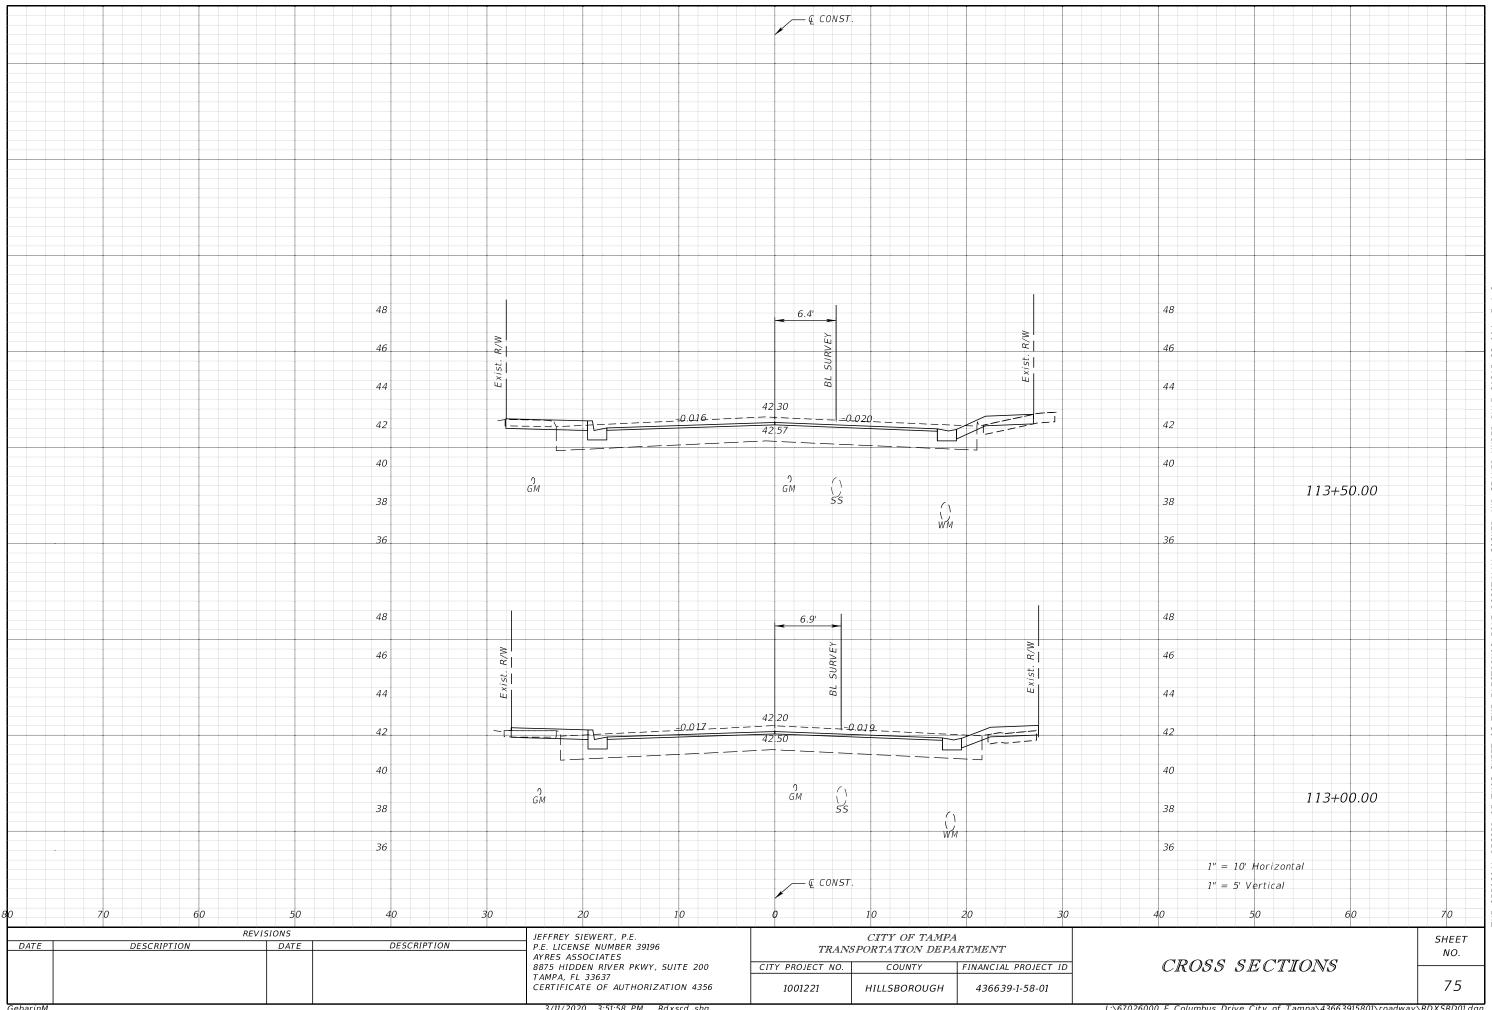


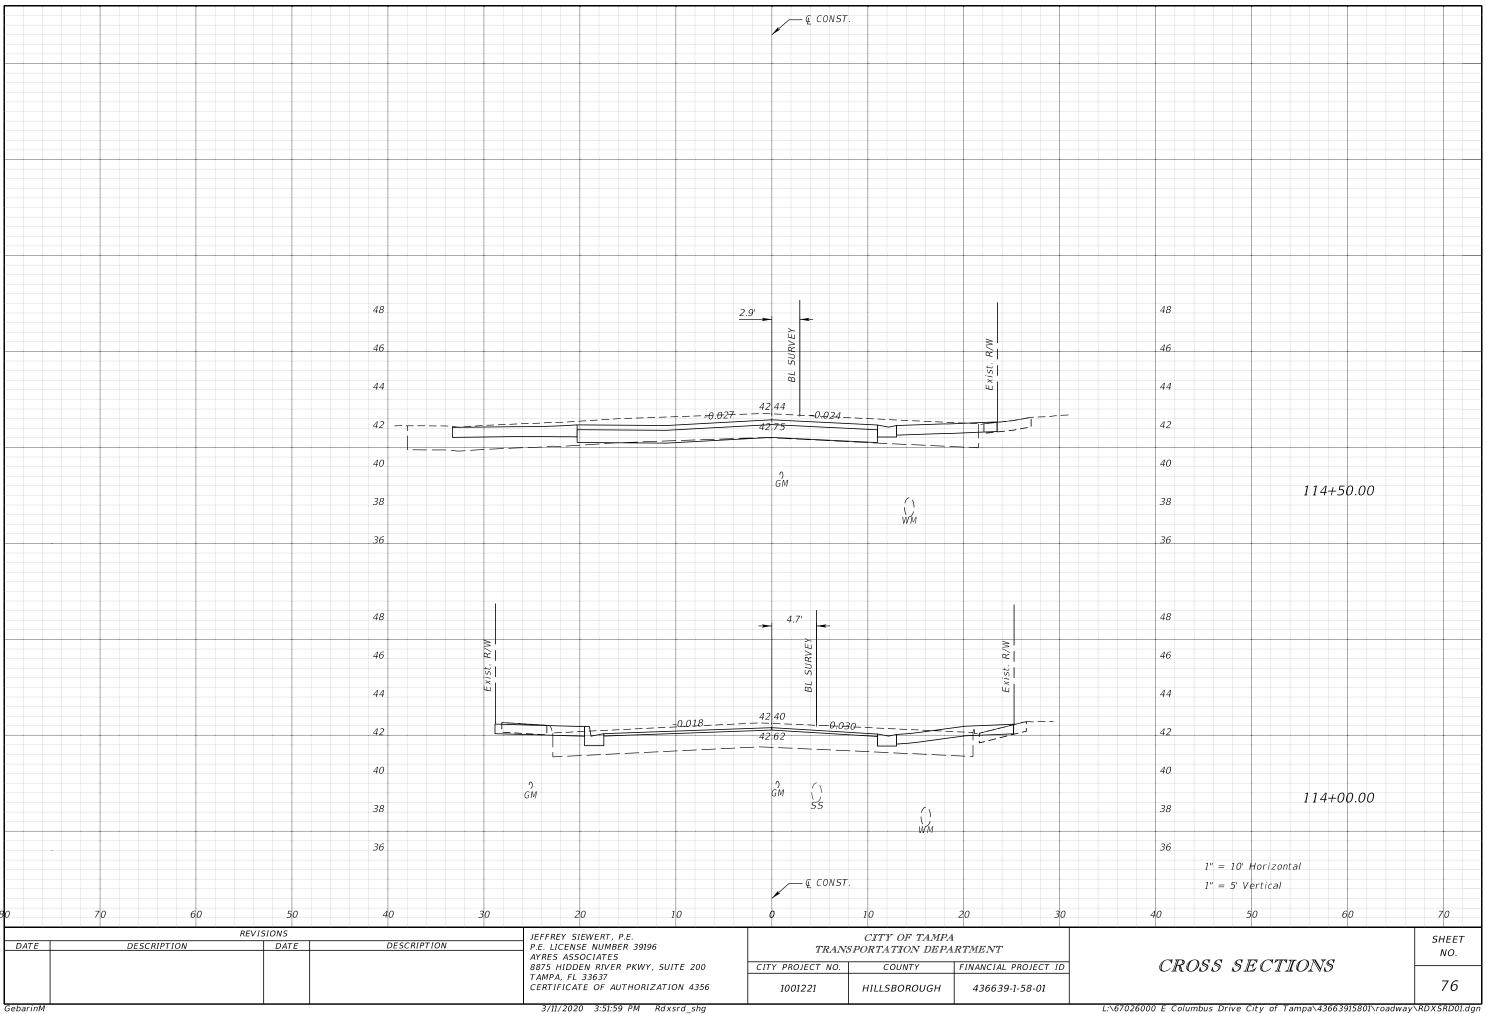


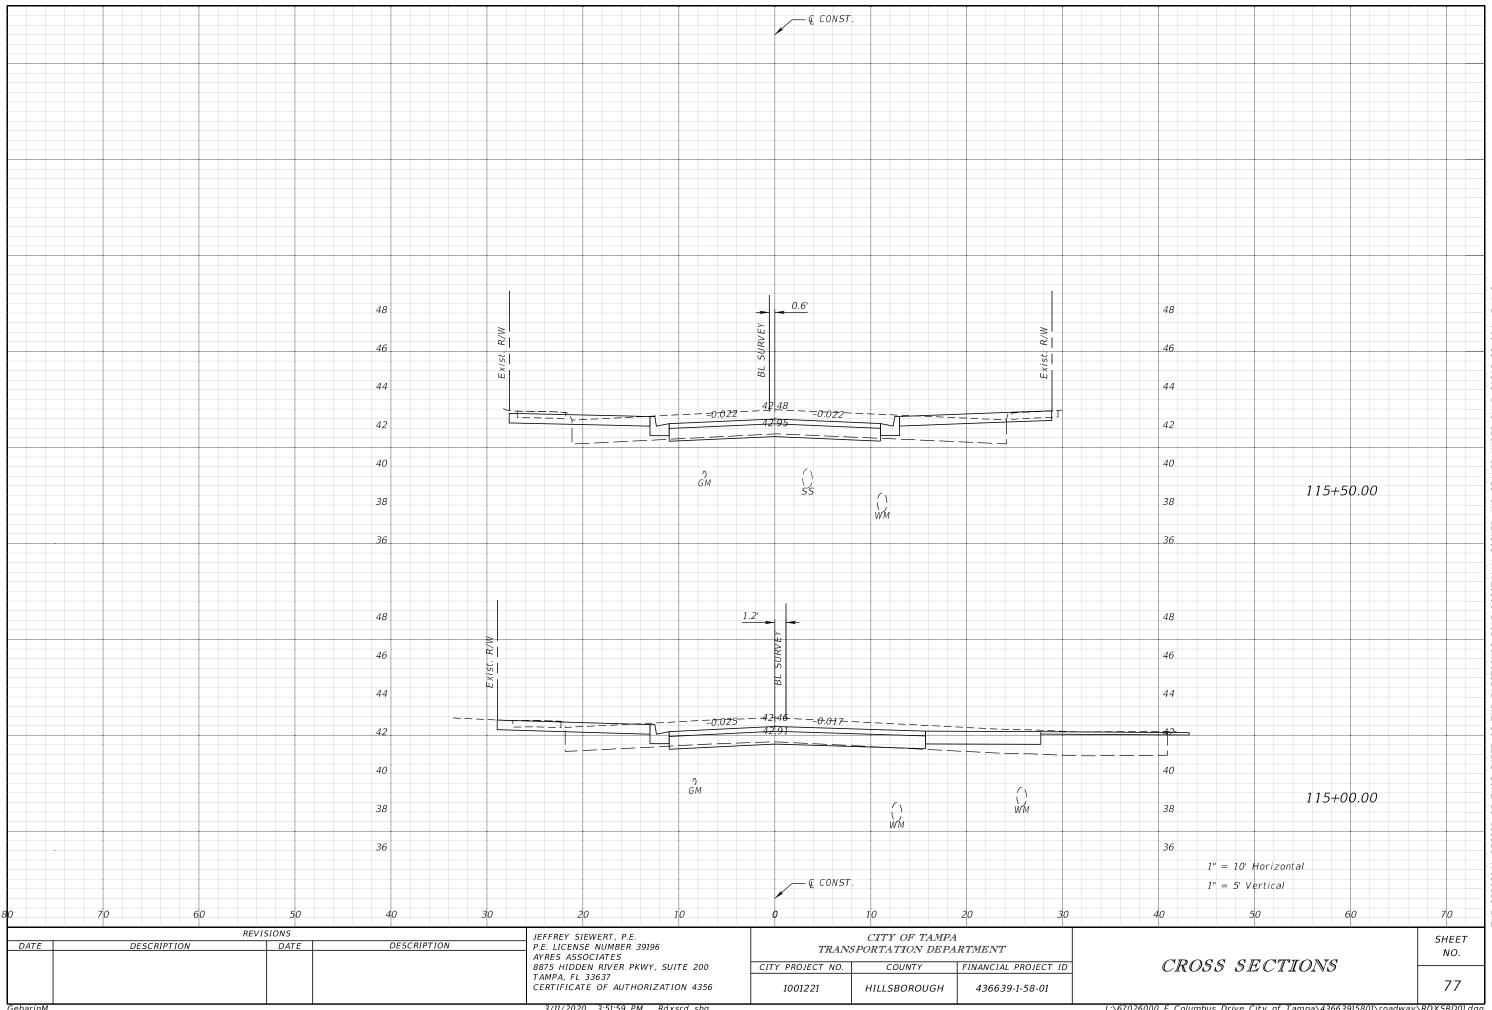

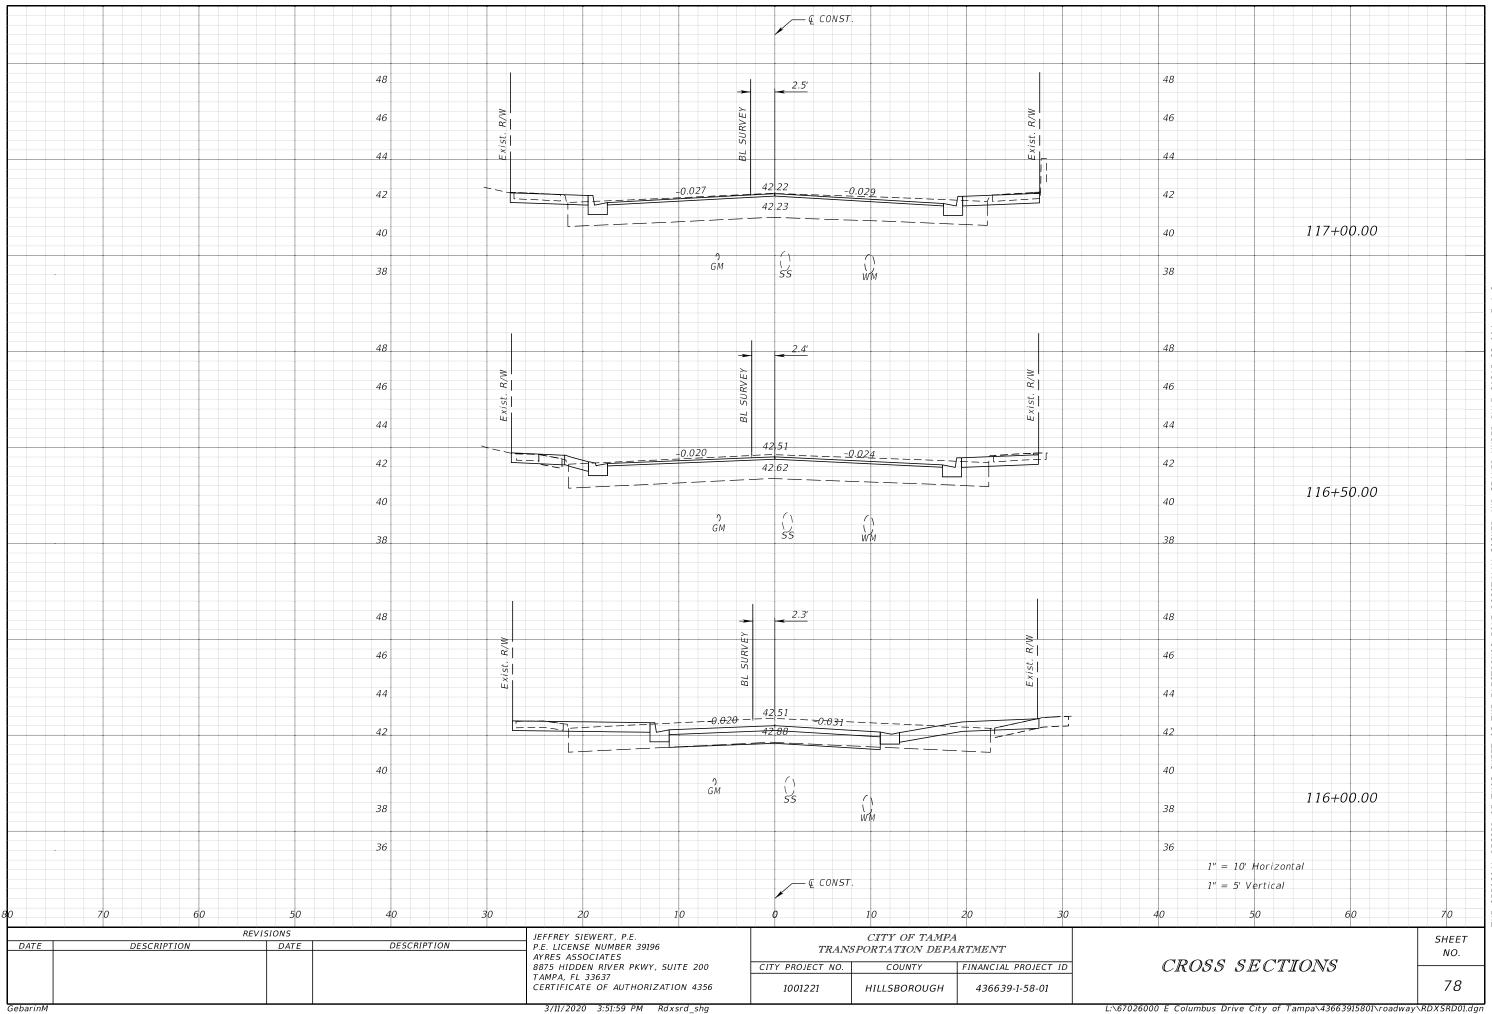


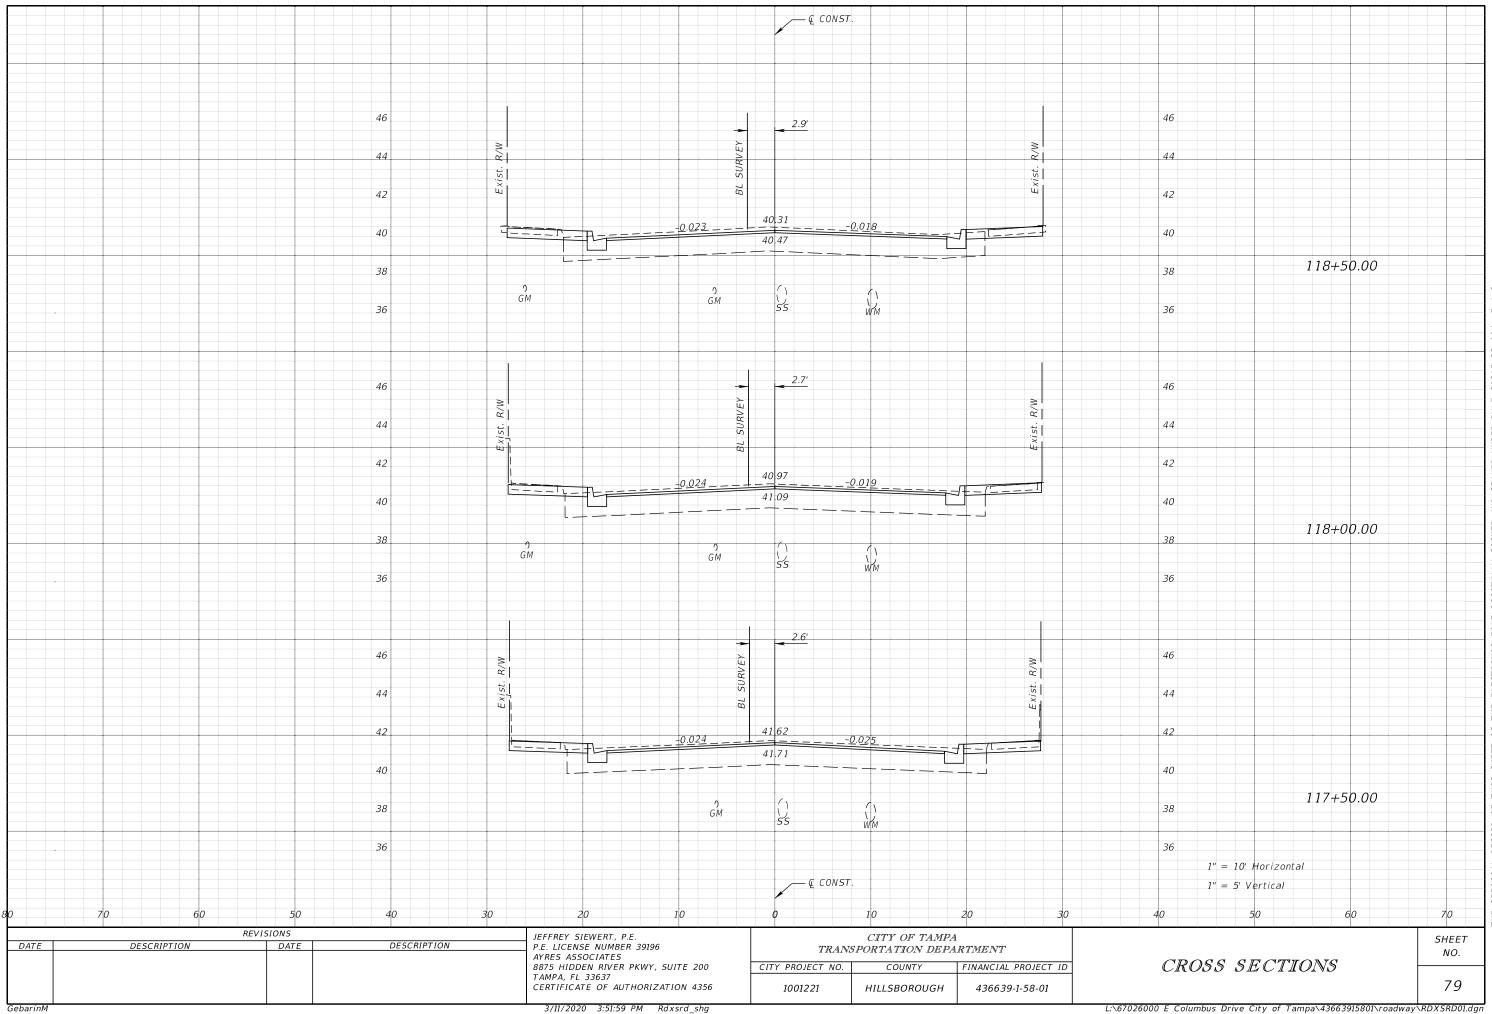


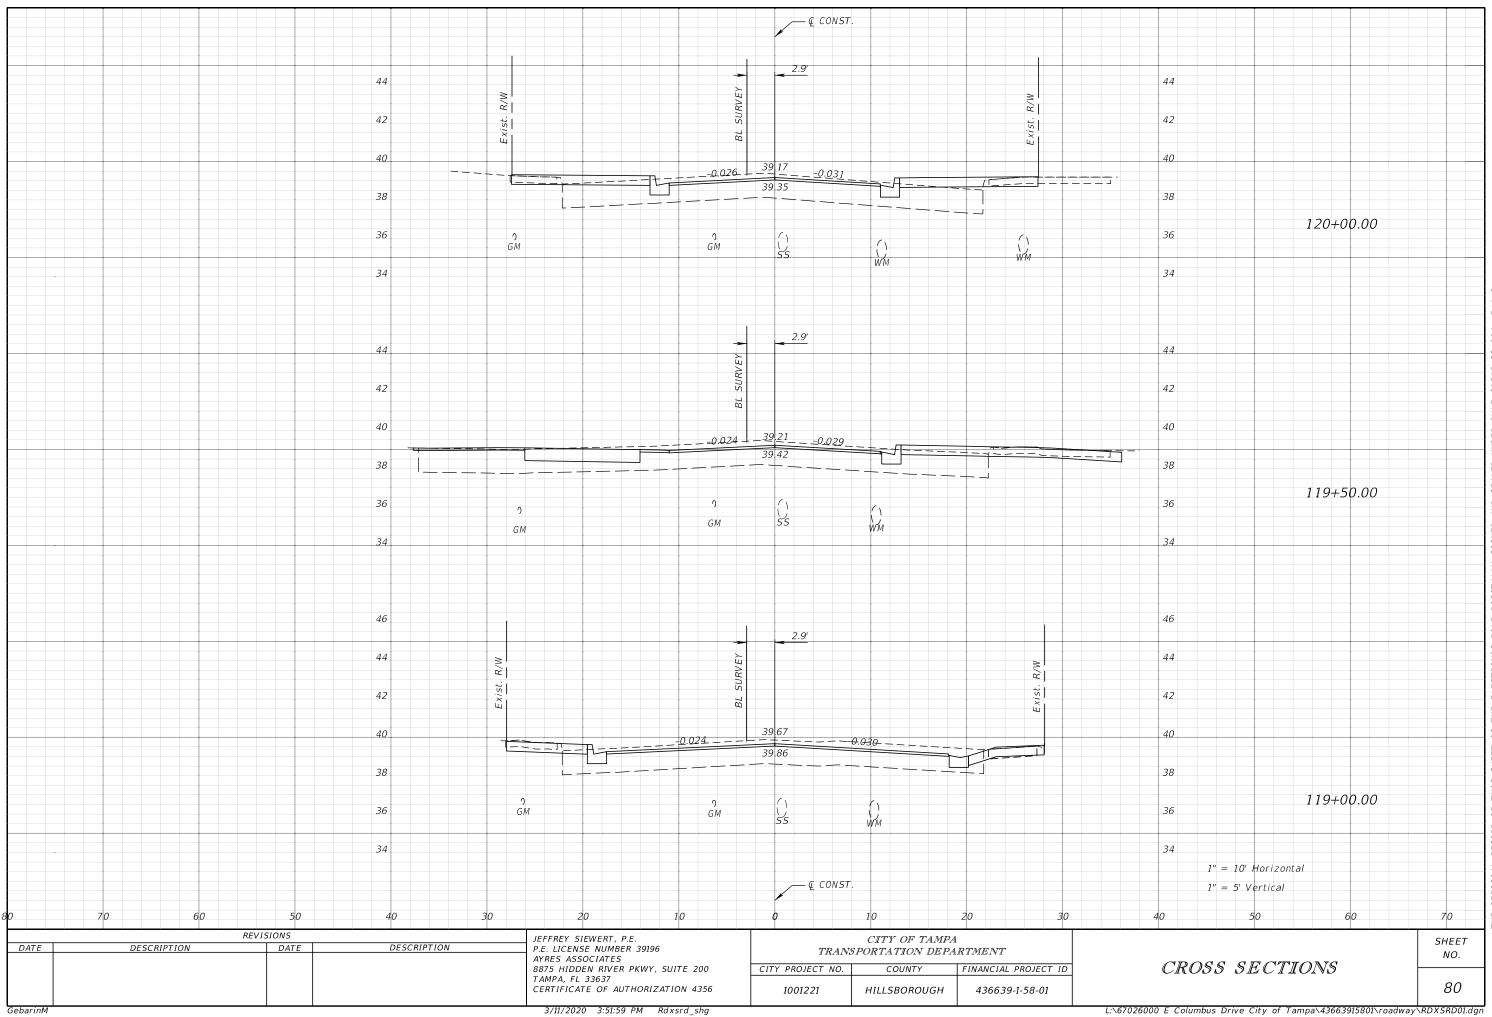


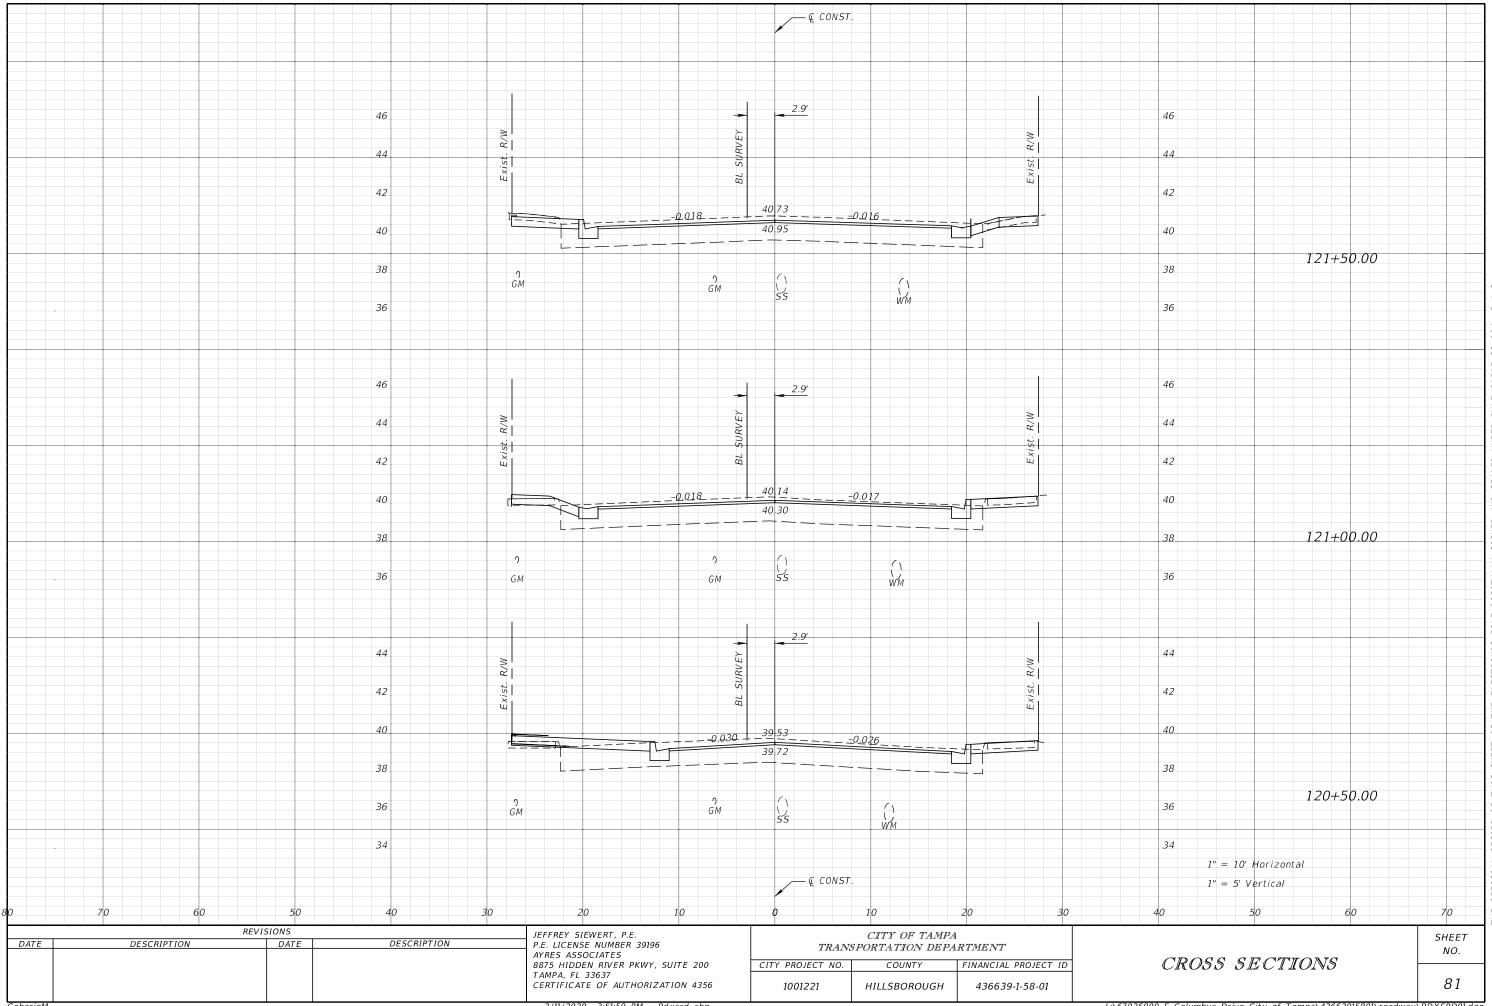





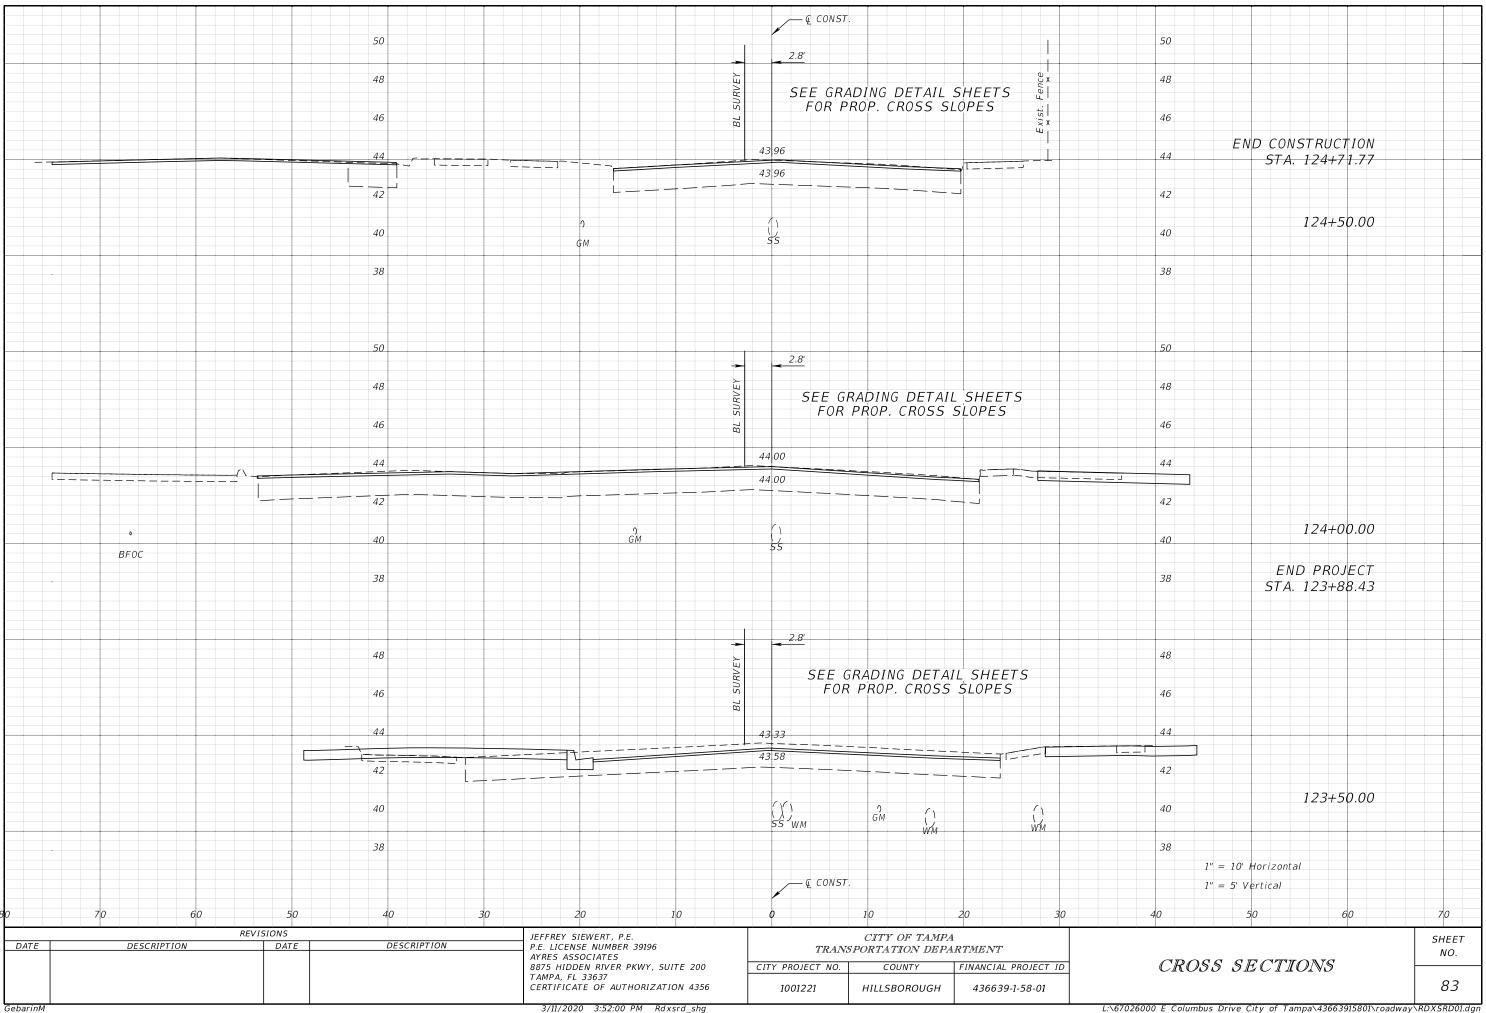


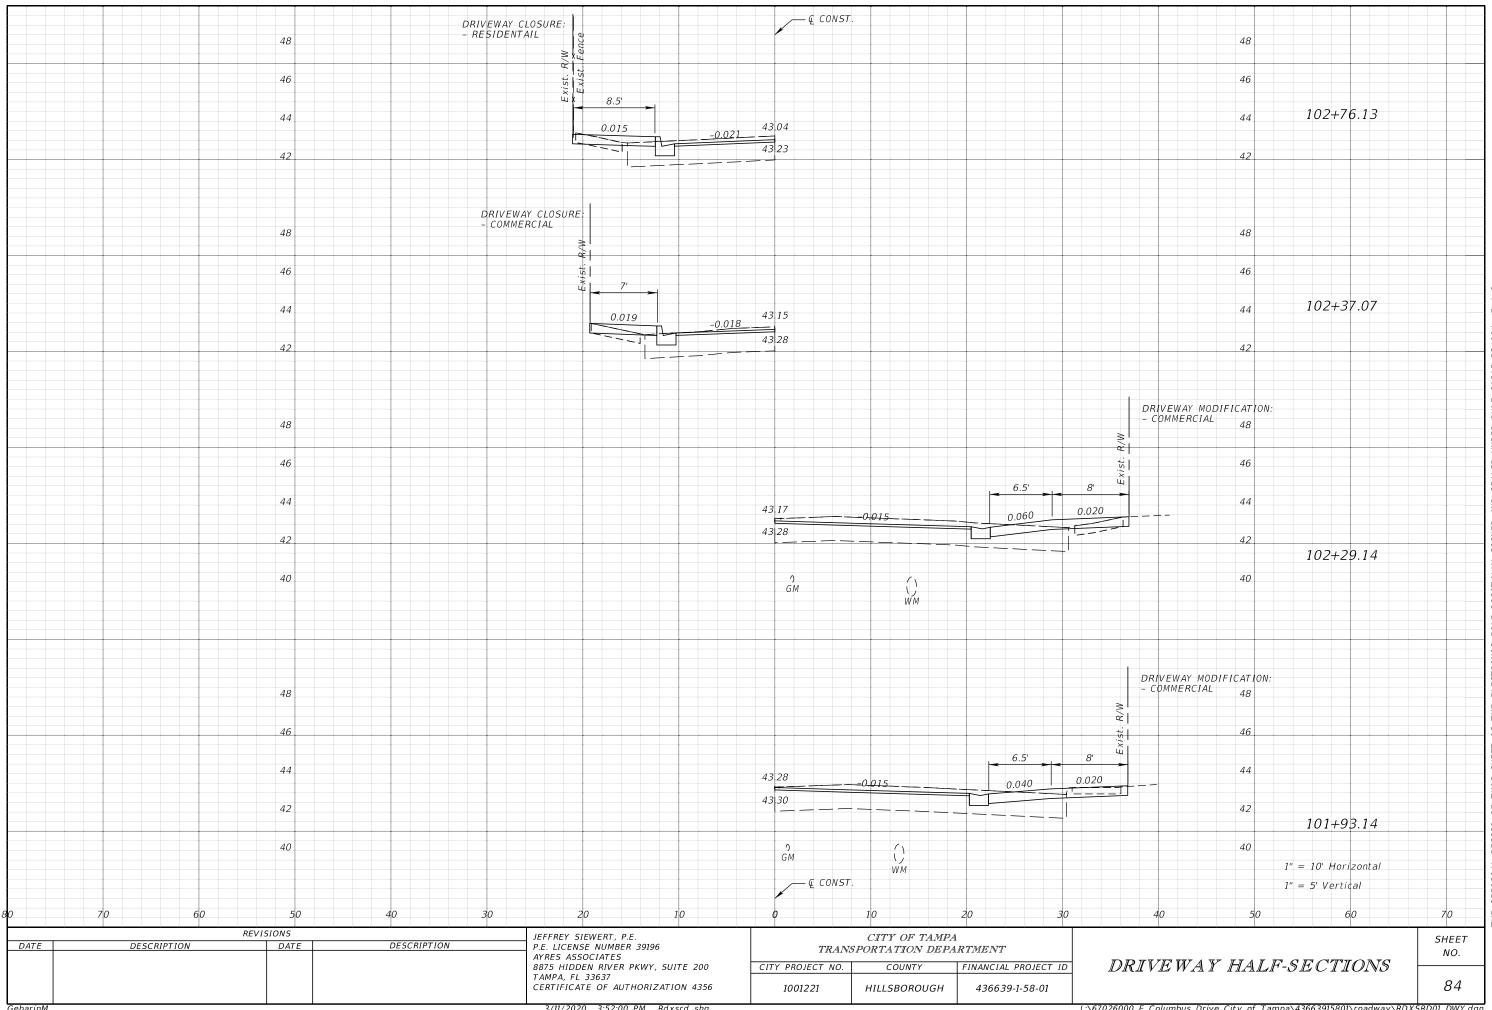


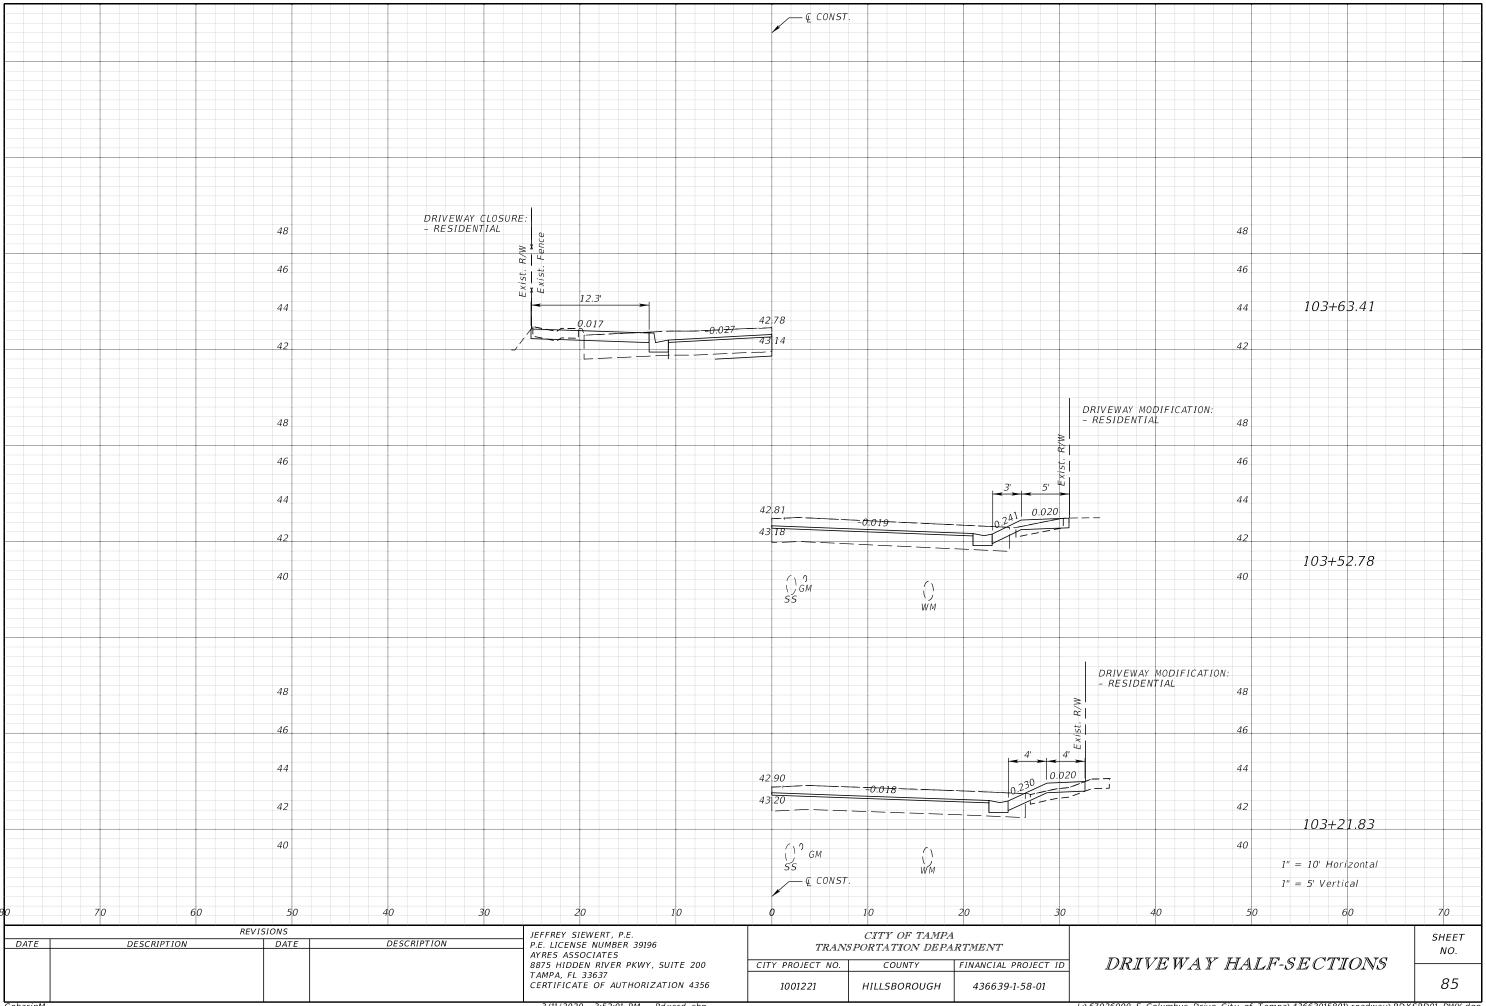


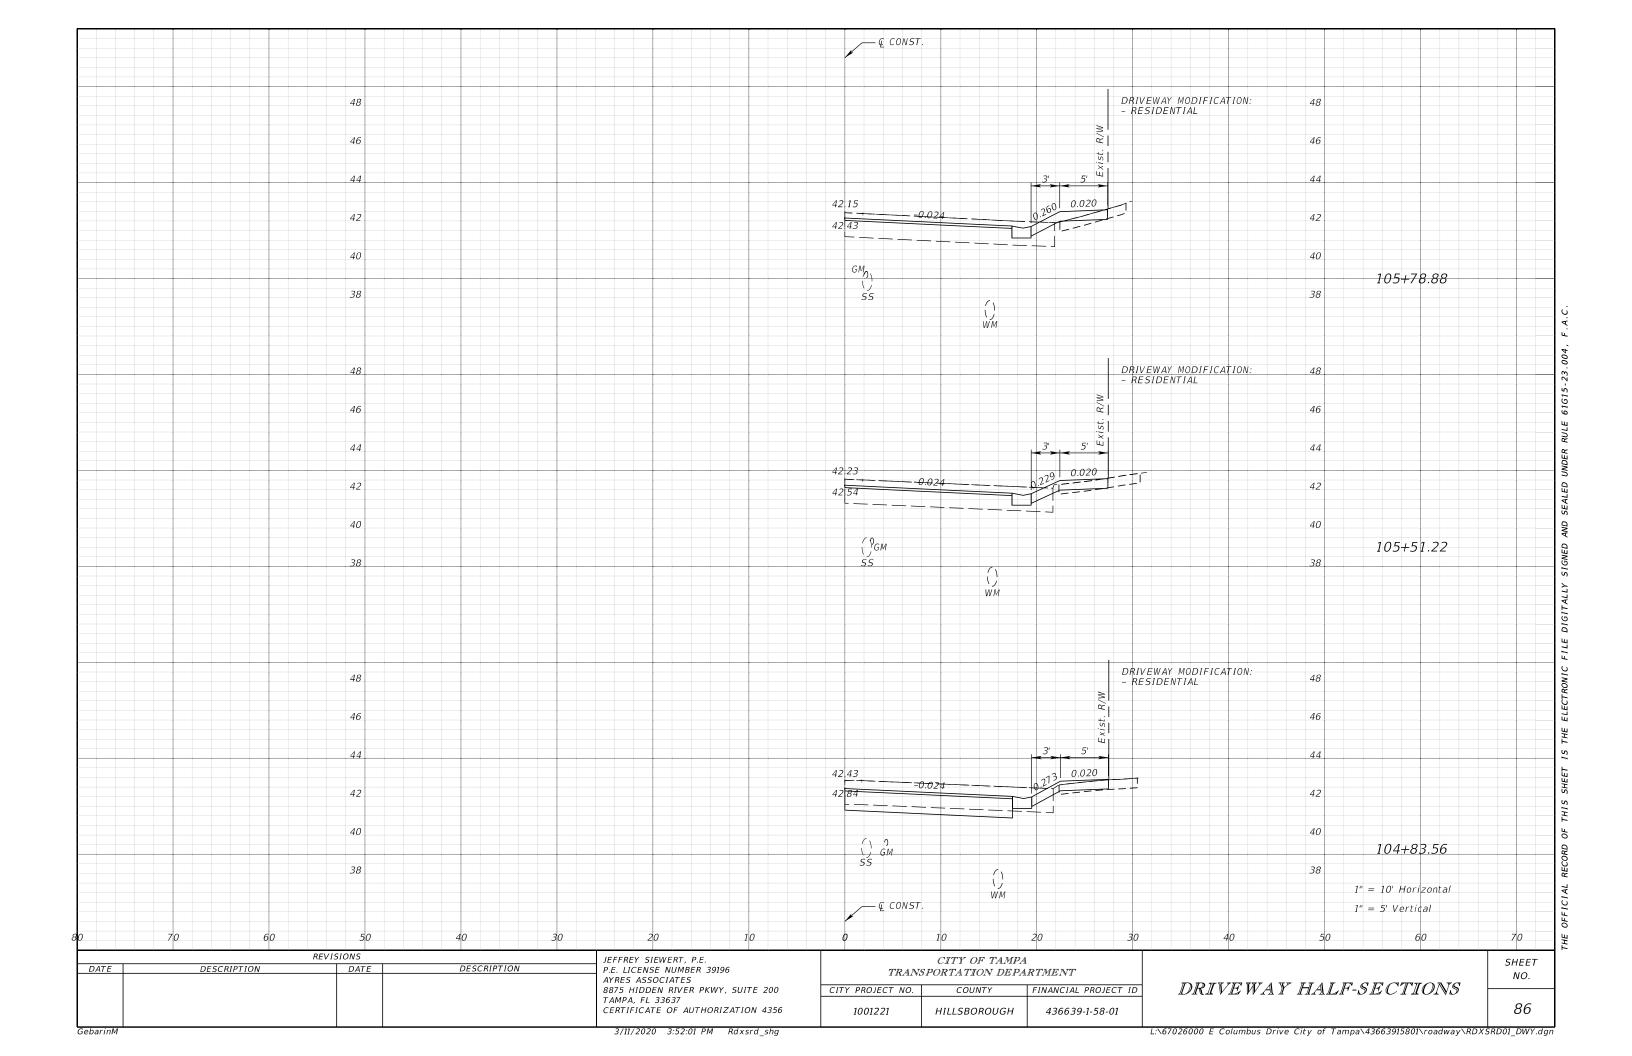


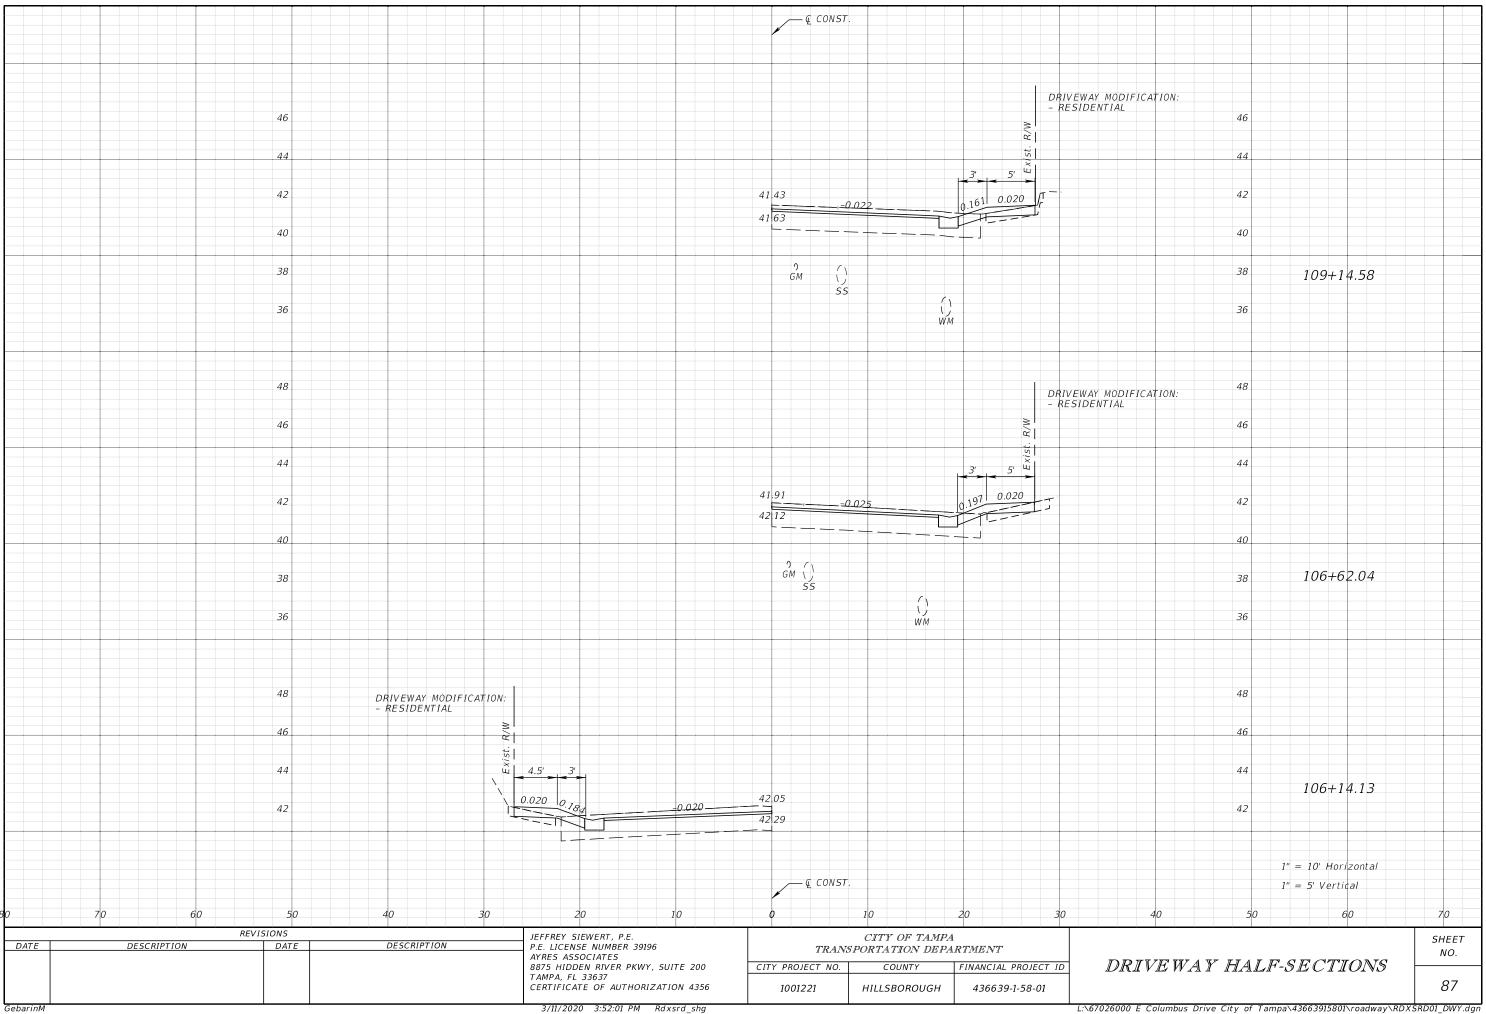


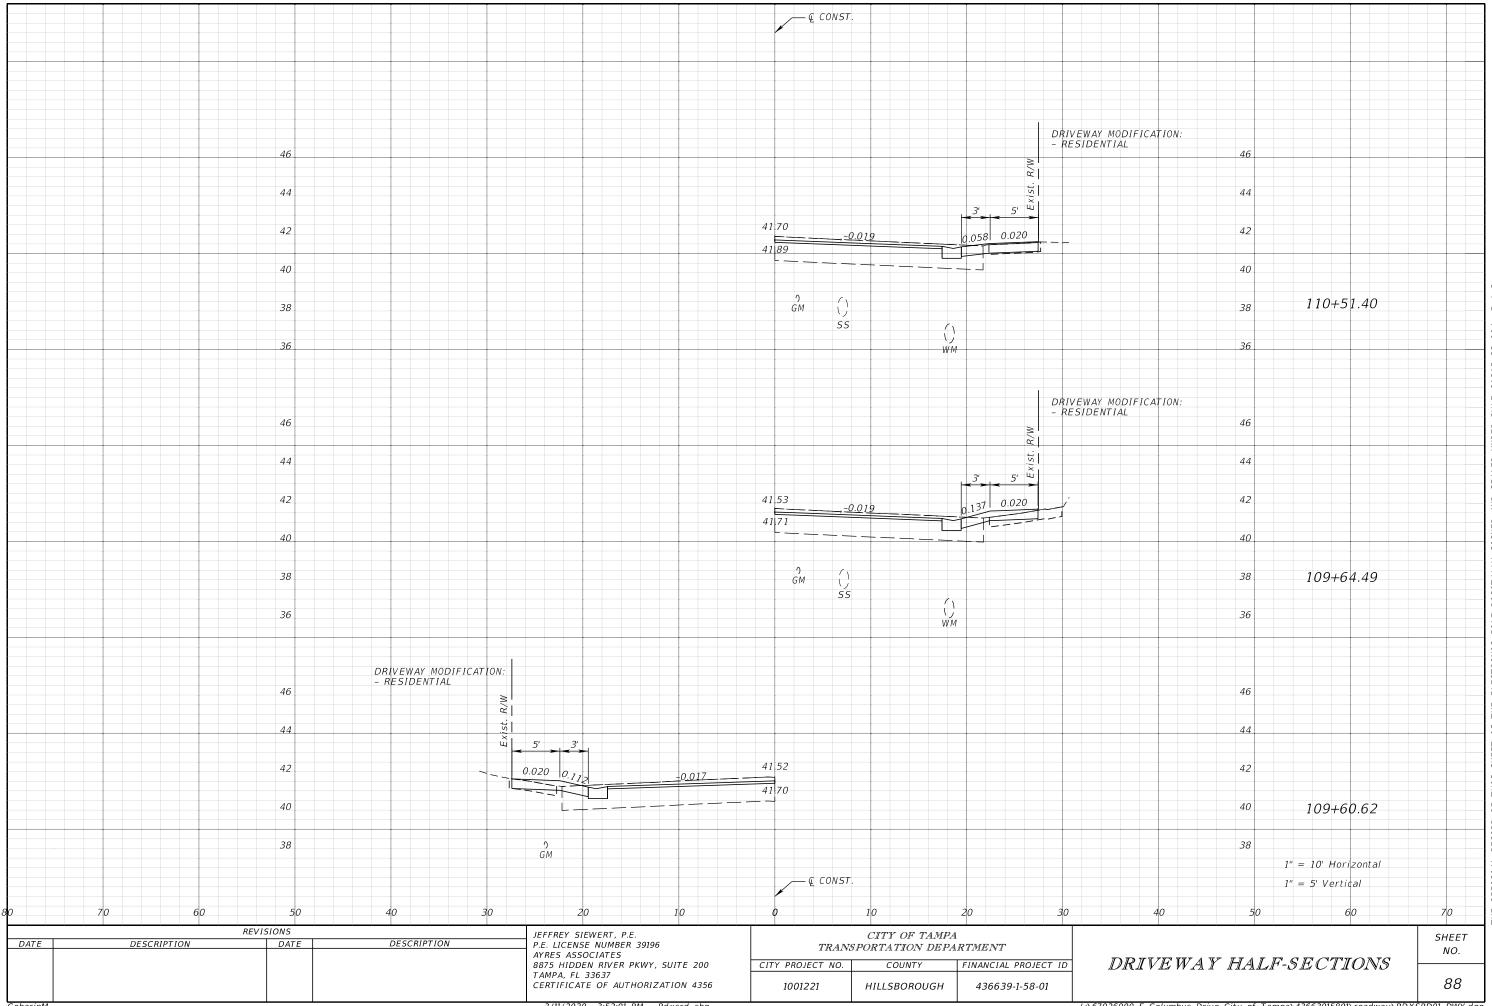


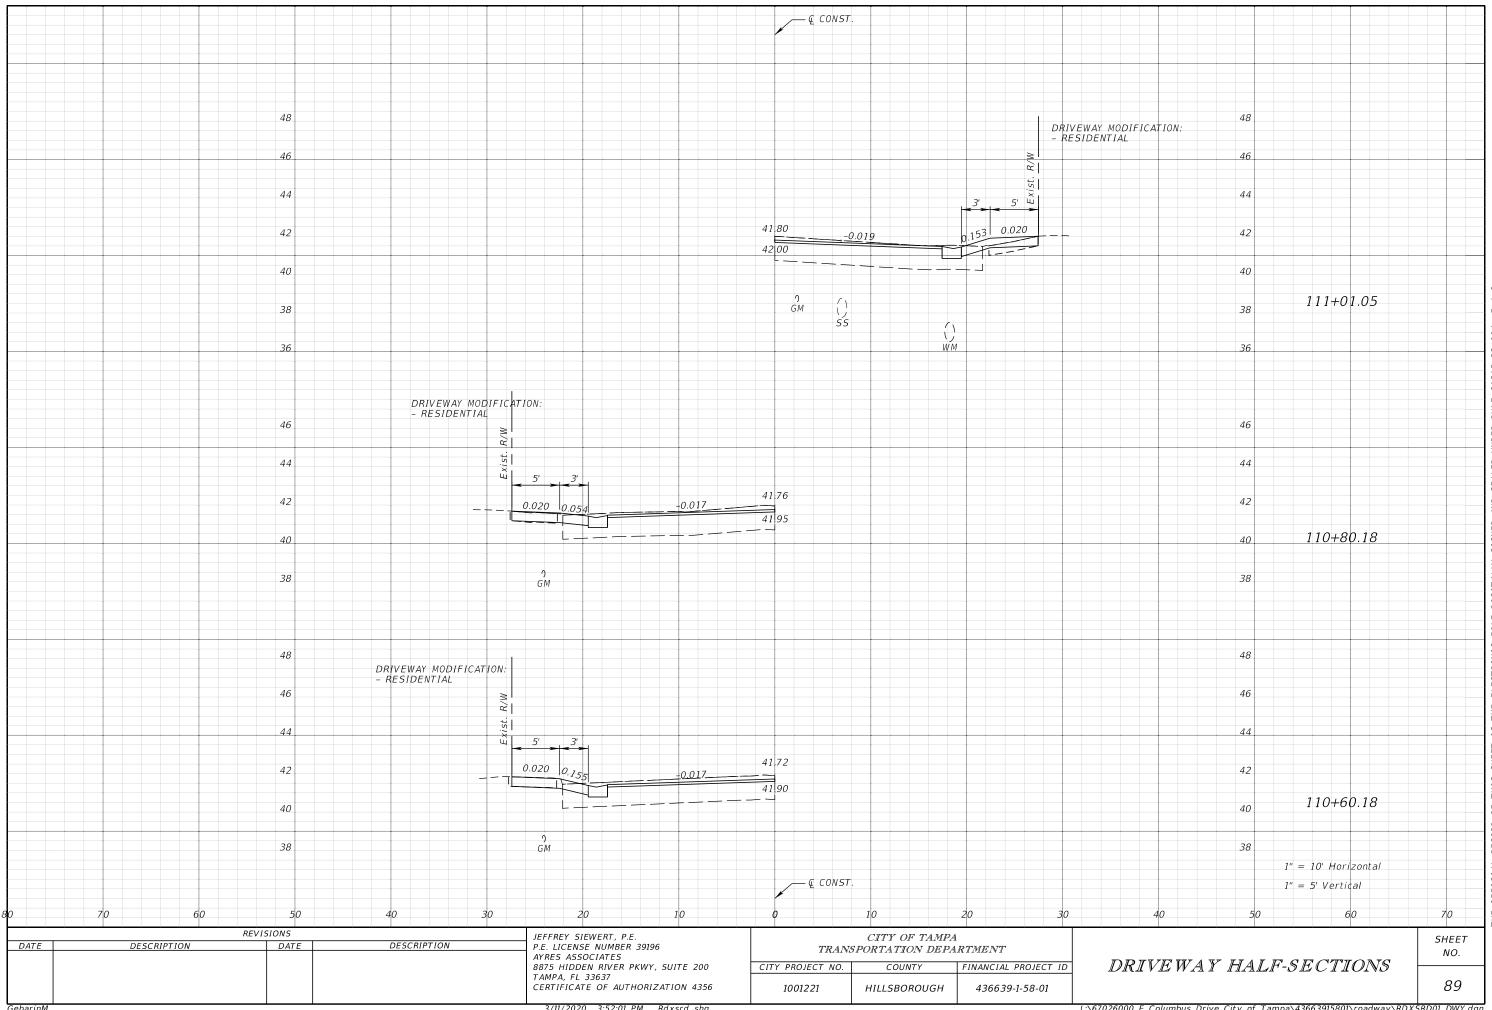


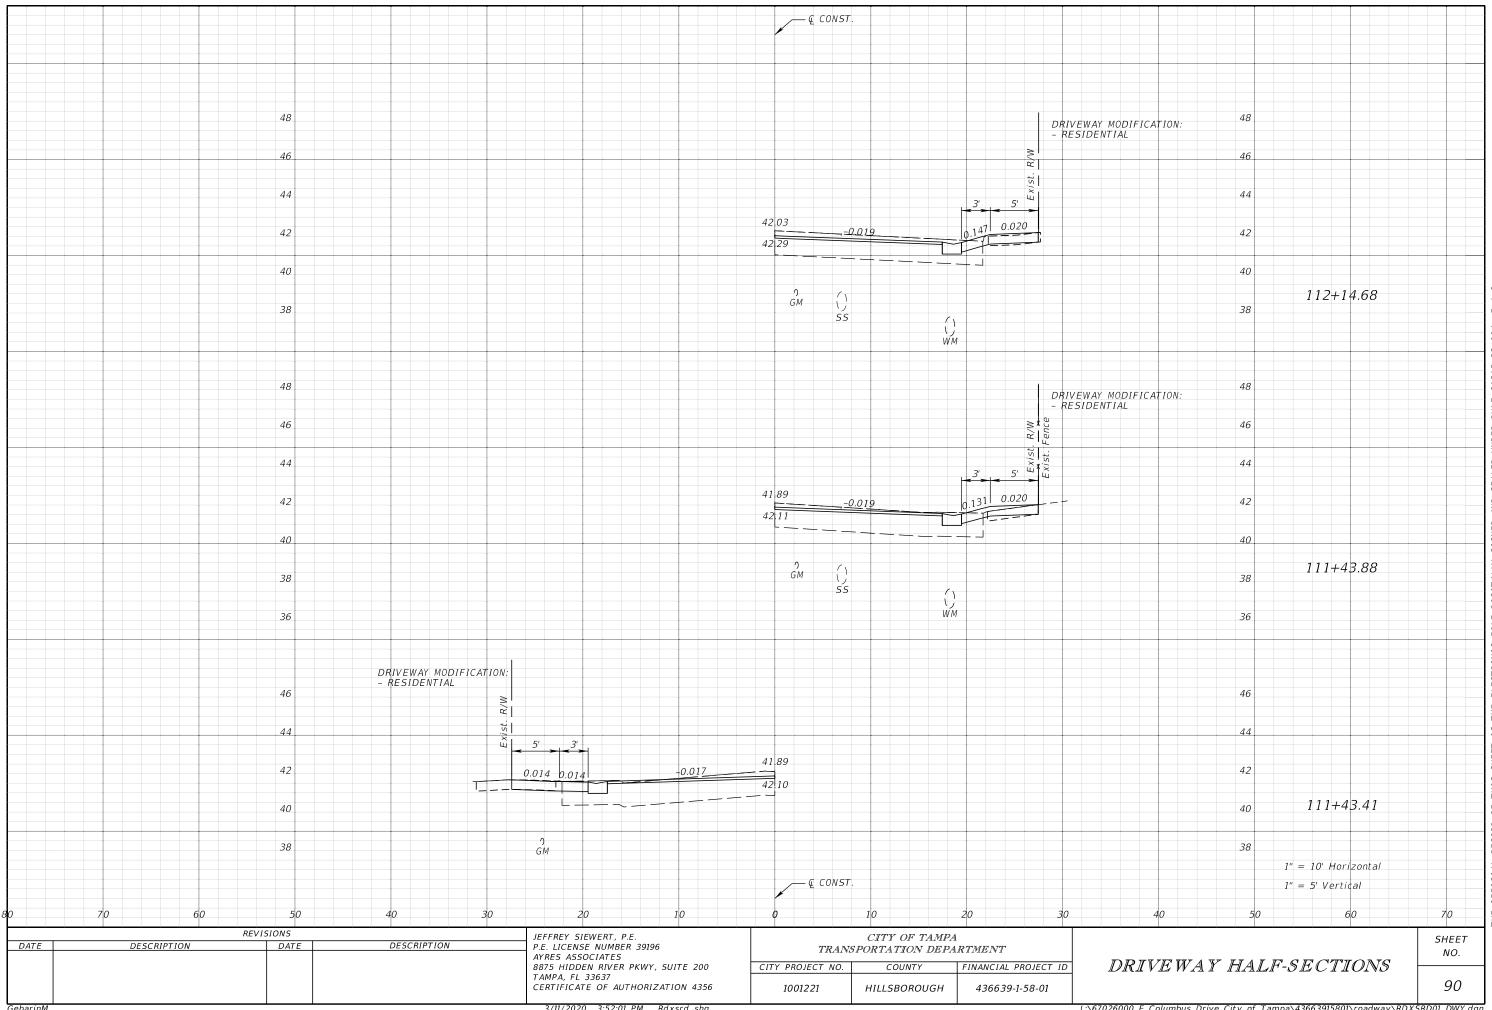


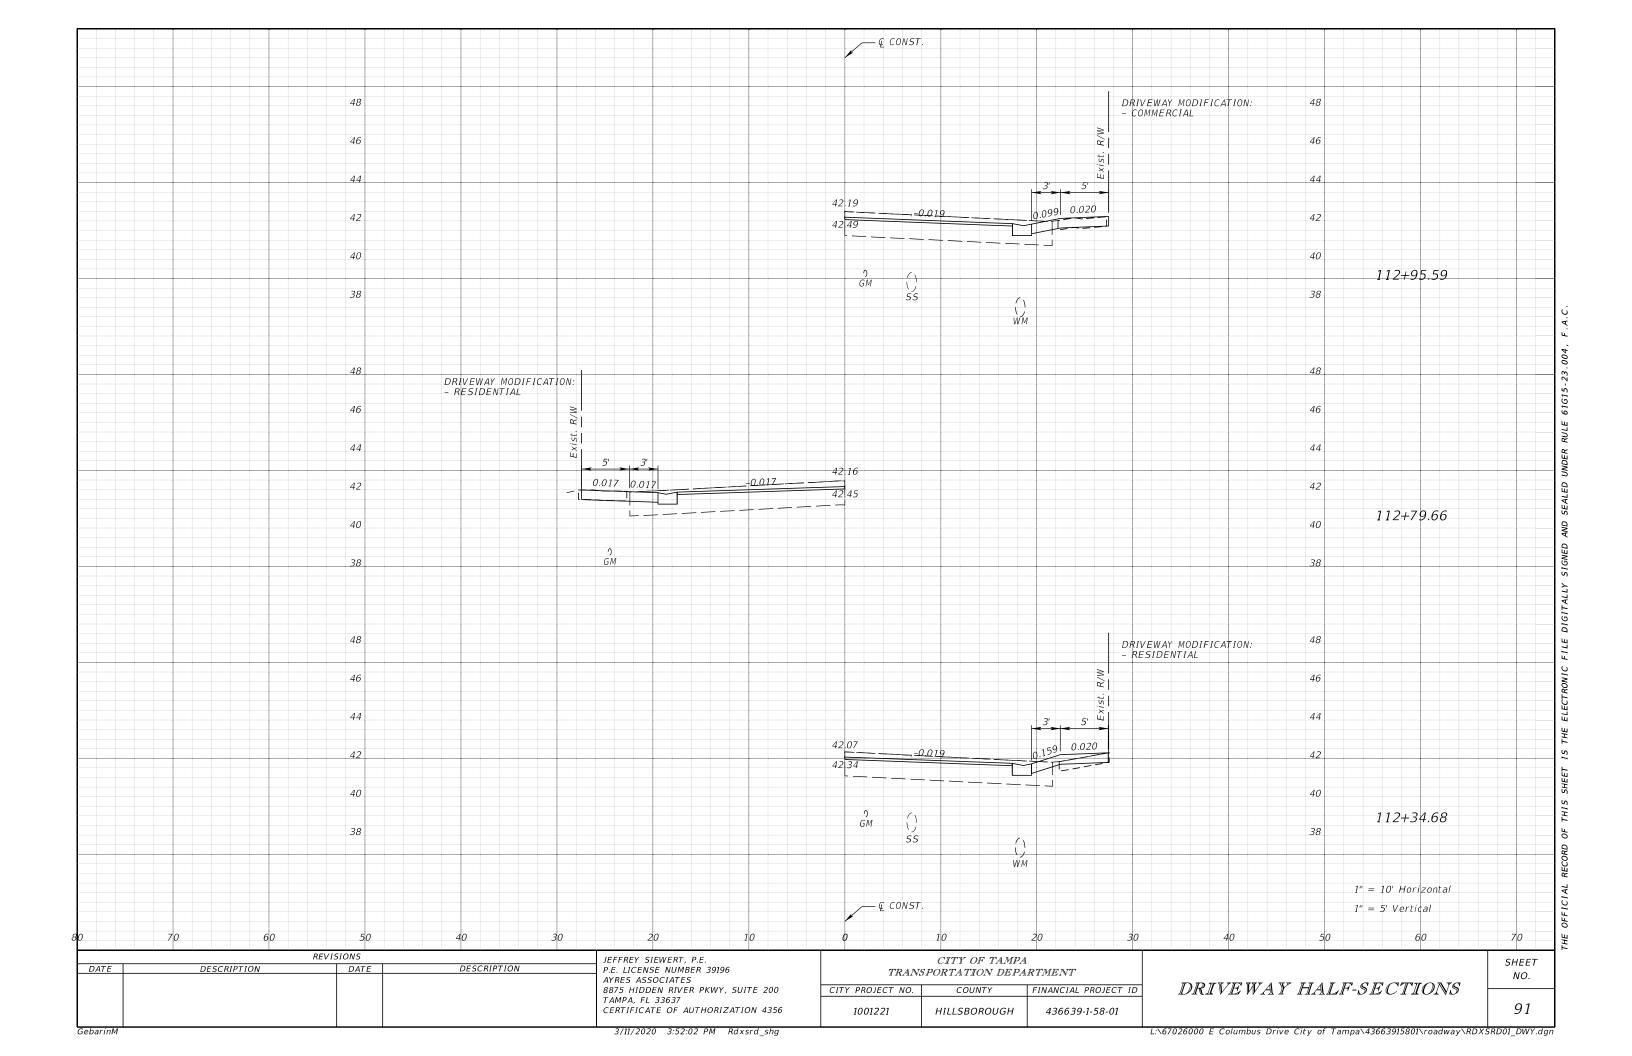


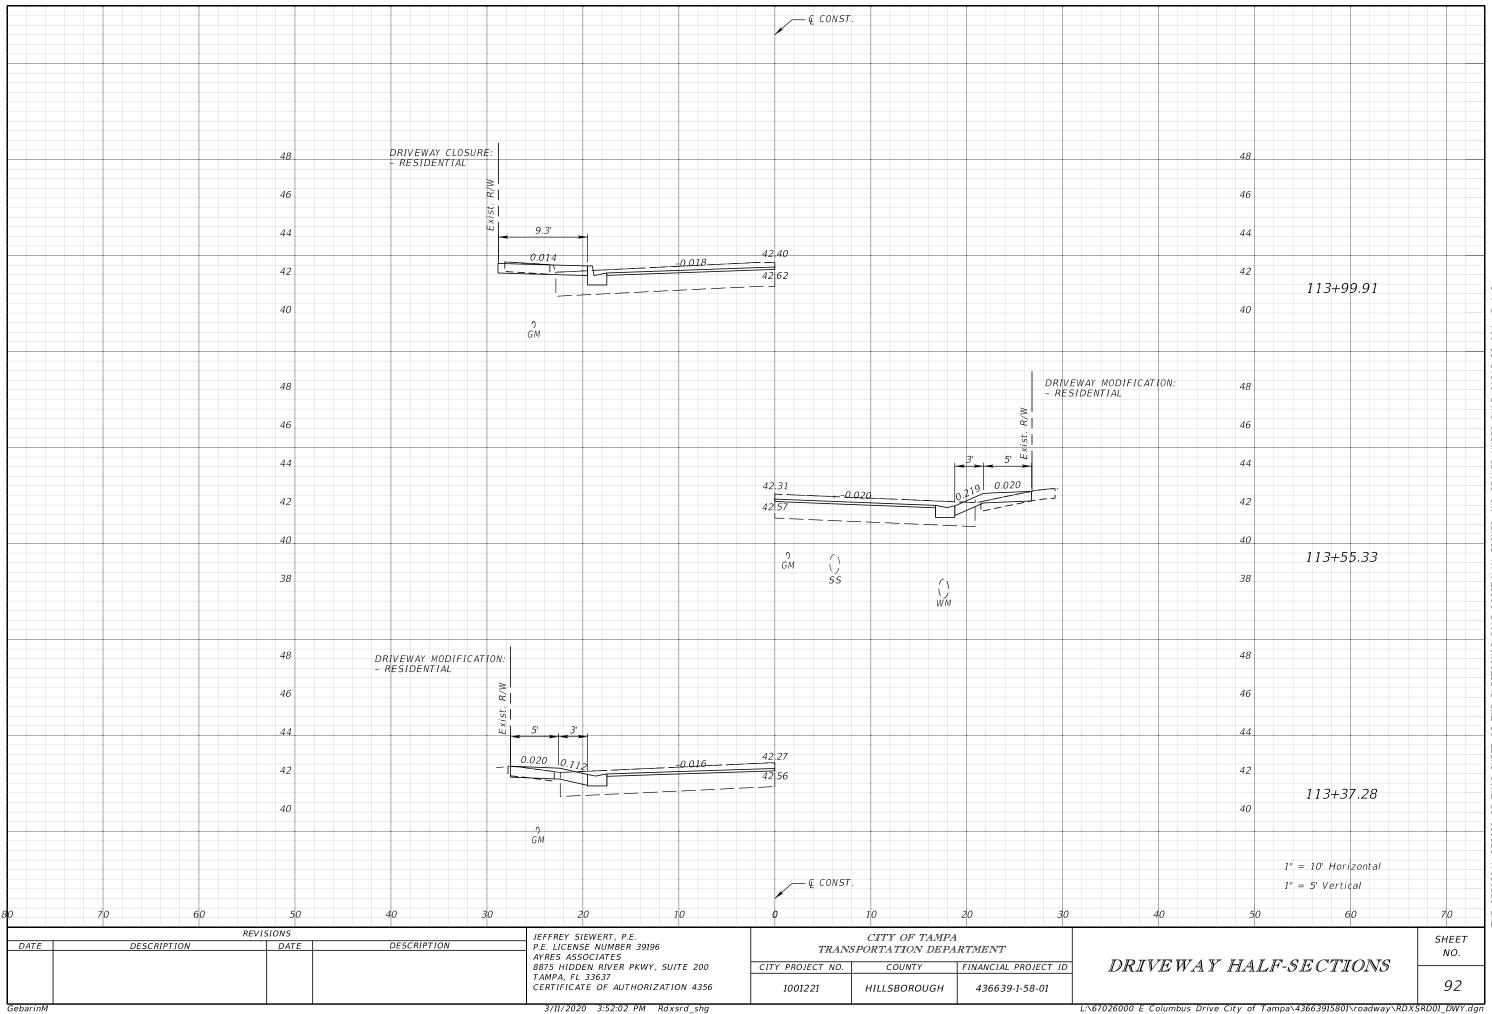


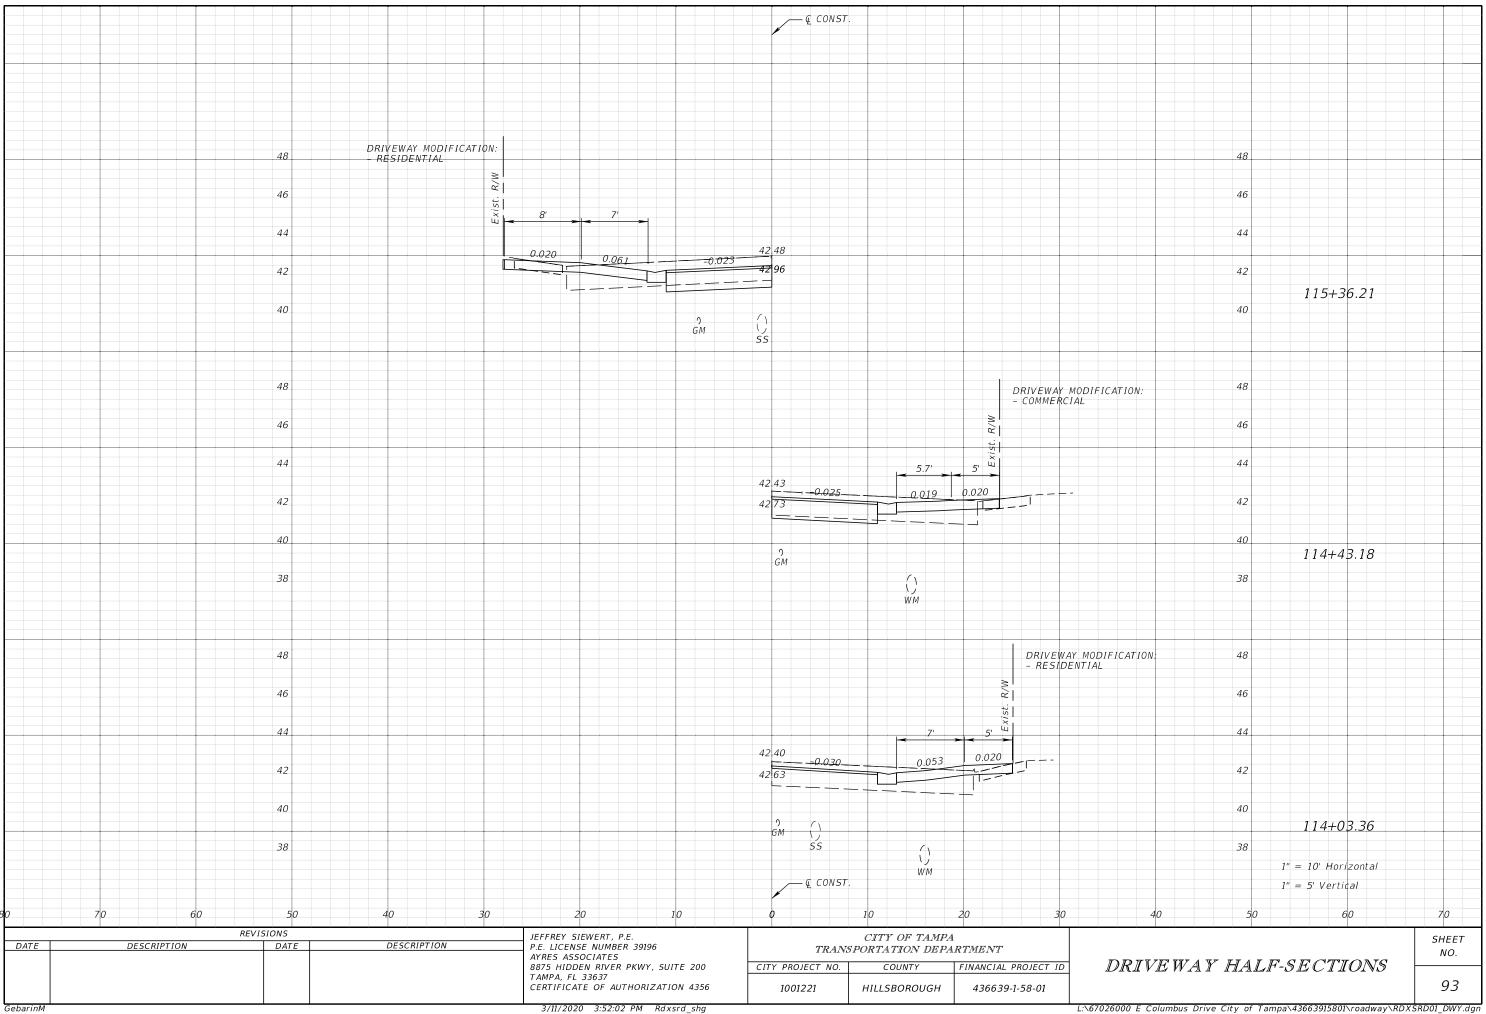


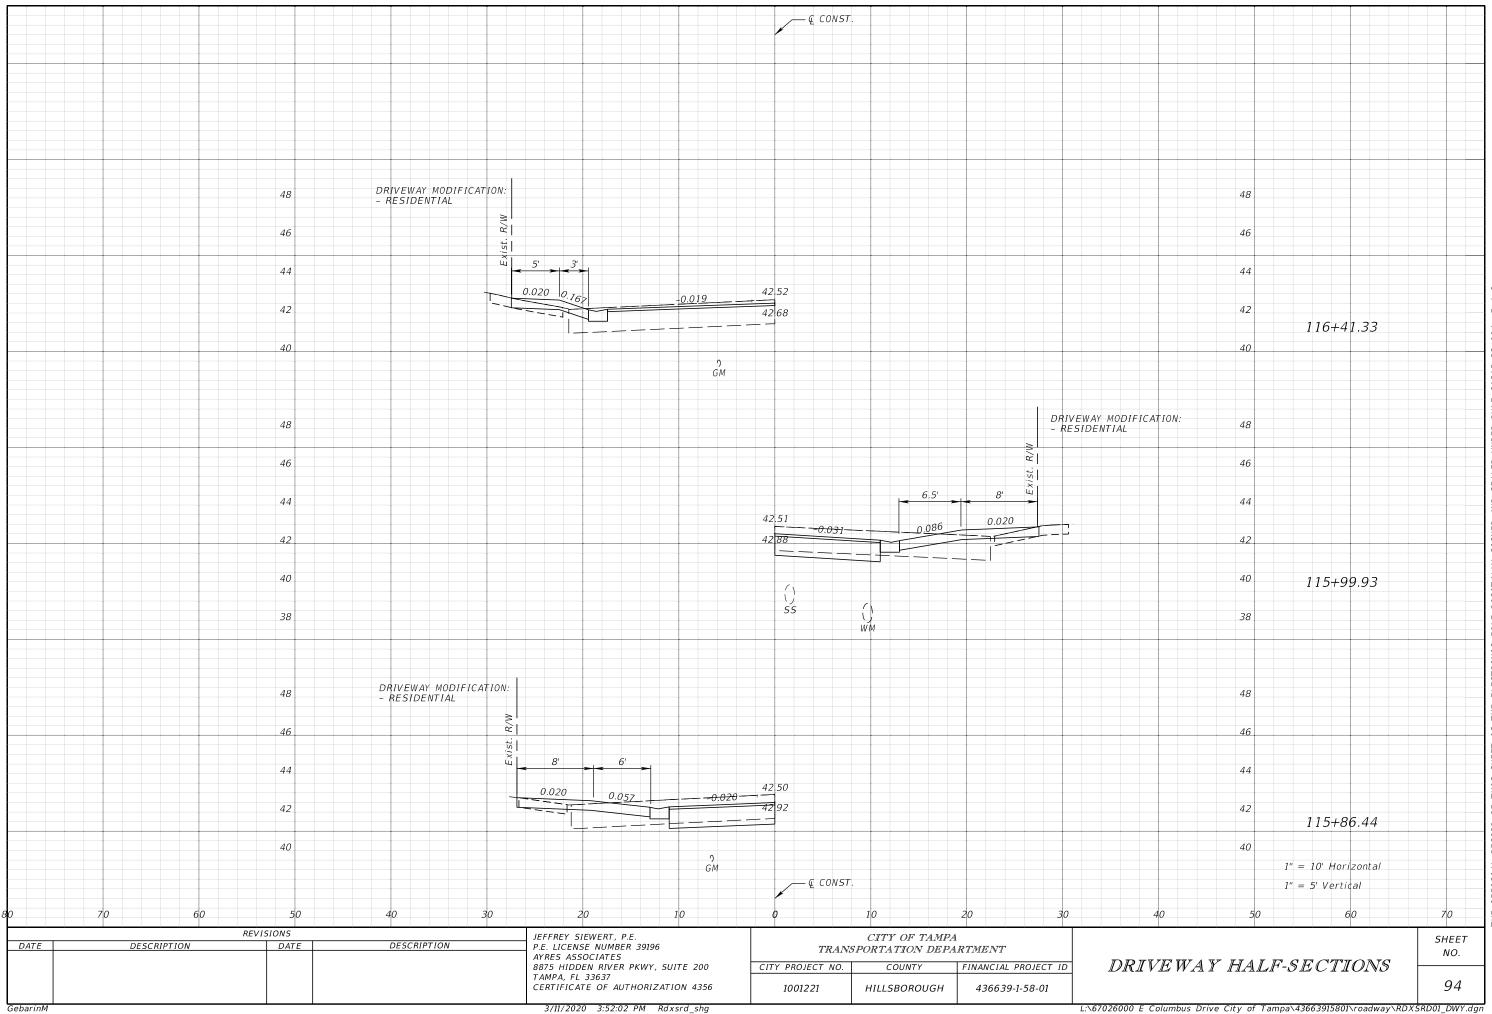


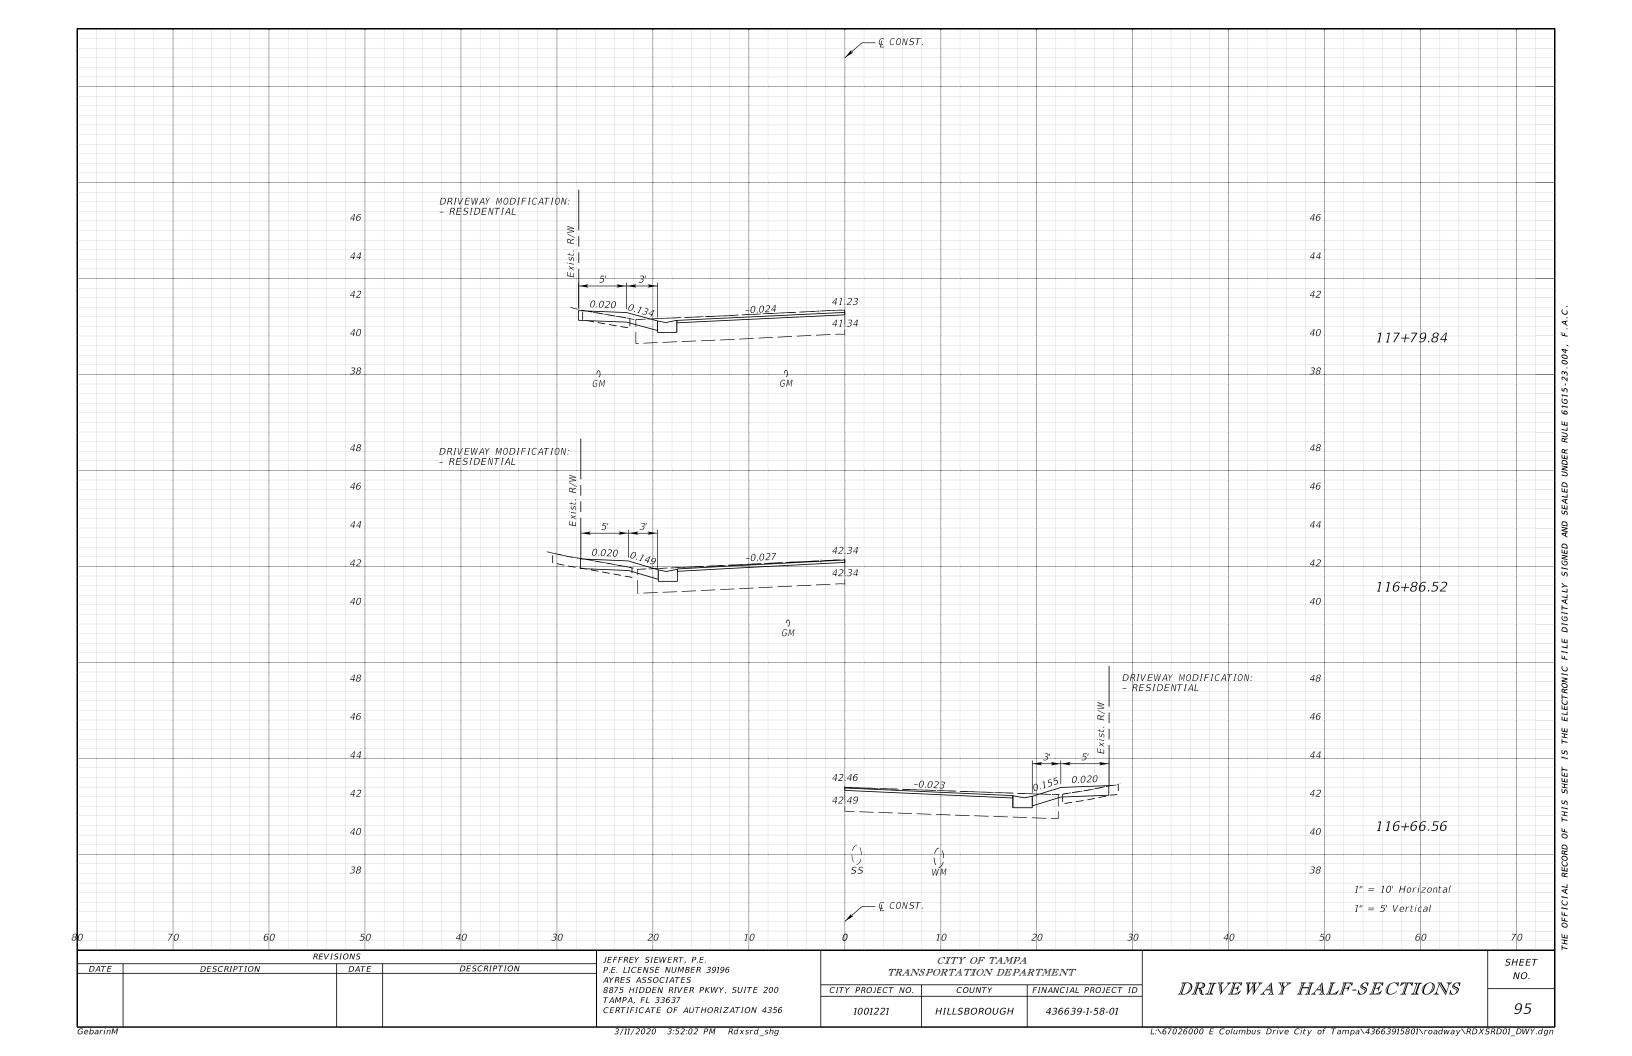

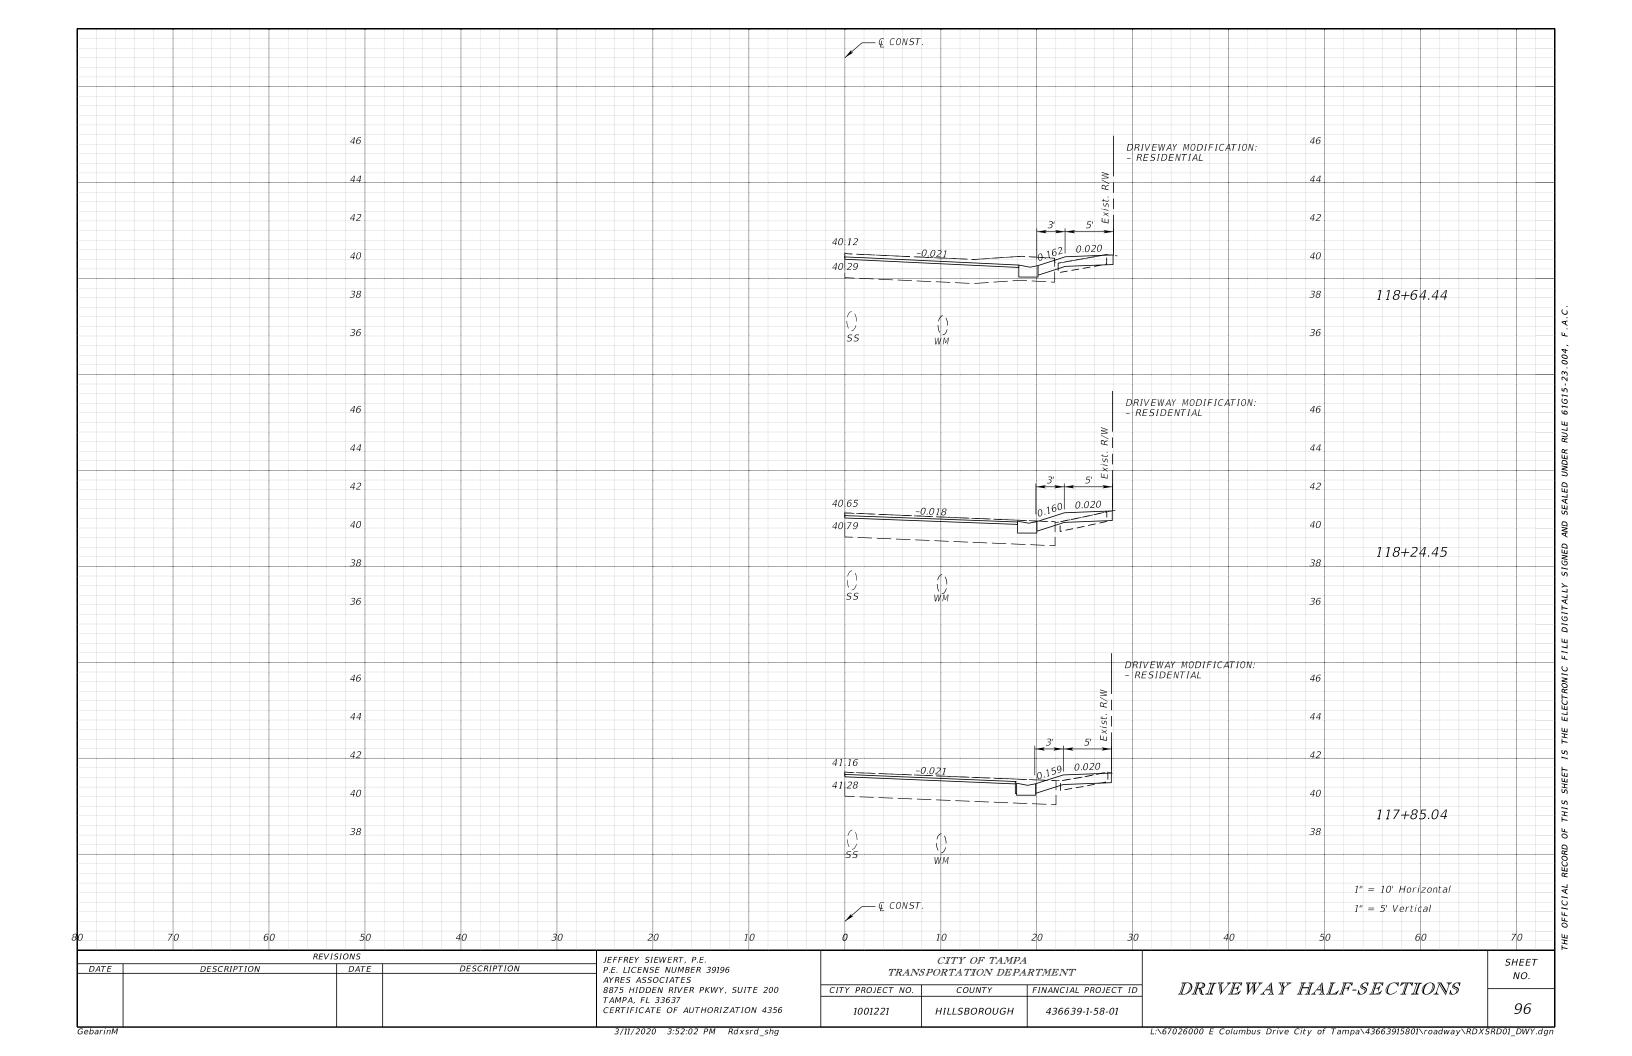

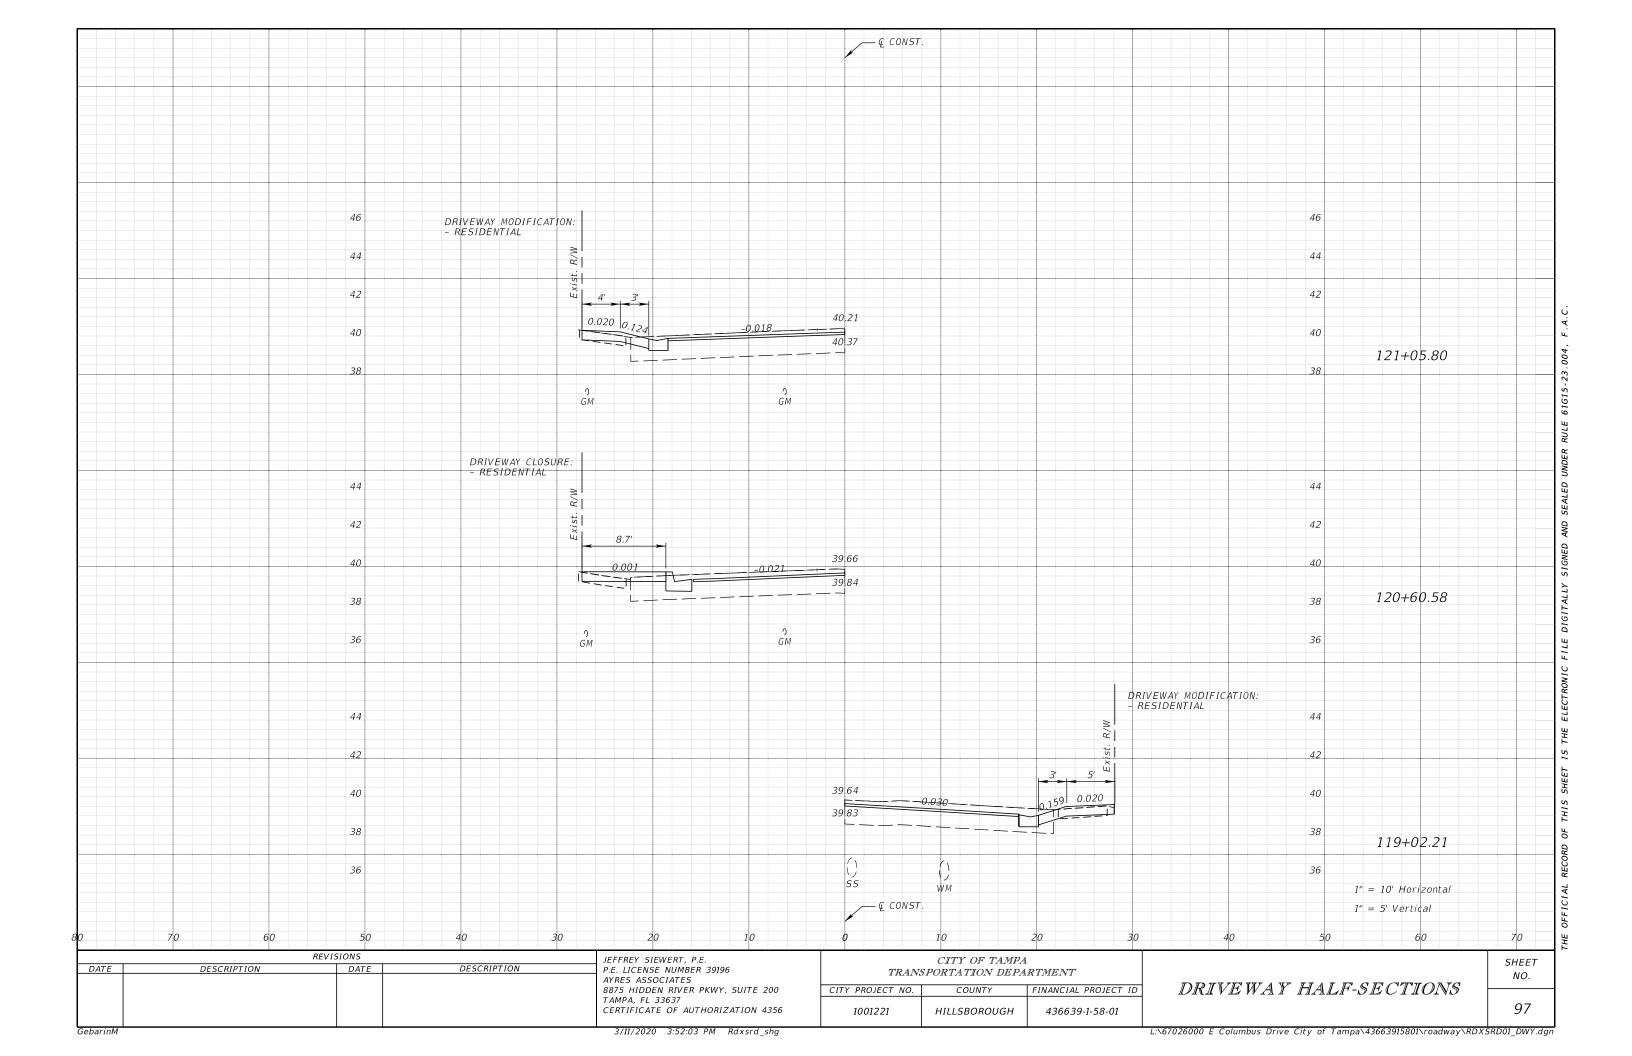

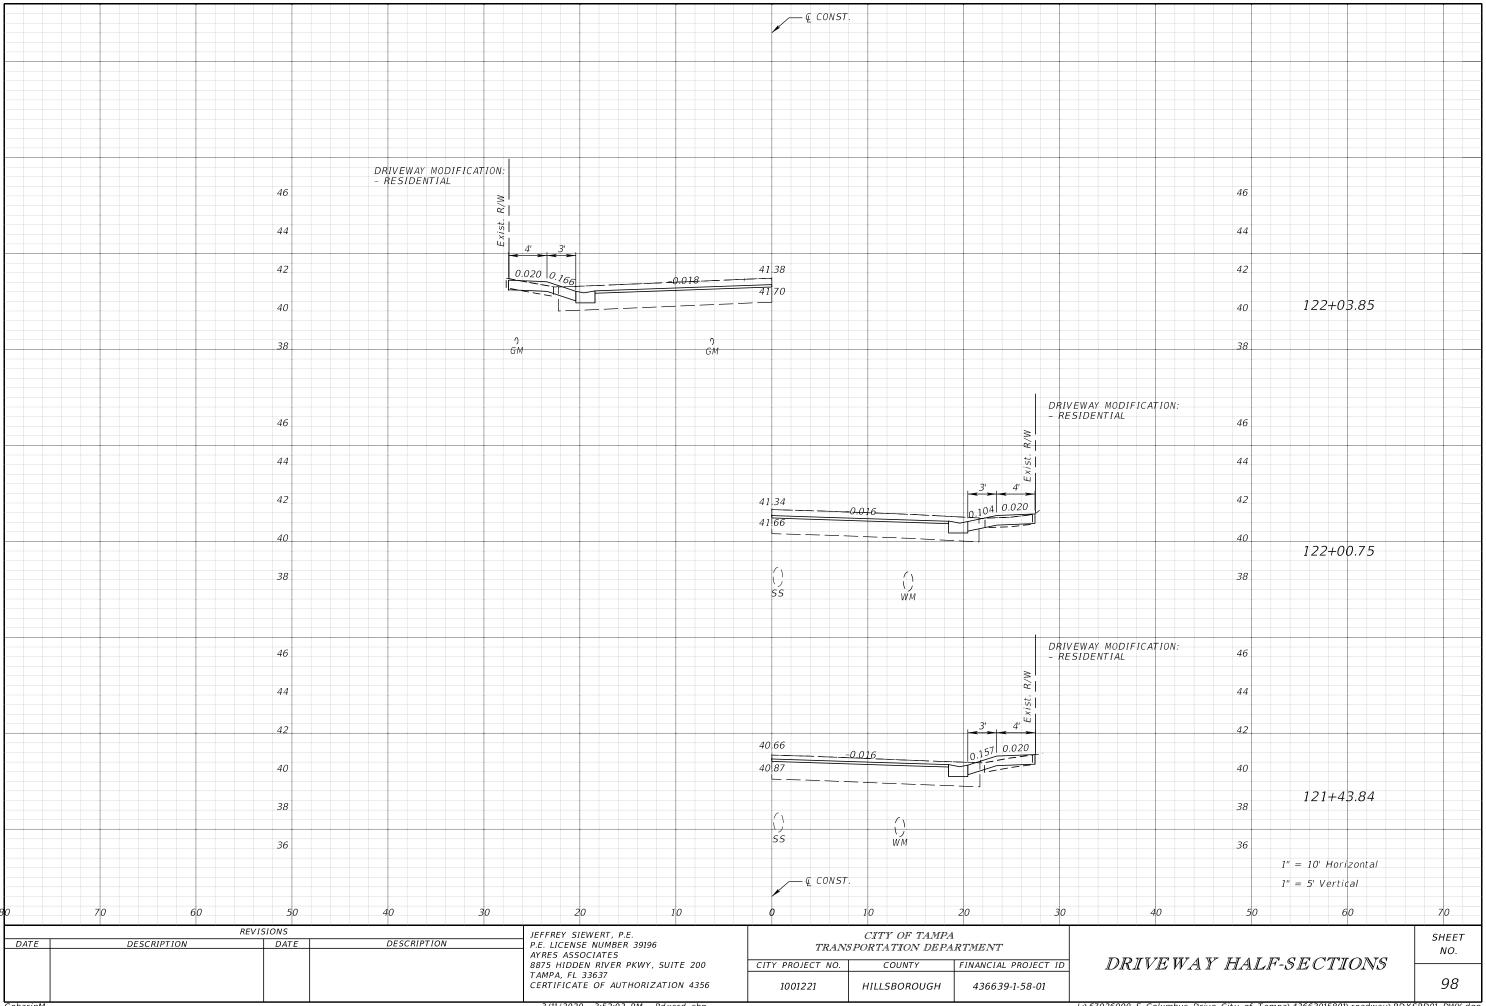

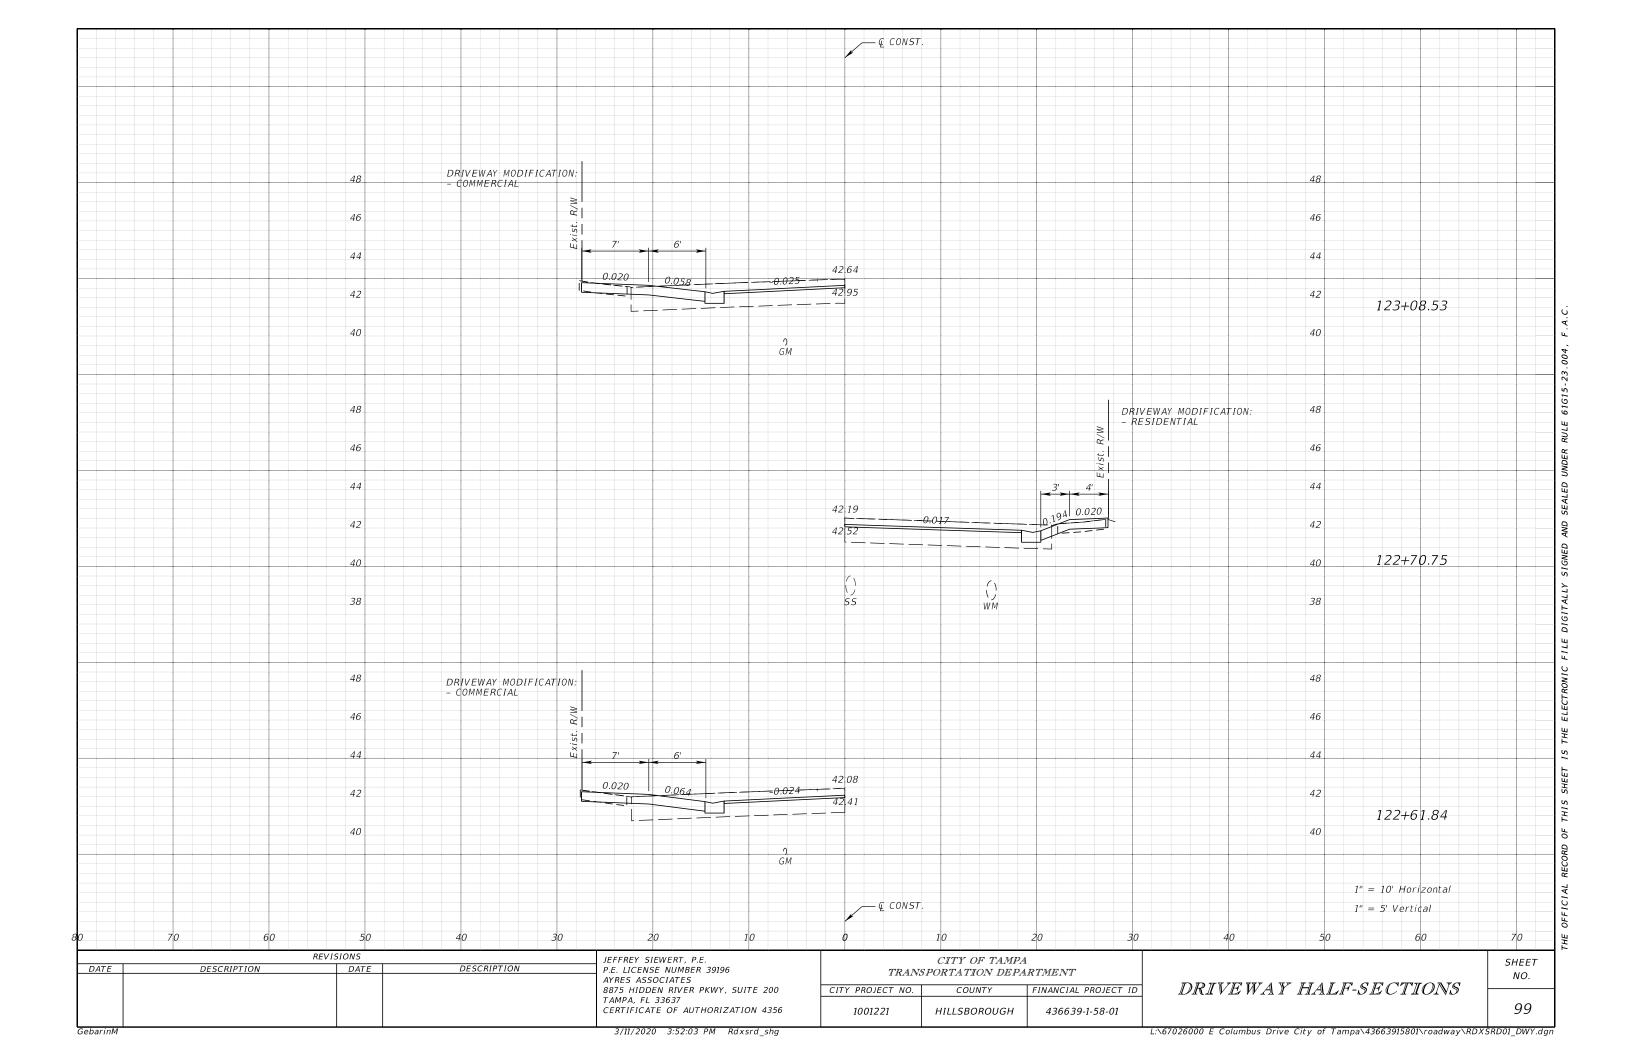

# TEMPORARY TRAFFIC CONTROL PLAN - NOTES

# **GENERAL**

- 1. FOR GENERAL TRAFFIC CONTROL ZONE REQUIREMENTS AND ADDITIONAL INFORMATION, REFER TO STANDARD PLANS INDEX, 102-600 SERIES. ALL CONSTRUCTION SHALL BE COMPLETED IN ACCORDANCE WITH INDEX NO. 102-600 SERIES UNLESS OTHERWISE NOTED.
- 2. THE EXACT LOCATION OF ALL SIGNS AND BARRICADES SHALL BE DETERMINED IN THE FIELD TO MEET THE STANDARD PLANS INDEX 102-600.
- 3. TEMPORARY REFLECTIVE PAVEMENT MARKERS SHALL BE PROVIDED WITH TEMPORARY STRIPING IN ACCORDANCE WITH INDEXES 102-600 AND 706-001.
- 4. ALL EXISTING PAVEMENT MARKINGS OUTSIDE OF THE CONSTRUCTION LIMITS THAT ARE REMOVED FOR TRAFFIC CONTROL PURPOSES ARE TO BE REPLACED IN-KIND UPON COMPLETION OF THE TRAFFIC CONTROL PURPOSE WHICH CAUSED ITS REMOVAL.
- 5. THROUGHOUT THE MILLING & RESURFACING OPERATIONS, USE A SELF-CONTAINED VACUUM TYPE MOBILE BROOM, OR EQUIVALENT, FOR CLEANUP OF MILLED DUST MATERIAL.
- 6. ENSURE THAT STREET NAME SIGNS ARE VISIBLE TO FACILITATE EMERGENCY VEHICLE TRAFFIC.
- 7. THERE WILL BE NO PAVEMENT MARKING ERADICATION PERMITTED AFTER THE FINAL ASPHALT COURSE IS PLACED. ANY EXISTING ROADWAYS THAT HAVE TEMPORARY STRIPING ERADICATED SHALL HAVE THE FULL WIDTH OF THE EXISTING TOP PAVEMENT COURSE MILLED AND RESURFACED PRIOR TO FINAL ACCEPTANCE.

# **PEDESTRIANS**

- 1. PEDESTRIAN FACILITIES SHALL BE MAINTAINED AND SHALL CONFORM TO ADA REQUIREMENTS.
- THROUGHOUT THE PROJECT LIMITS WHERE SIDEWALKS CURRENTLY EXIST, PEDESTRIAN TRAFFIC SHALL BE MAINTAINED ON AT LEAST ONE SIDE OF EACH ROADWAY ON THE PROJECT AT ALL TIMES, USING 102-660. THE SIDEWALK TRAVEL WAY SHALL BE A MINIMUM OF 4-FT WIDE, WITH A PAVED SURFACE, RAMPED AS PER INDEX 522-002. TEMPORARY ASPHALT MAY BE USED FOR THE PAVED SURFACE AND SHALL BE PAID FOR UNDER LUMP SUM MAINTENANCE OF TRAFFIC, PAY ITEM 102-1. ENSURE THAT A SAFE AND UNOBSTRUCTED ROUTE EXISTS FOR PEDESTRIANS, INCLUDING AT BUS STOP LOCATIONS. REFER TO STANDARD PLANS INDEX 102-660.
- 3. ASPHALT MILLINGS ARE NOT ALLOWED FOR TEMPORARY SIDEWALK

# SIGNALS, SIGNING & MARKING

- 1. ALL EXISTING WARNING, GUIDE, AND REGULATORY SIGNS SHALL BE MAINTAINED AT ALL TIMES. SIGNS SHALL BE RELOCATED, REMOVED OR COVERED FOR EACH PHASE'S TRAFFIC PATTERN.
- 2. ALL EXISTING TRAFFIC SIGNALS SHALL BE MAINTAINED DURING ALL PHASES OF CONSTRUCTION. IN CASES WHERE THE SIGNAL IS TO BE REMOVED IN THE FINAL PLANS, THE SIGNAL SHALL BE MAINTAINED UNTIL THE INTERSECTION IS IN ITS FINAL CONFIGURATION AS SHOWN IN THE TRAFFIC CONTROL PLANS.
- 3. ALL EXISTING SIGNS TO REMAIN, UNLESS NOTED OTHERWISE.

# LANE CLOSURES / DETOURS

- IN ACCORDANCE WITH FDOT SPECIFICATION 8-8.4, SPECIAL EVENT DAYS FOR THIS PROJECT INCLUDE:
   A. ALL EVENTS AT THE AMALIE ARENA WITH AN ANTICIPATED CROWD OF 15,000 ATTENDEES OR HIGHER
   B. ALL EVENTS IN DOWNTOWN TAMPA OR BAYSHORE BLVD (TAMPA) WITH AN ANTICIPATED CROWD OF 20,000 ATTENDEES OR HIGHER
   C. ALL EVENTS IN YBOR CITY OR WITH AN ANTICIPATED CROWD OF 20,000 ATTENDEES OR HIGHER
  - NO DETOUR SHALL BE ACTIVE DURING ANY OF THESE LISTED EVENTS.
- 2. PLACE A PCMS 7 DAYS IN ADVANCE OF ANY CLOSURES, TRAFFIC SHIFTS, OR DETOUR NOTIFYING THE PUBLIC OF THE UPCOMING

MESSAGE 1: ROAD	MESSAGE 2: BEGIN
WORKON	MM/DD
COLUMBUS	

- 3. COORDINATE ALL WORK, ALL LANE CLOSURES, AND ALL TEMPORARY TRAFFIC CONTROL WITH ANY OTHER PROJECTS IN THE VICINITY.
- 4. THE DETOURS ILLUSTRATED IN THE DETOUR SHEETS SHOULD BE APPLIED IN ALL INSTANCES.
- 5. ACCESSABILITY TO LOCAL TRAFFIC TO BE MAINTAINED AT ALL TIMES.
- 6. TRAFFIC SHIFT SET UPS AND BREAK DOWNS, ROADWAY STRIPING AND MARKING SHALL BE DONE DURING THE NIGHT HOURS OF 9 PM TO 6 AM.
- 7. NO LANE CLOSURES ALLOWED ON NEBRASKA AVENUE FROM 6 AM TO 9:30 PM

# TTCP GENERAL NOTES

# REVISIONS DATE DESCRIPTION DATE DESCRIPTION P.E. LICENSE NUMBER 39196 AYRES ASSOCIATES 8875 HIDDEN RIVER PKWY, SUITE 200 TAMPA, FL 33637 CERTIFICATE OF AUTHORIZATION 4356

# PHASE 1 - MILL ALONG E COLUMBUS DR FROM N NEBRASKA AVE TO N 14TH ST

THE INTENT OF THIS PHASE IS TO SHIFT EASTBOUND AND WESTBOUND TRAFFIC TO THE EXISTING EASTBOUND LANE. THIS WILL ALLOW FOR MILLING OF THE WESTBOUND LANE. AFTERWARDS SHIFT EASTBOUND AND WESTBOUND TRAFFIC TO THE NEWLY MILLED WESTBOUND LANE. THIS WILL ALLOW FOR MILLING OF THE EASTBOUND LANE. REPEAT THIS PROCESS UNTIL EXISTING ASPHALT HAS BEEN MILLED 1.5" BELOW FINAL SURFACE GRADE. PLACE TEMPORARY PAVEMENT IN AREAS OF EXPOSED EXISTING BASE.

- 1. INSTALL TRAFFIC CONTROL DEVICES AND SIGNING IN ACCORDANCE WITH STANDARD PLAN INDICES 102-603 AND 102-605.
- 2. MILL EXISTING OVERLAYED ASHPALT AT 1.5" INCREMENTS UNTIL EXISTING PAVEMENT IS 1.5" BELOW FINAL SURFACE GRADE.

CONCURRENT WORK:

1. INSTALL EROSION CONTROL DEVICES.

# PHASE 2 - RECONSTRUCTION ALONG E COLUMBUS DR FROM N NEBRASKA AVE TO N 14TH ST

THE INTENT OF THIS PHASE IS TO SHIFT EASTBOUND AND WESTBOUND TRAFFIC TO THE EXISTING EASTBOUND LANE. THIS WILL ALLOW FOR RECONSTRUCTION OF THE WESTBOUND LANE. AFTERWARDS SHIFT EASTBOUND AND WESTBOUND TRAFFIC TO THE NEWLY RECONSTRUCTION OF THE EASTBOUND LANE. IN AREAS WHERE PROPOSED CURB AND SIDEWALK WILL BE INSTALLED, USE TEMPORARY PAVEMENT UNTIL PHASE 3 IS COMPLETED.

- 1. INSTALL TRAFFIC CONTROL DEVICES AND SIGNING IN ACCORDANCE WITH STANDARD PLAN INDICES 102-603 AND 102-605.
- 2 INSTALL LOW PROFILE BARRIERS PER STANDARD PLAN INDEX 102-120


# PHASE 3 - SIDEWALK CONSTRUCTION ALONG E COLUMBUS DR FROM N NEBRASKA AVE TO N 14TH ST

THE INTENT OF THIS PHASE IS TO SHIFT EASTBOUND AND WESTBOUND TRAFFIC TO THE NEWLY MILLED EASTBOUND LANE. THIS WILL ALLOW FOR THE INSTALLATION OF TEMPORARY BARRIER WALLS (SEE FIGURE 1 BELOW) TO ACCOMODATE PEDESTRIAN ACCESS DURING THE CONSTRUCTION OF NEW SIDEWALK AND CURB AND GUTTER. AFTERWARDS SHIFT THE EASTBOUND AND WESTBOUND TRAFFIC TO THE EASTBOUND LANE. THIS WILL ALLOW FOR THE CONSTRUCTION OF NEW SIDEWALK AND CURB AND GUTTER ALONG THE NORTH SIDE OF THE ROADWAY. MAINTAIN PEDESTRIAN ACCESS AND HART BUS STOP LOCATIONS AT ALL TIMES.

- 1. INSTALL TRAFFIC CONTROL DEVICES AND SIGNING IN ACCORDANCE WITH STANDARD PLAN INDICES 102-603 AND 102-605.
- 2. CONSTRUCT CURB & GUTTER, SIGNALIZATION, SIGNING, AND DRAINAGE IMPROVEMENTS WITHIN WORK ZONE.

CONCURRENT WORK:

1. SIGN CONSTRUCTION.

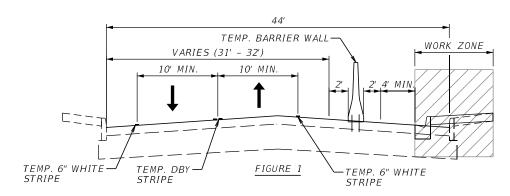

# PHASE 4 - RESURFACE ALONG E COLUMBUS DRIVE FROM NEBRASKA AVE TO N 14TH ST

THE INTENT OF THIS PHASE IS TO SHIFT EASTBOUND AND WESTBOUND TRAFFIC TO THE EXISTING EASTBOUND LANE. THIS WILL ALLOW FOR FINAL RESURFACING OF THE WESTBOUND LANE. AFTERWARDS SHIFT NORTHBOUND AND SOUTHBOUND TRAFFIC TO THE NEWLY RESURFACED WESTBOUND LANE. THIS WILL ALLOW FOR FINAL RESURFACING OF THE EASTBOUND LANE.

- 1. INSTALL TRAFFIC CONTROL DEVICES, CONFIGURE ONE-LANE TWO-WAY SETUP, AND SIGNING IN ACCORDANCE WITH STANDARD PLAN INDEX 102-603 AND 102-605.
- 2. RESURFACE TO PROPOSED PROFILE GRADE LINE AND CROSS SLOPES.
- 3. INSTALL PAINTED PAVEMENT MARKINGS AS SHOWN IN THE SIGNING AND PAVEMENT MARKING PLANS.

CONCURRENT WORK:

1. CONSTRUCT CONCRETE PATTERNED CROSSWALKS.

TTCP PHASING NOTES

CITY OF TAMPA TRANSPORTATION DEPARTMENT							
CITY PROJECT NO.	COUNTY	FINANCIAL PROJECT ID					
1001221	HILLSBOROUGH	436639-1-58-01					

TEMPORARY TRAFFIC
CONTROL PLANS (1)


SHEET NO.

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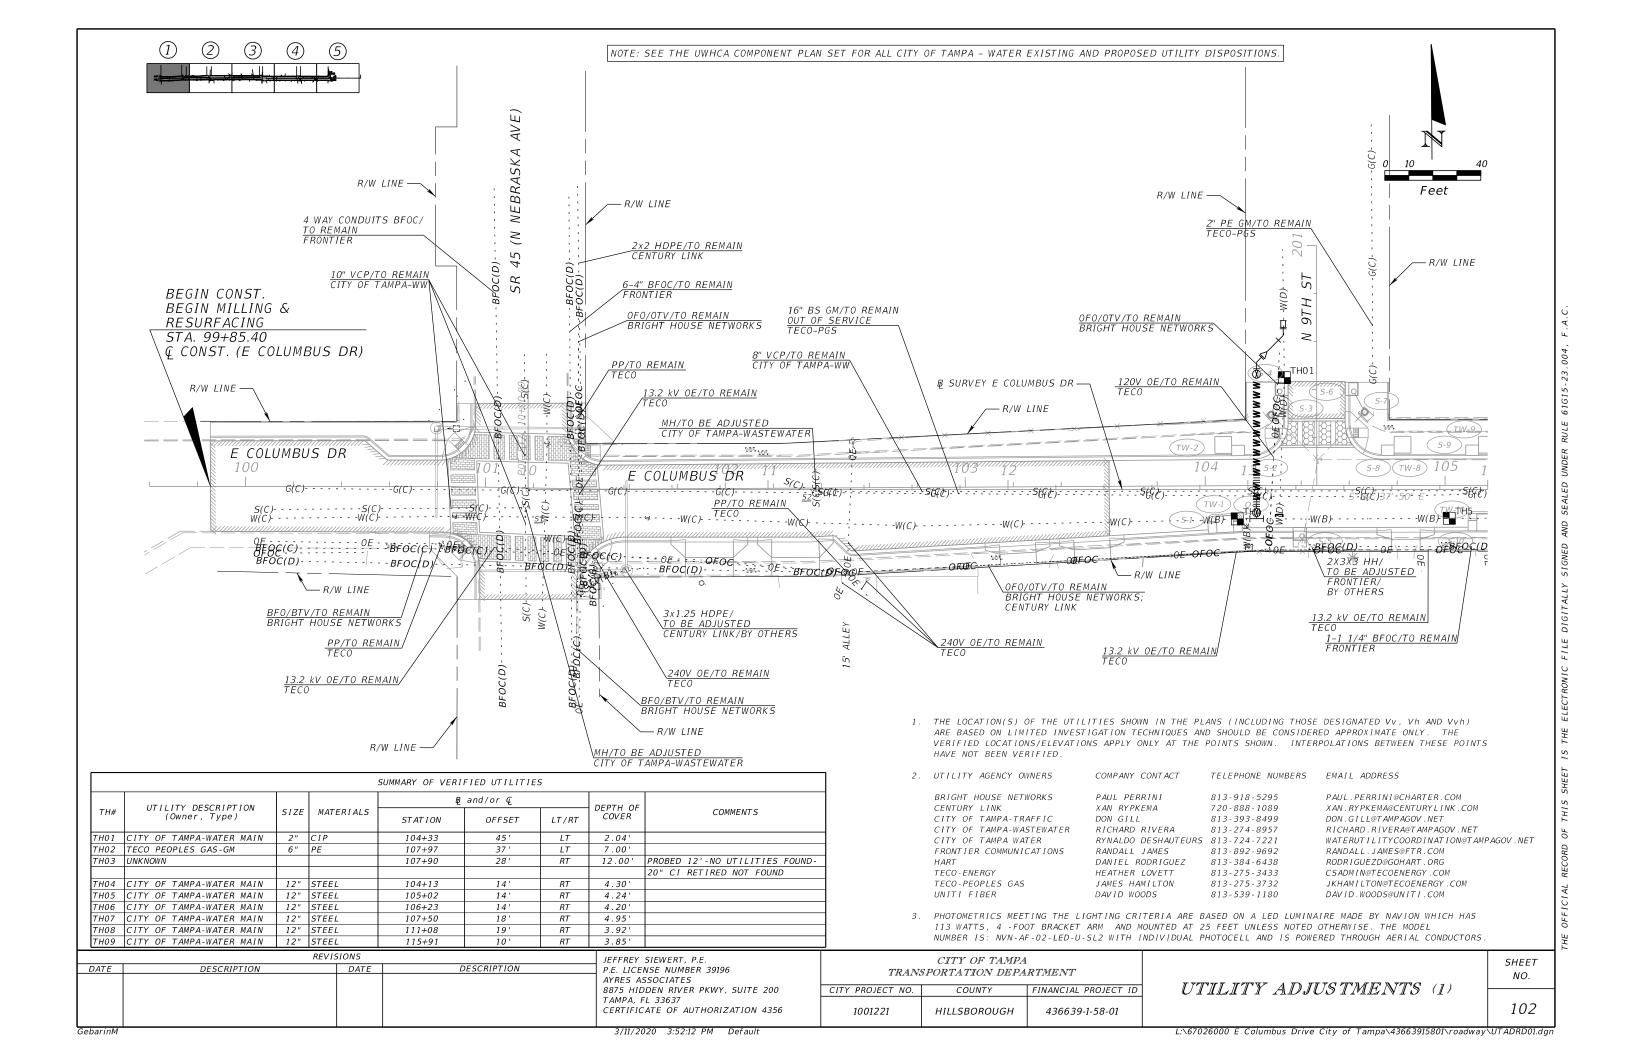
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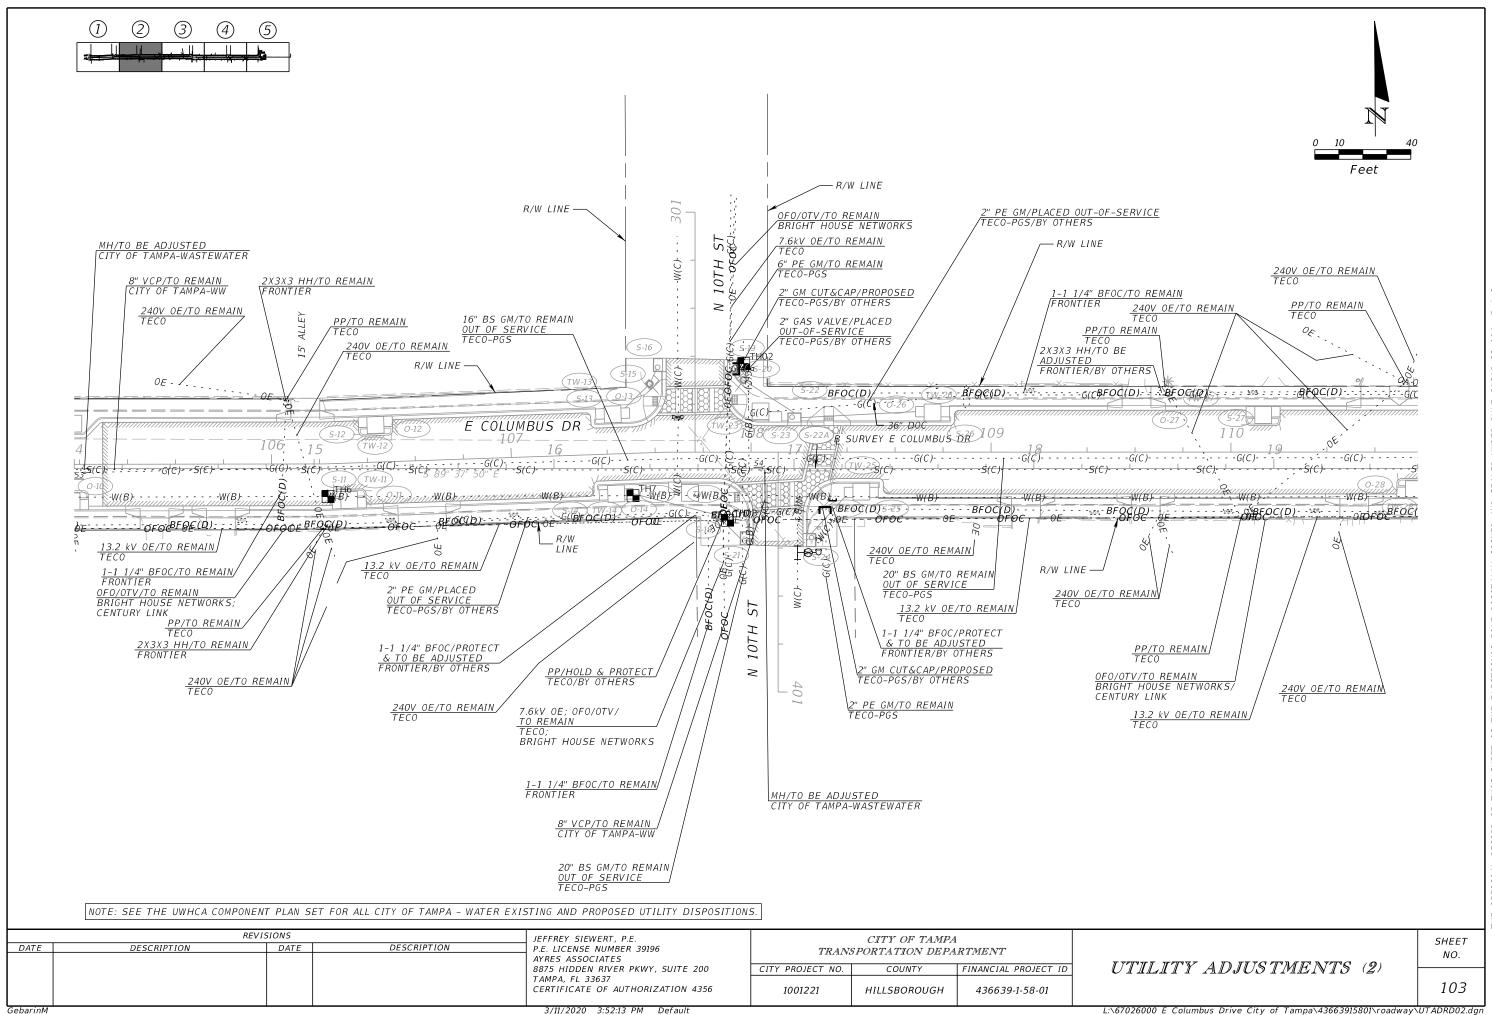
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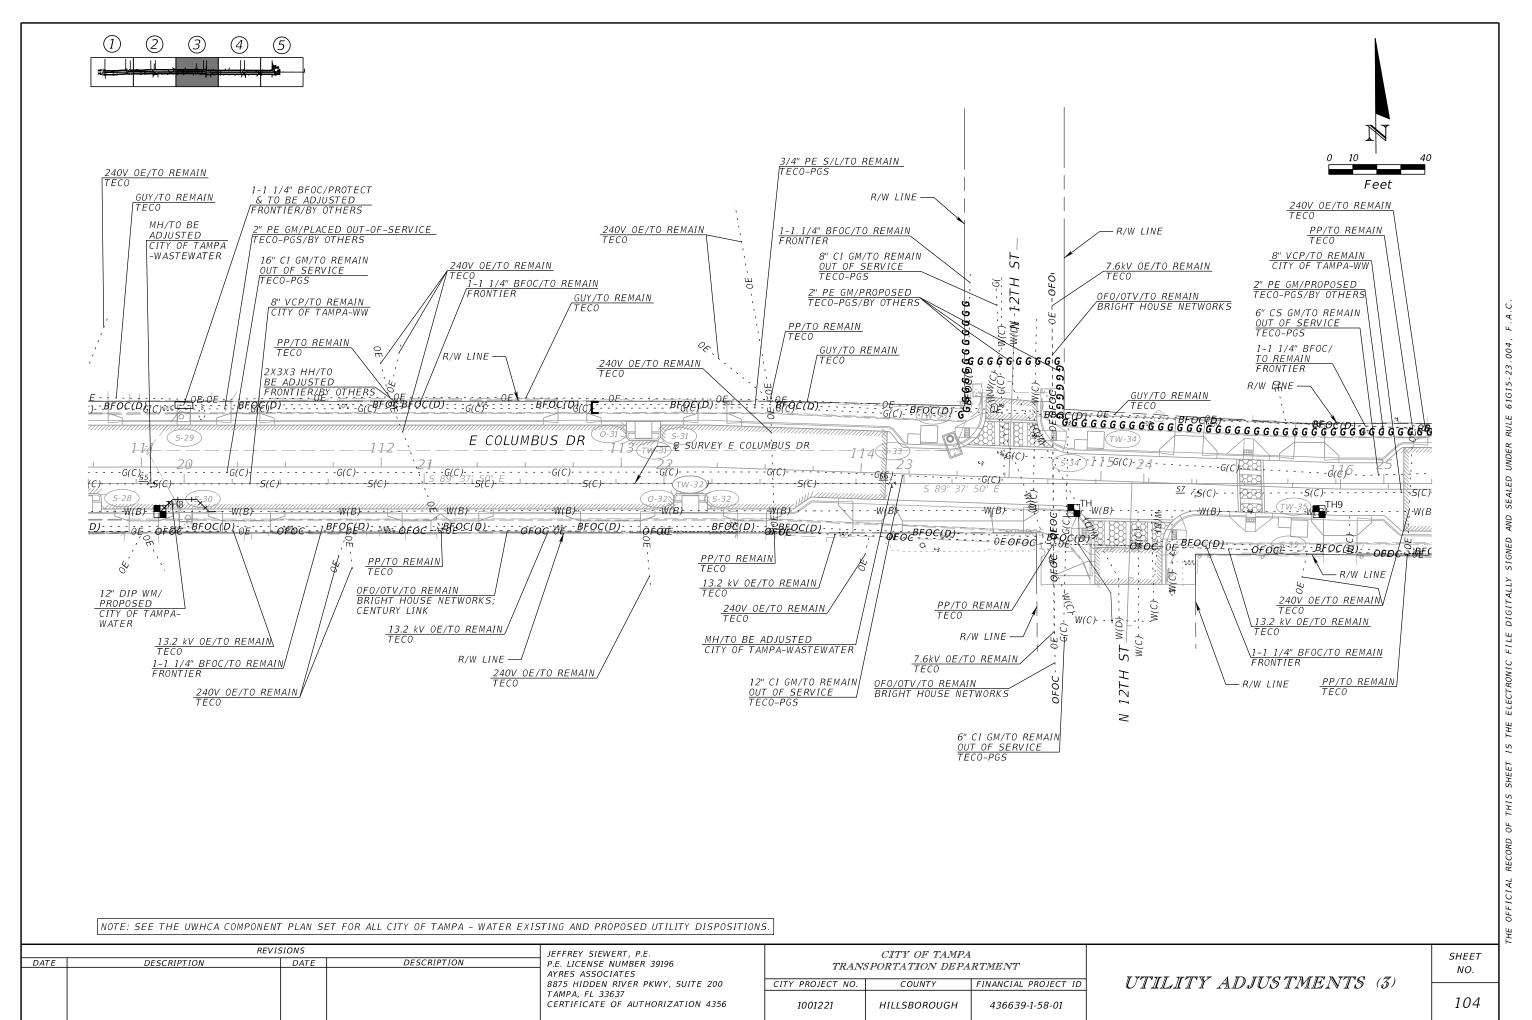
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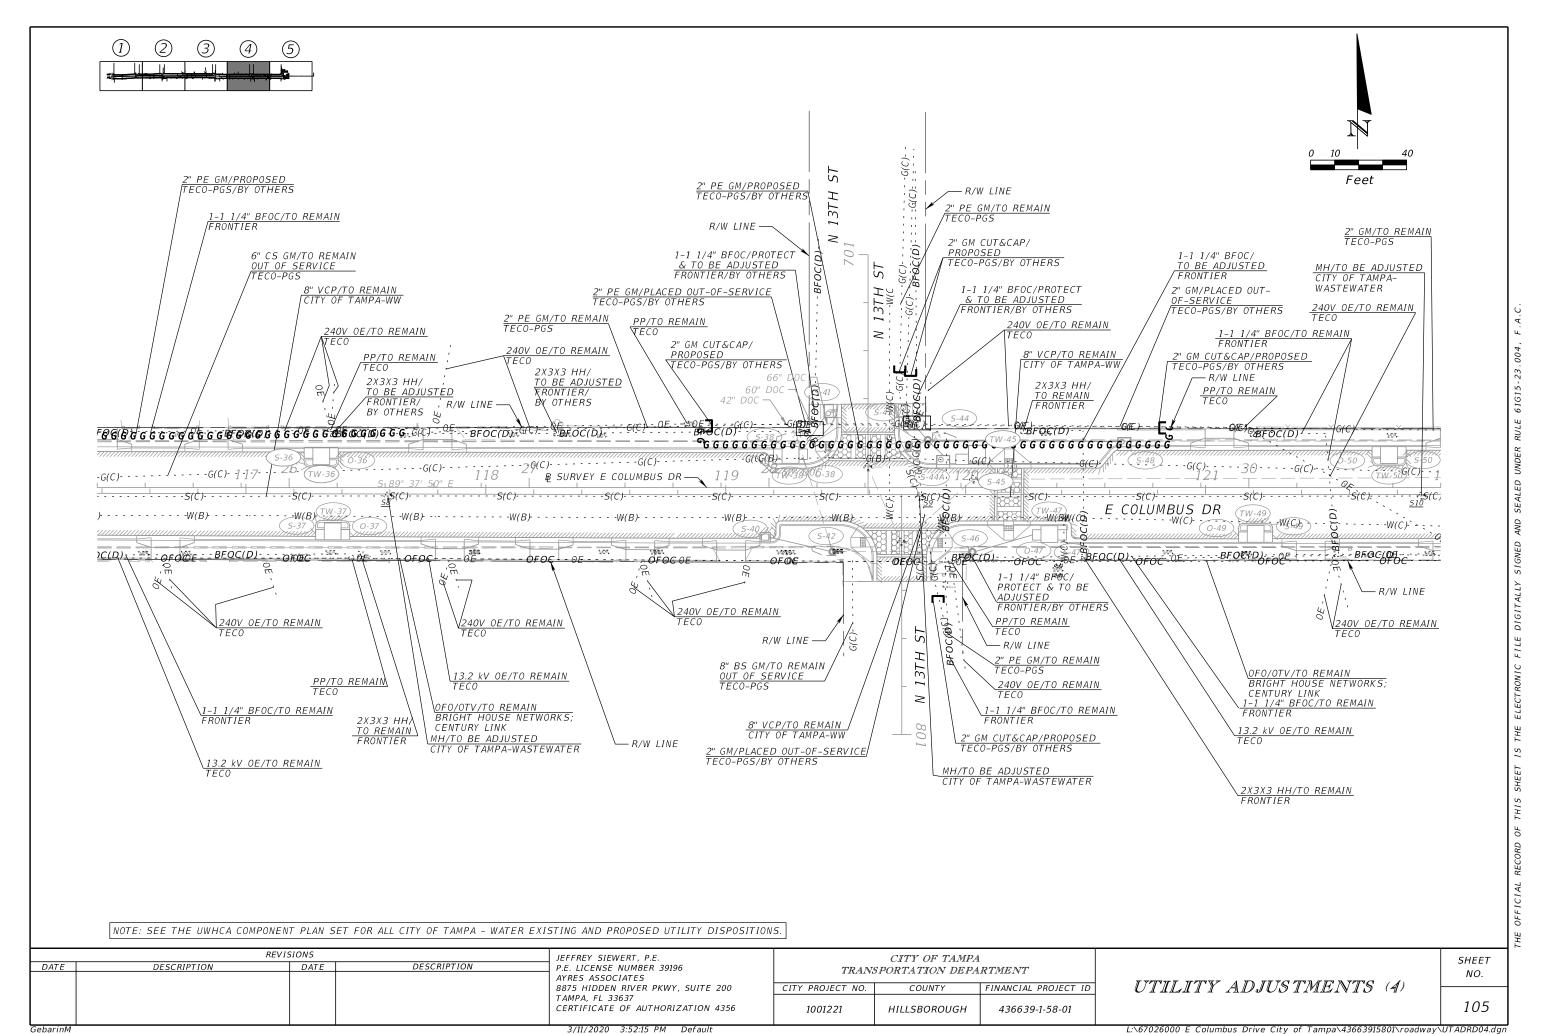





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PAY ITEM NOTES

SHEET NO.

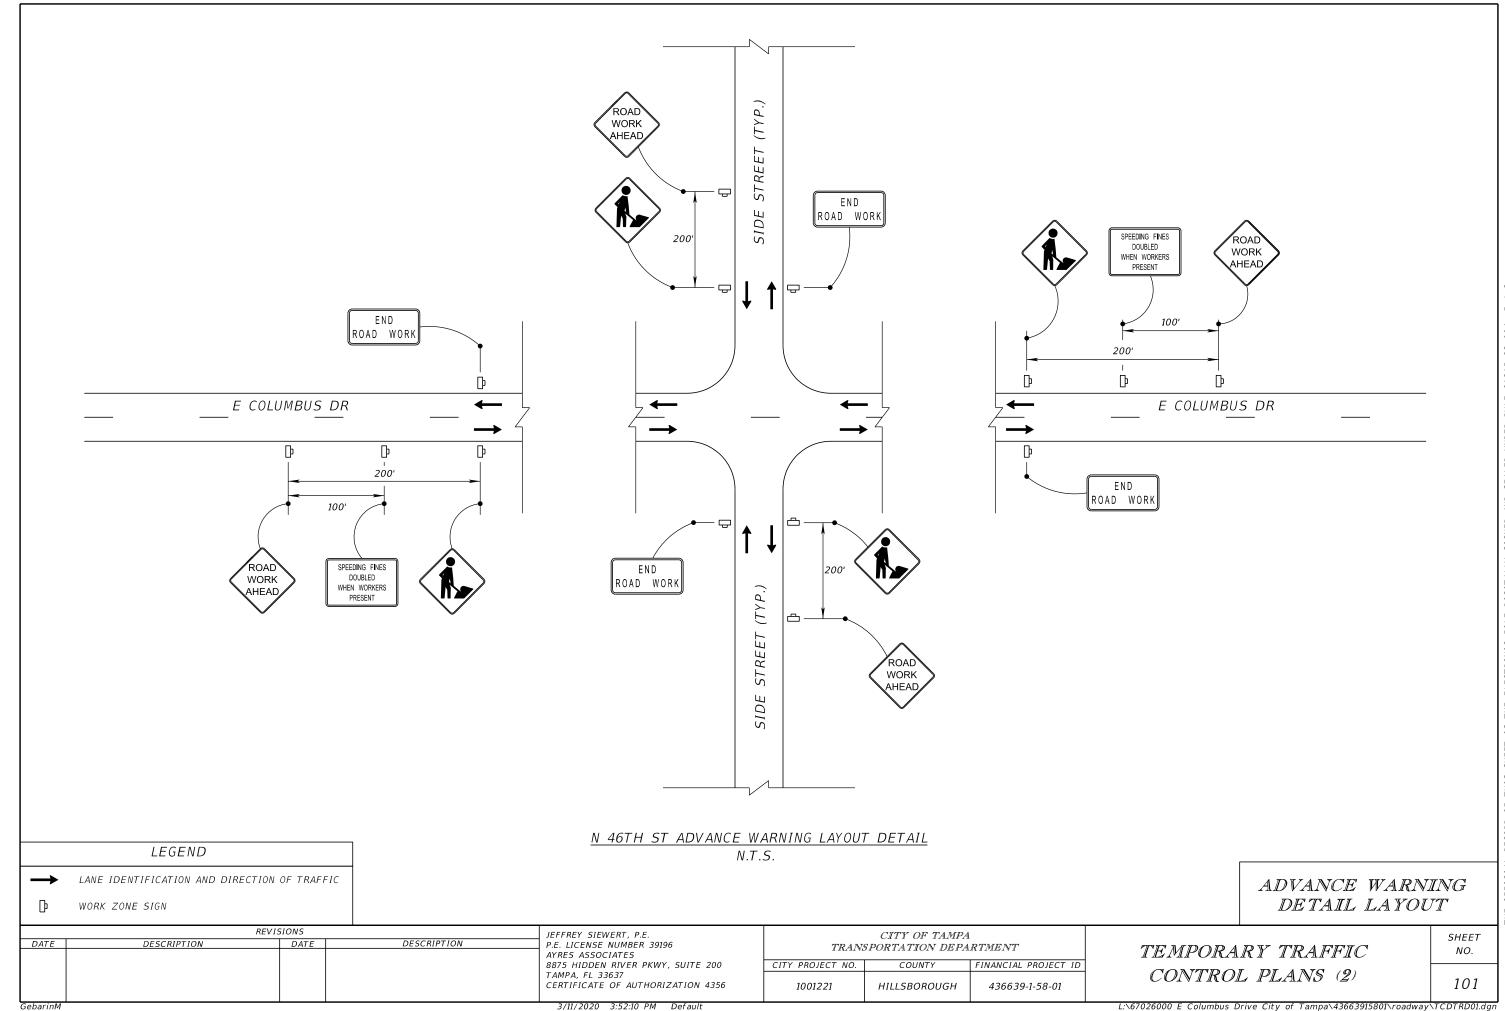SUMMARY OF LUMP SUM ITEMS

SUMMARY OF TEMPORARY TRAFFIC CONTROL PLANS

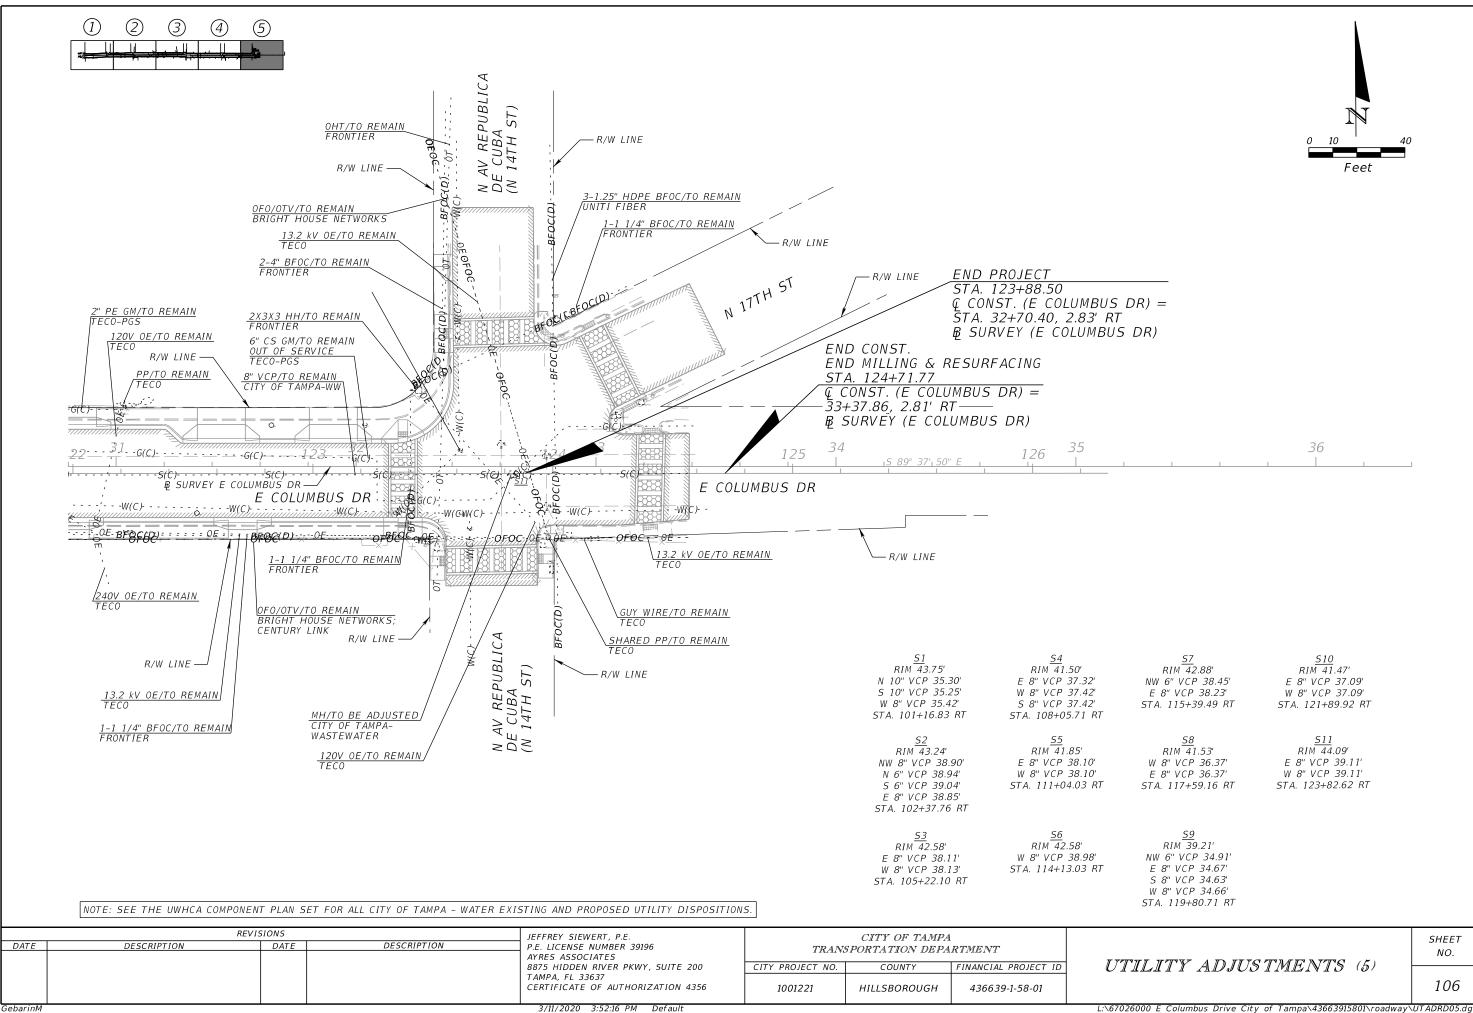SUMMARY OF CLEARING AND GRUBBING & REMOVAL ITEMS

SHEET NO.

0430-174-115 COST OF 35 CY OF FLOWABLE FILL BETWEEN CITY OF TAMPA WATERMAIN AND PROPOSED DRAINAGE STRUCTURES

TO BE INCIDENTAL TO THE COST OF APPLICABLE DRAINAGE STRUCTURES.

SUMMARY OF TEMPORARY SIGNALIZATION & DETECTION SQ-2 - SQ-4 SUMMARY OF EROSION AND SEDIMENT CONTROL DEVICES

0526-1-2 NOTIFY CITY OF TAMPA IN ADVANCE OF ANY POTENTIAL SHORTAGE OF HISTORIC BRICKS.

SUMMARY OF EARTHWORK

SHEET NO.

SQ-1

SQ-5

SQ-6 - SQ-7 SUMMARY OF PAVEMENT

SUMMARY OF UTILITY ADJUSTMENTS SQ-8

SUMMARY OF CURB & GUTTER AND/OR TRAFFIC SEPARATORS SQ-9

SQ-10 - SQ-13 SUMMARY OF SIDEWALK & DETECTABLE WARNINGS

	SUMMARY OF LUMP SUM ITEMS								
PAY ITEM	PAY ITEM DESCRIPTION	QUAN	TITY	DESIGN	CONSTRUCTION REMARKS				
NO.	TAT THEM BESCHITTION	P	F	NOTES					
0101 1	MOBILIZATION	1							
4.07	REMEDIATION	1							

	SUMMARY OF TEMPORARY TRAFFIC CONTROL PLAN ITEMS											
PAY ITEM	DAY ITEM DESCRIPTION		PHASE I			PHASE II			TOTAL		DESIGN	CONSTRUCTION
NO.	PAY ITEM DESCRIPTION	UNIT	DURAT I ON	QUANT ITY	TOTAL	DURAT I ON	TION QUANTITY TOTAL				NOTES	REMARKS
			DAYS	Р	P	DAYS	P	P	Р	F	7	
0102 1	MAINTENANCE OF TRAFFIC	LS		1			1		1		530 CONSTRUCTION DAYS	

	SUMMARY OF TEMPORARY TRAFFIC CONTROL PLAN ITEMS													
PAY ITEM	TEM DESCRIPTION		PHASE III			PHASE IV			TOTAL		GRAND TOTAL		DESIGN	CONSTRUCT I ON
NO.	PAY ITEM DESCRIPTION	UNIT	DURAT I ON	QUANT ITY	TOTAL	DURAT I ON	QUANT ITY	TOTAL			TOTAL		DESIGN NOTES	REMARKS
			DAYS	P	P	DAYS	P	P	Р	F	P	F		
0102 1	MAINTENANCE OF TRAFFIC	LS		1			1		1		1		530 CONSTRUCTION DAYS	

					S	UMMARY	OF TE	MPORA	RY SIGN.	ALIZATI	ON & D	ETECTI	ON		
				010	2104					01021	07 1				
PHASE	DURATION	7		RY SIGNA ITERSECT		AINTENANO ACH DAY	A DAY OF INTERSECTION - FACH DAY $A DAY$				DESIGN NOTES	CONSTRUCTION REMARKS			
			EXISTIN	G		TEMPORAF	RY		EXISTING	ĵ	TEM	1PORARY /	'NEW	NOTES	NEMANNS
	DAYS	#	Р	F	#	Р	F	#	Р	F	#	Р	F		
1 THRU 4	530	2	1060		2	1060		2	1060		2	1060			
	l l	UB-TOTAL	1060			1060			1060			1060			
					TOTAL	2120				-	TOTAL	2120			

	JEFFREY SIEWERT, P.E.		SIONS	REVI.	
TRA	P.E. LICENSE NUMBER 39196	DESCRIPTION	DATE	DESCRIPTION	DATE
CITY PROJECT NO	AYRES ASSOCIATES 8875 HIDDEN RIVER PKWY, SUITE 200				
1001221	TAMPA, FL 33637 CERTIFICATE OF AUTHORIZATION 4356				

CITY OF TAMPA TRANSPORTATION DEPARTMENT						
CITY PROJECT NO.	COUNTY	FINANCIAL PROJECT ID				
1001221	HILLSBOROUGH	436639-1-58-01				

SUMMARY OF QUANTITIES

SHEET NO.

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SQ-1

LOCATION		SEDIMENT INLET PROTECTION SYSTEM			CTION	DECTON	CONCTRUCTION
	─ SIDE -	0104	10 3	0104 18		DESIGN NOTES	CONSTRUCTION REMARKS
STA. TO STA.		0104 10 3 LF		EA			
		Р	F	Р	F		
N/A		100				TO BE USED IF REQ.	
104+02.95	RT			1			
104+08.16	RT			1			
104+13.51	RT			1			
104+13.78	LT			1			
104+07.60	LT			1		EVICE INVET	
104+27.55	LT			1		EXIST. INLET	
104+39.38	RT			1		EVICT INLET	
104+40.39 104+66.51	RT LT			1		EXIST. INLET  EXIST. INLET	
104+66.51	LT			1		LAISI, INLEI	
104+76.08	LT			1			
104+82.16	LT			1			
105+17 . 42	LT			1			
105+11.38	RT			1			
105+16.67	RT			1			
105+10.07	RT			1			
106+26.57	RT			1			
106+31.86	RT			1			
106+37 . 16	RT			1			
106+38.59	LT			1			
106+43.89	LT			1			
106+49.18	LT			1			
107+37.55	LT			1			
107+42.84	LT			1			
107+48.14	LT			1			
107+58.70	LT			1		EXIST. INLET	
107+37 . 89	RT			1			
107+43.18	RT			1			
107+48.47	RT			1			
107+68.28	RT			1			
107+74.45	RT			1			
107+77 . 46	RT			1			
107+96.80	LT			1		EXIST. INLET	
107+97 . 15	RT			1		EXIST. INLET	
108+14.06	LT			1			
108+18.06	LT			1			
108+10.10	LT			1			
108+03.94	LT			1			
108+25.09	RT			1		EXIST. INLET	
108+51.20	RT			1			
108+45.91	RT			1			
108+40.62	RT			1			
108+80.94	LT			1			
108+75.64	LT			1			
108+70.35	LT			1			
	SUB-TOTAL:	100		45			

	REVIS	SIONS	
DATE	DESCRIPTION	DATE	DESCRIPTION
		l	
		l	
		l	

THOMAS J. WARD, P.E.
P.E. LICENSE NUMBER 52144
BES, INC.
11007 N. 56TH ST., SUITE 208
TEMPLE TERRACE, FL 33617
CERTIFICATE OF AUTHORIZATION 9835

CITY OF TAMPA
TRANSPORTATION DEPARTMENT

CITY PROJECT NO. COUNTY FINANCIAL PROJECT ID

1001221 HILLSBOROUGH 436639-1-58-01

SUMMARY OF QUANTITIES

SHEET NO. SQ-2 OFFICIAL RECORD OF 1915 SHEEL IS THE ELECTRONIC FILE DIGITAL

SUM	MARY O	F EROS	SION A	ND SEL	DIMENT	CONTROL DEVICE	īS
LOCATION			MENT RIER	INL PROTE SYS	CTION	DESIGN	CONSTRUCTION
	SIDE	0104	10 3	0104	1 18	NOTES	REMARKS
STA. TO STA.		L	F	E	Α		
		Р	F	Р	F		
110+18.72	LT			1			
110+13.43	LT			1			
110+08.14	LT			1			
110+81.51	RT			1			
110+76.22	RT			1			
110+70.93	RT			1			
111+16.82	LT			1		EXIST. INLET	
111+17.68	LT			1			
111+18.49	RT			1			
111+19.64	RT			1		EXIST. INLET	
113+14.61	LT			1			
113+09.32	LT			1			
113+04.03	LT			1			
113+34.16	RT			1			
113+28.87	RT			1			
113+23.58	RT			1			
114+21.64	LT			1			
114+97.29	LT			1			
114+36.66	LT			1			
114+46.96	LT			1		EXIST. INLET	
114+76.09	LT			1		EXIST. INLET	
114+91.12	RT			1			
114+97.29	RT			1			
115+77.20	LT			1			
115+83.37	LT			1			
117+26.06	LT			1			
117+31.35	LT			1			
117+31.55	LT			1			
117+30.04	RT			1			
	RT						+
117+36.19				1			
117+41.48	RT			1			
119+21.70	LT			1			
119+27.07	LT			1		EVICE INVET	
119+29.63	LT			1		EXIST. INLET	
119+32.29	LT			1			
119+29.63	LT			1			
119+16.41	RT			1		EVICE IN ET	
119+44.50	RT			1		EXIST. INLET	
119+44.50	RT			1			
119+87.65	LT			1		EXIST. INLET	
119+87 . 95	LT			1			
119+90.62	LT			1			
120+40.21	LT			1			
120+04.74	LT			1			
120+02.77	RT			1		EXIST. INLET	
120+02.84	RT			1			
120+40.21	RT			1			
9	SUB-TOTAL:			47			

	REVIS	SIONS	
DATE	DESCRIPTION	DATE	DESCRIPTI

THOMAS J. WARD, P.E.
P.E. LICENSE NUMBER 52144
BES, INC.
11007 N. 56TH ST., SUITE 208
TEMPLE TERRACE, FL 33617
CERTIFICATE OF AUTHORIZATION 9835

CITY OF TAMPA
TRANSPORTATION DEPARTMENT

CITY PROJECT NO. COUNTY FINANCIAL PROJECT ID

1001221 HILLSBOROUGH 436639-1-58-01

SUMMARY OF QUANTITIES

SHEET NO. SQ-3

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SU	IMMARY O	F EROS	SION A	AND SEL	DIMEN	T CON	TROL DEVICES	5
LOCATION	SIDE	SEDIMENT INLET PROTECTION SYSTEM		DESIGN	CONST RUCT I ON			
	SIDE	0104	10 3	0104	1 18		NOTES	REMARKS
STA. TO STA.		L	F	E	A	1		
		Р	F	P	F			
120+34.92	RT			1				
120+29.63	RT			1				
120+50.07	LT			1				
121+26 . 13	RT			1				
121+20.84	RT			1				
121+15.55	RT			1				
121+81.75	LT			1				
121+76.46	LT			1				
121+71.17	LT			1				
123+96.35	LT			1		EXIST.	INLET	
124+02.75	RT			1		EXIST.	INLET	
200+29.48	LT			1				
200+30.60	RT			1				
200+40.22	RT			1				
200+40.27	LT			1				
300+28.43	LT			1				
300+30.05	RT			1				
300+36 . 35	LT			1				
400+35.96	RT			1		1		
400+36.66	LT			1				
700+34.87	LT			1				
700+35.07	RT			1				
	SUB-TOTAL:			22				

	REVIS	SIONS		THOMAS J. WARD, P.E.		CIT
DATE	DESCRIPTION	DATE	DESCRIPTION	P.E. LICENSE NUMBER 52144	TRANS	SPORTA
				BES, INC.   11007 N. 56TH ST., SUITE 208	CITY PROJECT NO.	(
				TEMPLE TERRACE, FL 33617 CERTIFICATE OF AUTHORIZATION 9835	1001221	HILL.

CITY OF TAMPA RTATION DEPARTMENT COUNTY FINANCIAL PROJECT ID ILLSBOROUGH 436639-1-58-01

SUMMARY OF QUANTITIES

SHEET NO.

SQ-4

		SUMMARY OF CLEARING	AND	GRUBB	ING & RE	EMOV A	AL ITEM	15		
PAY ITEM NO.	PAY ITEM DESCRIPTION	LOCATION	SIDE	UNITS	QUANT ITY		TOTAL		DESIGN NOTES	CONSTRUCTION REMARKS
		STA. TO STA.			Р	F	Р	F		712777 #11103
110 1 1	CUEADING AND CRUPPING	100+49.41 <sup>TO</sup> 100+95.44	LT	AC	0.007		0.824			
110 1 1	CLEARING AND GRUBBING	100+49.41 TO 100+95.44 101+35.83 TO 104+34.63	LT	AC	0.007		0.024			
		100+76.57 TO 100+90.57	RT		0.043					
		104+30.55 TO 104+62.32	LT		0.002					
		107+61.07 TO 107+92.64	LT		0.007					
		107+92.94 TO 108+38.42	RT		0.014					
		114+41.87 TO 114+81.71	LT		0.007					
		114+94.39 TO 115+30.75	RT		0.008					
		120+00.05 TO 120+12.37	RT		0.006					
		119+56.93 TO 119+89.61	RT		0.007					
		119+42.29 TO 119+76.44	LT		0.007					
		123+55.44 TO 123+93.53	RT		0.010					
		123+31.53 TO 123+43.53	RT		0.009					
		123+58.47 TO 124+00.35	LT		0.010					
		124+10.93 TO 124+36.72	LT		0.009					
		124+34.06 TO 124+47.02	RT		0.010					
		107+88.71 TO 114+51.14	LT		0.099					
		104+58.41 TO 107+64.59	LT		0.057					
		114+72.36 TO 119+48.28	LT		0.077					
		119+83.69 TO 123+55.53	RT		0.041					
		108+21.62 TO 114+99.00	RT		0.097					
		101+38.58 TO 108+00.86	RT		0.097					
		115+26.47 <sup>TO</sup> 119+63.00	RT		0.071					
		119+70.40 TO 123+58.70	LT		0.071					
		115+56.29 TO 115+68.78	RT		0.006					
		101+16.92 TO 101+16.92	RT		0.043					
10 4 10	REMOVAL OF EXISTING CONCRETE	99+85.28 TO 100+95.31	LT	SY	101.1		2950			
		114+74.08 TO 119+45.71	LT		305.5					
		101+38.69 TO 107+99.50	RT		449.2					
		100+76.57 TO 100+98.40	RT		29.1					
		123+93.27 TO 124+01.05	RT		13.6					
		101+33.18 TO 104+33.12	LT		195.4					
		104+59.91 TO 107+64.11	LT		193.2					
		107+92.13 TO 114+49.04	LT		395.3					
		119+85.69 TO 123+55.47	RT		256.1					
		115+28.82 TO 119+61.52	RT		283.5					
		108+23.11 TO 114+97.00	RT		456.3					
		119+71.36 TO 123+58.56	LT		271.5				<u> </u>	

	SUMMARY	OF EA	ARTHWOI	RK	
PAY ITEM NO.			Y F	DESIGN NOTES	CONSTRUCTION REMARKS
0120 1	REGULAR EXCAVATION	500.5			

	REVIS	SIONS		JEFFREY SIEWERT, P.E.		CITY OF TAMPA	1
DATE	DESCRIPTION	DATE	DESCRIPTION	P.E. LICENSE NUMBER 39196	TRAN	SPORTATION DEPA	
				AYRES ASSOCIATES   8875 HIDDEN RIVER PKWY, SUITE 200	CITY PROJECT NO.	COUNTY	FINANCIAL PROJECT ID
				TAMPA, FL 33637 CERTIFICATE OF AUTHORIZATION 4356	1001221	HILLSBOROUGH	436639-1-58-01

	0.77		
SUMMARY	OF	QUANTITIES	

CONSTRUCTION REMARKS	

114+10.35 to 115+57.76	
1327 70 7   MILLING EXIST ASPN PAVT, 4" AVG DEPTH   99+85.30 to 103+60.00   LT/RT   SY   1614.8   8541   104-34.61 to 104-58.41   LT   40.9   105+29.67 to 108+26.40   LT/RT   1014.3   107+64.59 to 107+68.71   LT   30.1   108+01.77 to 108+21.89   RT   35.5   108+33.17 to 114+10.35   LT/RT   2111.2   114.51.03 to 114+72.52   LT   20.3   114+51.03 to 114+72.52   LT   20.3   114+51.03 to 114+72.52   LT   20.3   114+68.46 to 115+27.01   RT   47.3   116+26.25 to 120+12.30   LT/RT   1382.1   119+63.00 to 119+83.00   LT/RT   1382.1   119+63.00 to 119+83.00   LT/RT   1135.2   123+35.43 to 123+31.53   LT/RT   1135.2   123+35.43 to 123+35.01   LT/RT   680.7   19.8   123+35.43 to 123+35.01   LT/RT   143.0   142+21.74 to 124+71.77   LT   143.0   124+21.74 to 124+71.77   LT   LT   LT   LT   LT   LT   LT	
104+34.61 to 104+58.41	
105+29.67 to 108+26.40	
107+64.59 to 107+88.71	
108+00.77 to 108+21.89	
108+33.17 to 114+10.35	
114+51.03 to 114+72.52	
114+98.46 to 115+27.01 RT 47.3  116+26.25 to 120+12.30 LT/RT 1382.1  119+48.28 to 119+70.40 LT 28.9  119+63.00 to 119+83.69 RT 23.3  120+23.98 to 123+31.53 LT/RT 1135.2  123+33.53 to 124+35.01 LT/RT 680.7  123+55.43 to 123+93.62 RT 19.8  123+55.07 to 123+92.23 LT 172.4  124+21.74 to 124+71.77 LT 143.0  124+21.74 to 124+71.77 LT 143.0  124+6.09 to 124+56.89 LT/RT 41.4  334 1 53 PG 76-22 114+10.35 to 115+57.76 LT/RT 7N 45.38 89.9  337 7 83 ASPHALT CONCRETE, TRAFFIC 99+85.30 to 103+60.00 LT/RT 7N 133.22  103+60.00 to 105+29.67 LT/RT 12.25  103+60.00 to 105+29.67 LT/RT 13.32  105+29.67 to 108+26.40 LT/RT 45.38  105+29.67 to 108+26.40 LT/RT 83.67  107+64.59 to 107+88.71 LT 2.49	
116+26.25 to 120+12.30	
119+48.28 to 119+70.40	
119+63.00 to 119+83.69	
120+23.98 to 123+31.53	
123+43.53 to 124+35.01 LT/RT 680.7  123+55.43 to 123+93.62 RT 19.8  123+58.07 to 123+92.23 LT 172.4  124+21.74 to 124+71.77 LT 143.0  124+46.09 to 124+56.89 LT/RT 41.4  334 1 53 SUPERPAVE ASPHALTIC CONCRETE, TRAFFIC C, PG 76-22  114+10.35 to 115+57.76 LT/RT TN 45.38 89.9  114+10.35 to 115+57.76 LT/RT 32.29  115+67.32 to 116+26.34 LT/RT 12.25  337 7 83 ASPHALT CONCRETE FRICTION COURSE, TRAFFIC 99+85.30 to 103+60.00 LT/RT TN 133.22  103+60.00 to 105+29.67 LT/RT 45.38  104+34.61 to 104+58.41 LT 3.38  105+29.67 to 108+26.40 LT/RT 83.67  107+64.59 to 107+88.71 LT 2.49	
123+55.43 to 123+93.62 RT 19.8  123+58.07 to 123+92.23 LT 172.4  124+21.74 to 124+71.77 LT 143.0  124+46.09 to 124+56.89 LT/RT 41.4  334 1 53 SUPERPAVE ASPHALTIC CONCRETE, TRAFFIC C, PG 76-22  114+10.35 to 115+57.76 LT/RT TN 45.38 89.9  115+67.32 to 116+26.34 LT/RT 12.25  337 7 83 ASPHALT CONCRETE FRICTION COURSE, TRAFFIC 99+85.30 to 103+60.00 LT/RT TN 133.22  103+60.00 to 105+29.67 LT/RT 45.38  104+34.61 to 104+58.41 LT 3.38  105+29.67 to 108+26.40 LT/RT 83.67  107+64.59 to 107+88.71 LT 2.49	
123+58.07 to 123+92.23 LT 172.4  124+21.74 to 124+71.77 LT 143.0  124+46.09 to 124+56.89 LT/RT 41.4  1334 1 53 SUPERPAVE ASPHALTIC CONCRETE, TRAFFIC C, PG 76-22  114+10.35 to 115+57.76 LT/RT TN 45.38  114+10.35 to 115+67.32 to 116+26.34 LT/RT 12.25  1337 7 83 ASPHALT CONCRETE FRICTION COURSE, TRAFFIC C, FC-12.5, PG 76-22  103+60.00 to 105+29.67 LT/RT TN 133.22  103+60.00 to 105+29.67 LT/RT 45.38  104+34.61 to 104+58.41 LT 3.38  105+29.67 to 108+26.40 LT/RT 83.67  107+64.59 to 107+88.71 LT 2.49	
124+21.74 to 124+71.77 LT 143.0  124+46.09 to 124+56.89 LT/RT 41.4  1334 1 53 SUPERPAVE ASPHALTIC CONCRETE, TRAFFIC C, PG 76-22  114+10.35 to 115+57.76 LT/RT 32.29  115+67.32 to 116+26.34 LT/RT 12.25  1337 7 83 ASPHALT CONCRETE FRICTION COURSE, TRAFFIC 99+85.30 to 103+60.00 LT/RT TN 133.22  103+60.00 to 105+29.67 LT/RT 45.38  104+34.61 to 104+58.41 LT 3.38  105+29.67 to 108+26.40 LT/RT 83.67  107+64.59 to 107+88.71 LT 2.49	
124+46.09 to 124+56.89	
334 1 53 SUPERPAVE ASPHALTIC CONCRETE, TRAFFIC C, 103+60.00 to 105+29.67 LT/RT TN 45.38 89.9  114+10.35 to 115+57.76 LT/RT 32.29  115+67.32 to 116+26.34 LT/RT 12.25  337 7 83 ASPHALT CONCRETE FRICTION COURSE, TRAFFIC 99+85.30 to 103+60.00 LT/RT TN 133.22 794.4  103+60.00 to 105+29.67 LT/RT 45.38  104+34.61 to 104+58.41 LT 3.38  105+29.67 to 108+26.40 LT/RT 83.67  107+64.59 to 107+88.71 LT 2.49	
114+10.35 to 115+57.76	
114+10.35 to 115+57.76	
115+67.32 to 116+26.34 LT/RT 12.25  337 7 83 ASPHALT CONCRETE FRICTION COURSE, TRAFFIC 99+85.30 to 103+60.00 LT/RT TN 133.22 794.4  103+60.00 to 105+29.67 LT/RT 45.38  104+34.61 to 104+58.41 LT 3.38  105+29.67 to 108+26.40 LT/RT 83.67  107+64.59 to 107+88.71 LT 2.49	
103+60.00 to 105+29.67	
103+60.00 to 105+29.67	
104+34.61 to 104+58.41 LT 3.38 105+29.67 to 108+26.40 LT/RT 83.67 107+64.59 to 107+88.71 LT 2.49	
105+29.67 to 108+26.40 LT/RT 83.67 107+64.59 to 107+88.71 LT 2.49	
107+64.59 to 107+88.71 LT 2.49	
108+33.17 to 114+10.35 LT/RT 174.17	
114+10.35 to 115+57.76	
114+51.03 to 114+72.52 LT 1.67	
114+98.46 to 115+27.01 RT 3.90	
115+67.32 to 116+26.34	
116+26.35 to 120+12.30	
119+48.28 to 119+70.40 LT 2.39	+
119+63.00 to 119+83.69 RT 1.93	+
120+23.98 to 123+31.53	+
123+43.53 to 124+35.01 LT/RT 56.07	+
123+55.43 to 123+93.62 RT 1.63	+
123+58.07 to 123+92.23 LT 14.22	+
124+21.74 to 124+71.77 LT 11.80	+
124+46.09 to 124+56.89	+
350 3 5 PLAIN CEMENT CONCRETE PAVEMENT, 8" 104+30.55 to 104+62.32 LT SY 34.6 566 STAMPED HEXAGONAL PATTERN	
107+61.48 to 107+92.30 LT 35.0	+
107+93.95 to 108+38.42 LT/RT 65.7	+
114+43.57 to 114+81.71 LT 35.4	+
114+94.39 to 115+30.25 RT 38.2	+
115+56.30 to 115+68.78	+
119+42.29 to 119+76.44 LT 34.2	
IPTION DATE DESCRIPTION P.E. LICENSE NUMBER 39196 TRANSPORTATION DEPARTMENT  AVES ASSOCIATES	
8875 HIDDEN RIVER PKWY, SUITE 200 CITY PROJECT NO. COUNTY FINANCIAL PROJECT ID $SUMM_{L}$	
TAMPA, FL 33637	ARY OF QUANTIT
CERTIFICATE OF AUTHORIZATION 4356 1001221 HILLSBOROUGH 436639-1-58-01	ARY OF QUANTIT

SUMMARY OF PAVEMENT

SIDE UNIT

SY

LT/RT

QUANT ITY

550.0

TOTAL

1090

DESIGN NOTES

LOCATION

STA. TO STA.

103+60.00 to 105+29.67

DATE

PAY ITEM NO.

285709

PAY ITEM DESCRIPTION

OPTIONAL BASE, BASE GROUP 09

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SHEET NO. SQ-6

		SUMM	IARY O	F PAVE	MENT					
PAY ITEM		LOCATION		UNIT	QUANTITY		TOTAL		DESIGN	CONSTRUCT I ON
NO.	PAY ITEM DESCRIPTION	STA. TO STA.	SIDE						NOTES	REMARKS
		31A. 10 31A.			Р	F	Р	F		
0350 3 5	PLAIN CEMENT CONCRETE PAVEMENT, 8" (CONT'D)	119+56.93 to 119+89.61	RT	SY	32.4				STAMPED HEXAGONAL PATTERN	
		120+11.98 to 120+24.30	LT/RT		29.3					
		123+31.53 to 123+43.53	LT/RT		42.1					
		123+55.44 to 123+93.53	RT		51.6					
		123+58.47 to 124+01.91	LT		47 . 5					
		124+10.93 to 124+36.72	LT		43.7					
		124+34.06 to 124+47.02	LT/RT		49.1					
0523 1	PATTERNED PAVEMENT , VEHICULAR AREAS	100+84.10 to 101+49.30	LT/RT	SY	209.4		209		BRICK PATTERNED PAVT.	

	REVIS	SIONS		JEFFREY SIEWERT, P.E.		CITY OF TAMPA	
DATE	DESCRIPTION	DATE	DESCRIPTION	P.E. LICENSE NUMBER 39196	TRANS	SPORTATION DEPA	
				AYRES ASSOCIATES			
				8875 HIDDEN RIVER PKWY, SUITE 200	CITY PROJECT NO.	COUNTY	FINANCIAL PROJECT ID
				TAMPA, FL 33637 CERTIFICATE OF AUTHORIZATION 4356	1001221	HILLSBOROUGH	436639-1-58-01
ebarinM				3/13/2020 3:23:23 PM Default			

SUMMARY OF QUANTITIES

SHEET NO. SQ-7

		S	UMMAR	Y OF U	UT I L I T	Y ADJL	ISTMENT	S		
PAY ITEM	PAY ITEM DECORDER ON		CIDE		QUAN	IT I T Y	TO	TAL	DESIGN	CONSTRUCTION
NO.	PAY ITEM DESCRIPTION	LOCATION STATION	SIDE	UNIT	Р	F	P	F	NOTES	REMARKS
		0,,,,,,,,,,,,,,,,,,,,,,,,,,,,,,,,,,,,,,				-	<u> </u>			
0425 5 1	MANHOLE, ADJUST, UTILITIES	101+17	RT	EA	1		11			
		102+38	RT		1					
		105+22	RT		1					
		108+06	RT		1					
		111+04	RT		1					
		114+13	RT		1					
		115+39	RT		1					
		117+59	RT		1					
		119+81	RT		1					
		120+90	RT		1					
		123+83	RT		1					
0425 6	VALVE BOX, ADJUST	100+87	RT	EA	1		17			
		101+25	LT		1					
		101+37	RT		1					
		101+67	RT		1					
		107+70	LT		1					
		108+19	RT		1					
		114+72	LT		1					
		114+81	RT		1				CONTAMINATION MONITORING WELL (WITHIN SWK.)	
		115+63	RT		1					
		119+68	LT		1					
		119+90	RT		1					
		122+52	RT		1				CONTAMINATION MONITORING WELL (WITHIN ROAD)	
		122+83	LT		1				CONTAMINATION MONITORING WELL (WITHIN ROAD)	
		123+22	LT		1				CONTAMINATION MONITORING WELL (WITHIN ROAD)	
		123+60	LT		1					
		123+62	RT		1					
		123+65	RT		1					

	REVIS	SIONS		JEFFREY SIEWERT, P.E.		
DATE	DESCRIPTION	DATE	DESCRIPTION	P.E. LICENSE NUMBER 39196	TRAN	$S_{I}$
				AYRES ASSOCIATES		_
				8875 HIDDEN RIVER PKWY, SUITE 200	CITY PROJECT NO.	Ļ
				TAMPA, FL 33637 CERTIFICATE OF AUTHORIZATION 4356	1001221	

CITY OF TAMPA SPORTATION DEPARTMENT COUNTY FINANCIAL PROJECT ID HILLSBOROUGH 436639-1-58-01

SUMMARY OF QUANTITIES

SHEET NO.

SQ-8

DAY ITEM		LOCATION					TO	TAL	DECION	CONCERNCETON
PAY ITEM NO.	PAY ITEM DESCRIPTION	STA. TO STA.	SIDE	UNIT	NET LI	ENGTH F	P P	T AL	DESIGN NOTES	CONSTRUCTION REMARKS
520 1 10	CONCRETE CURB & GUTTER, TYPE F	99+85.29 TO 100+93.94	LT	LF	128.2	r	<u> </u>			
		100+76.59 TO 100+96.90	RT		40.3					
		101+34.68 TO 104+11.12	LT		293.9					
		101+40.08 TO 104+01.27	RT		281.1					
		104+15.42 TO 104+36.60	RT		21.1					
		104+16.45 TO 104+33.12	LT		35.9					
		104+42.19 TO 105+09.59	RT		67.4					
		104+59.91 TO 104+73.41	LT		32.6					
		104+78.74 TO 105+08.59	LT		29.8					
		105+13.92 TO 107+35.18	LT		223.2					
		105+23.75 TO 106+24.78	RT		101.7					
		106+38.95 TO 107+36.10	RT		97.2					
		107+35.14 TO 107+64.11 107+35.46 TO 107+65.61	LT RT		46 . 1 31 . 7					
		107+70.95 TO 107+99.36	RT		43.3					
		107+90.21 TO 108+07.44	LT		31.9					
		108+20.85 TO 108+83.24	LT		64.3					
		108+23.11 TO 108+53.62	RT		48.0					
		108+52.99 TO 110+69.14	RT		216.3					
		108+82.72 TO 110+06.34	LT		123.7					
		110+20.51 TO 111+14.89	LT		94.4					
		110+83.45 TO 111+15.70	RT		32.3					
		111+20.48 TO 113+02.24	LT		181.8					
		111+21.28 TO 113+21.79	RT		200.6					
		113+16.40 TO 114+19.10	LT		106.1					
		113+36.62 TO 114+98.02	RT		187.0					
		114+24.18 TO 114+49.64	LT		40.4					
		114+73.86 TO 114+88.45	LT		28.4					
		114+93.79 TO 117+24.26	LT		232.5					
		115+27.97 TO 115+74.53 115+79.87 TO 117+29.10	RT RT		67.3 152.0					
		117+38.43 TO 119+17.85	LT		179.4					+
		117+43.26 TO 119+14.23	RT		171.2					
		119+18.56 TO 119+61.50	RT		66.3					
		119+19.55 TO 119+46.78	LT		42.9					
		119+71.91 TO 119+87.82	LT		29.9					
		119+85.19 TO 120+42.57	RT		77.2					
		119+93.41 TO 120+63.30	LT		73.1					
		120+42.00 TO 121+13.75	RT		71.8					
		120+68.89 TO 121+69.38	LT		100.5					
		121+27.92 TO 123+55.53	RT		232.1					
		121+83.55 TO 123+57.20	LT		243.1					
20 2 4	CONCRETE CURB, TYPE D	104+00.97 TO 104+15.19	RT	LF	26.2		353			
		105+09.58 TO 105+23.75	RT		26.9					
		106+24.78 TO 106+38.95	RT		26.8					
		106+36.80 TO 106+50.97	LT		26.8					
		110+06.35 TO 110+20.51	LT		26.8					
		110+69.14 TO 110+83.31	RT		26.8					
		113+02.24 TO 113+16.41	LT		26.8					
		113+21.79 TO 113+36.46 117+24.27 TO 117+38.44	RT LT		26 . 8 26 . 8					
		117+24.27 10 117+38.44 117+29.11 TO 117+43.28	RT		26 . 8 26 . 8					
		117+29.11 10 117+43.28 121+13.76 TO 121+27.92	RT		26.8					
		121+13.70 TO 121+27.92 121+69.38 TO 121+83.54	LT		26.8					
		121+09.30 TO 121+03.34 123+55.43 TO 123+55.53	RT		16.0					
		123+93.77 TO 123+94.06	RT		16.0					

	REVI.	SIONS	
DATE	DESCRIPTION	DATE	DESCRIPTION
		I	i .

JEFFREY SIEWERT, P.E.
P.E. LICENSE NUMBER 39196
AYRES ASSOCIATES
8875 HIDDEN RIVER PKWY, SUITE 200
TAMPA, FL 33637
CERTIFICATE OF AUTHORIZATION 4356

CITY OF TAMPA
TRANSPORTATION DEPARTMENT

CITY PROJECT NO. COUNTY FINANCIAL PROJECT ID

1001221 HILLSBOROUGH 436639-1-58-01

SUMMARY OF QUANTITIES

SHEET NO. SQ-9

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		SUMM	IARY O	F SIDEW	ALK &	DETECTA	BLE WAR	NINGS	
LOCATION	6105	CONC SI 6" (SC PATTI	ORING	CONC SI		DETECT WARNI		DESIGN	CONSTRUCTION
	SIDE	0522	2	0522	2	0527	2	NOTES	REMARKS
CT 4 TO CT 4		5)	/	S	7	SF	7		
STA. TO STA.		Р	F	Р	F	Р	F		
99+85.29 to 100+93.44	LT	95.6							
100+76.57 to 100+96.40	RT	24.7							
101+35.18 to 101+41.35	LT	6.9							
101+40.58 to 101+83.14	RT	60.4							
101+47.47 to 104+32.62	LT	308.9							
102+03.10 to 102+19.14	RT	20.7							
102+39.10 to 103+14.58	RT	65.9							
103+29.32 to 103+45.53	RT	10.7							
103+60.27 to 104+77.57	RT	92.8							
104+60.41 to 106+08.14	LT	165.4							
104+89.56 to 105+45.23	RT	43.6							
105+57.22 to 105+72.89	RT	10.4							
105+84.88 to 106+52.04	RT	53.9							
106+20.13 to 107+63.76	LT	131.3							
106+72.03 to 107+98.86	RT	143.7							
107+90.71 to 109+54.62	LT	186.5							
108+23.62 to 109+08.58	RT	86.7							
109+20.58 to 109+58.49	RT	30.1							
109+66.62 to 110+54.18	LT	74.9							
	RT	62.5							
110+70.49 to 110+45.40									
110+57.40 to 110+94.96	RT	29.4							
110+66.18 to 110+74.18	LT	5.8							
110+86.18 to 111+37.41	LT	40.7							
111+07.14 to 111+33.88	RT	17.6							
111+49.41 to 112+73.66	LT	107.6							
111+53.88 to 112+08.68	RT	43.1							
112+20.68 to 112+28.68	RT	5.8							
112+40.68 to 112+83.09	RT	32.7							
112+85.66 to 113+32.04	LT	38.6							
113+08.09 to 113+49.49	RT	31.1							
113+43.12 to 114+49.14	LT	117.5							
113+61.33 to 113+97.54	RT	37.5							
114+09.36 to 114+18.08	RT	8.0							
114+68.45 to 114+96.65	RT	52.4							
114+74.36 to 115+30.39	LT	73.1							
115+28.59 to 115+93.78	RT	97.9							
115+42.21 to 115+80.40	LT	46.0							
115+92.40 to 116+36.33	LT	54.3							
116+06.91 to 116+60.57	RT	51.0							
116+46.32 to 116+80.52	LT	27.9							
116+72.56 to 117+79.04	RT	85.3							
116+92.51 to 117+73.84	LT	71.0							
117+85.83 to 119+46.33	LT	154.9							
117+91.03 to 118+18.45	RT	19.9							
118+30.44 to 118+58.44	RT	20.2							
118+70.43 to 118+96.21	RT	18.5							
119+08.19 to 119+61.00	RT	74.6							
S	UB-TOTAL	: 3038.0							
	TOTAL	: 3643		1036		241			
				•		<b>'</b>	•		

DATE DESCRIPTION

REVISIONS

DATE

DESCRIPTION

JEFFREY SIEWERT, P.E.
P.E. LICENSE NUMBER 39196
AYRES ASSOCIATES
8875 HIDDEN RIVER PKWY, SUITE 200
TAMPA, FL 33637
CERTIFICATE OF AUTHORIZATION 4356

CITY OF TAMPA
TRANSPORTATION DEPARTMENT

CITY PROJECT NO. COUNTY FINANCIAL PROJECT ID

1001221 HILLSBOROUGH 436639-1-58-01

SUMMARY OF QUANTITIES

SHEET NO.

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		SUMM	IARY O	F SIDEW	ALK &	DETECT	ABLE WA	RNINGS	
LOCATION	6155	CONC SI 6" (SC PATT	ORING	CONC SI			CTABLE NINGS	- DESIGN	CONST RUCT I ON
	SIDE	0522	? 1	0522	? 2	052	7 2	NOTES	REMARKS
		S'	<u> </u>	S'	Y	9	SF		
STA. TO STA.		P	F	P	F	Р	F	1	
119+72.41 to 120+99.80	LT	146.5							
119+85.69 to 121+37.84	RT	145.3							
121+11.80 to 121+97.85	LT	59.5							
121+49.84 to 121+94.75	RT	31.7							
122+06.75 to 122+64.75	RT	39.2							
122+09.85 to 122+51.84	LT	33.4							
122+71.84 to 122+98.53	LT	33.5							
122+76.75 to 123+29.53	RT	36.8							
123+18.53 to 123+56.70	LT	62.1							
123+45.53 to 123+54.91	RT	5.8							
123+50.30 to 123+56.46	LT	11.1							
100+81.87 to 100+93.40	LT			7.3					
100+85.38 to 100+95.91	RT			6.5					
101+35.82 to 101+47.63	LT			8.7					
101+41.48 to 101+52.66	RT			7.1					
101+77.17 to 102+09.18	RT			37.2					
102+13.17 to 102+44.88	RT			37.0					
103+08.19 to 103+35.20	RT			15.6					
103+39.14 to 103+66.16	RT			15.6					
104+25.00 to 104+32.61	LT			7.9					
104+60.41 to 104+67.93	LT			7.8					
104+71.56 to 104+95.56	RT			13.3					
105+39.24 to 105+63.20	RT			12.6					
105+66.88 to 105+90.88	RT			13.8					
106+02.13 to 106+26.81	LT			12.5					
106+46.04 to 106+78.04	RT			19.2					
107+55.67 to 107+63.64	LT			7.9					
107+88.92 to 107+98.86	RT			7.8					
107+90.71 to 107+98.25	LT			7.8					
108+23.35 to 108+41.35	LT			7.3					
108+24.01 to 108+33.43	RT			5.5					
109+02.58 to 109+25.42	RT			13.0					
109+48.62 to 109+72.62	LT			12.6					
109+53.23 to 109+76.49	RT			13.0					
110+39.40 to 110+63.40	RT			13.4					
110+39.40 to 110+63.40 110+48.18 to 110+70.21	LT			12.6					
110+70.21 to 110+92.18	LT			12.6					
110+70.21 to 110+92.18 110+88.96 to 111+13.14	RT			13.2					
110+88.96 to 111+13.14 111+27.88 to 111+59.88	RT			20.8					
111+27.88 to 111+39.88 111+31.41 to 111+55.41	LT			13.3					
111+31.41 to 111+33.41 112+02.68 to 112+24.69	RT			12.7					
	RT						+		
112+24.68 to 112+46.68	LT			12.8					
112+67.66 to 112+91.66				12.7					
112+77.09 to 113+14.09	RT			24.2					
113+26.04 to 113+49.43	LT			12.9					
113+43.24 to 113+67.22	RT			12.4					
113+91.09 to 114+13.98	RT			20.3					
114+13.98 to 114+74.43	RT			63.3					
	SUB - TOT A	: 604.9		554.2					

DATE	DESCRIPTION

JEFFREY SIEWERT, P.E.
P.E. LICENSE NUMBER 39196
AYRES ASSOCIATES
8875 HIDDEN RIVER PKWY, SUITE 200
TAMPA, FL 33637
CERTIFICATE OF AUTHORIZATION 4356

TRAN	CITY OF TAMPA SPORTATION DEPA	
CITY PROJECT NO.	COUNTY	FINANCIAL PROJECT ID
1001221	HILLSBOROUGH	436639-1-58-01

SUMMARY OF QUANTITIES

SHEET NO.

DESCRIPTION

REVISIONS DATE

		SUMI	MARY O	F SIDEW	ALK &	DETECT,	ABLE WAR	NINGS	
LOCATION	SIDE	6" (SO	DEWALK CORING ERN)	CONC SI	"	DETEC WARN	INGS	DESIGN	CONSTRUCTION
	JOE		2 1	0522			7 2	NOTES	REMARKS
STA. TO STA.		P	Y F	SY P	F F	S 	F F		
114+38.60 to 114+49.14	LT			7.4					
114+74.40 to 114+84.95	LT			7.6					
114+81.51 to 114+97.00	RT			11.3					
114+88.48 to 114+96.56	RT			8.0					
115+24.03 to 115+48.05	LT			24.0					
115+28.46 to 115+36.38	RT			7.6					
115+52.04 to 115+70.04	LT			8.2					
115+54.04 to 115+72.03	RT			7.5					
115+74.03 to 115+98.89	LT			23.2					
115+88.34 to 116+12.94	RT			25.9					
116+30.34 to 116+52.34	LT			12.0					
116+54.55 to 116+78.55	RT			12.6					
116+74.53 to 116+98.53	LT			13.6					
117+67.84 to 117+91.85	LT			14.7					
117+73.04 to 117+97.04	RT			13.0					
118+12.45 to 118+36.45	RT			13.0					
118+52.44 to 118+76.44	RT			13.0					
118+90.22 to 119+18.91	RT			13.8					
119+37.42 to 119+46.29	LT			7.1					
119+52.11 to 119+61.00	RT			7.7					
119+72.25 to 119+81.24	LT			7.0					
119+85.69 to 119+94.37	RT			7.7					
120+09.02 to 120+26.92	RT			7.3					
120+09.71 to 120+27.24	LT			7.2					
120+93.80 to 121+17.80 121+31.84 to 121+55.84	LT RT			12.0 12.0					
121+88.75 to 122+12.75	RT			12.0					
121+91.85 to 122+15.85	LT			12.0					
122+45.82 to 122+77.84	LT			33.1					
122+58.75 to 122+82.75	RT			12.0					
122+92.53 to 123+24.53	LT			33.1					
123+28.53 to 123+45.50	LT			8.7					
123+29.53 to 123+45.53	RT			12.3					
123+48.56 to 123+55.43	RT			11.7					
123+50.18 to 123+56.60	LT			11.1					
123+50.33 to 123+56.34	LT			5.6					
123+93.77 to 124+01.05	RT			12.7					
123+93.77 to 124+01.05	RT			12.7					
100+87.10 to 100+91.08	LT					7.4			
100+89.27 to 100+93.55	RT					8.0			
101+36.53 to 101+41.47	LT					9.0			
101+41.47 to 101+43.60	LT					10.6			
101+43.40 to 101+47.40	RT					7.4			
101+43.40 to 101+47.40	RT					7.4			
104+29.00 to 104+31.00	LT					8.0			
104+61.93 to 104+63.93	LT					8.0			
107+59.67 to 107+61.80	LT					8.0			
107+92.25 to 107+94.25	LT					8.0			
	SUB-TOTA	4 :		481.4		81.8			

	REVIS	SIONS
DATE	DESCRIPTION	DATE

JEFFREY SIEWERT, P.E.
P.E. LICENSE NUMBER 39196
AYRES ASSOCIATES
8875 HIDDEN RIVER PKWY, SUITE 200
TAMPA, FL 33637
CERTIFICATE OF AUTHORIZATION 4356

DESCRIPTION

CITY OF TAMPA TRANSPORTATION DEPARTMENT CITY PROJECT NO. FINANCIAL PROJECT ID COUNTY 1001221 HILLSBOROUGH 436639-1-58-01

SHEET NO. SQ-12

SUMMARY OF QUANTITIES

SUMMARY OF SIDEWALK & DETECTABLE WARNINGS									
LOCATION		CONC SI 6" (SC PATT	CORING	ING CONC SIDEWALK		DETECTABLE WARNINGS		DESIGN	CONSTRUCTION
	SIDE	0522	2 1	0522	2 2	0527	2	NOTES	REMARKS
STA. TO STA.		5	Υ	S	Υ	SF			
31A. 10 31A.		P	F	P	F	Р	F		
107+92.92 to 107+95.15	RT					8.0			
108+26.12 to 108+30.05	RT					7.0			
108+30.34 to 108+34.34	LT					8.0			
114+42.61 to 114+44.61	LT					8.0			
114+78.93 to 114+80.94	LT					8.0			
114+92.89 to 114+95.09	RT					8.0			
115+30.34 to 115+32.38	RT					8.0			
115+59.04 to 115+63.07	LT					8.0			
115+61.03 to 115+65.03	RT					8.0			
119+41.42 to 119+43.46	LT					8.0			
119+56.11 to 119+58.18	RT					8.0			
119+75.19 to 119+77.24	LT					8.0			
119+88.30 to 119+90.37	RT					8.0			
120+15.84 to 120+19.85	RT					8.0			
120+16.41 to 120+20.41	LT					8.0			
123+35.53 to 123+39.53	LT					8.0			
123+35.53 to 123+39.53	RT					8.0			
123+52.97 to 123+54.99	RT					8.0			
123+54.47 to 123+56.51	LT					8.0			
123+93.88 to 123+95.99	RT					8.1			
								<u> </u>	
S	SUB-TOTA	4:				159.1			

	REVIS	SIONS		JEFFREY SIEWERT, P.E.
DATE	DESCRIPTION	DATE	DESCRIPTION	P.E. LICENSE NUMBER 39196
				AYRES ASSOCIATES 8875 HIDDEN RIVER PKWY, SUITE 200 TAMPA, FL 33637 CERTIFICATE OF AUTHORIZATION 4356

CITY OF TAMPA
TRANSPORTATION DEPARTMENT

CITY PROJECT NO. COUNTY FINANCIAL PROJECT ID

1001221 HILLSBOROUGH 436639-1-58-01

SUMMARY OF QUANTITIES

SHEET NO. THE OFFICIAL RECORD OF THIS SHEET IS THE ELECTRONIC FILE DIGITALL

# STATE OF FLORIDA CITY OF TAMPA

# WALK-BIKE LAP PROJECT


### INDEX OF SIGNING AND PAVEMENT MARKING PLANS

S-9 - S-10

SHEET NO. SHEET DESCRIPTION S-1 KEY SHEET TABULATION OF QUANTITIES *S-2 S-3* GENERAL NOTES PLAN SHEETS S-4 - S-8

HISTORIC SIGN DETAILS

CITY PROJECT NO. 1001221 FINANCIAL PROJECT ID 436639-1-58-01 (FEDERAL FUNDS) HILLSBOROUGH COUNTY E COLUMBUS DR FROM N NEBRASKA AVE (SR45) TO 14TH ST

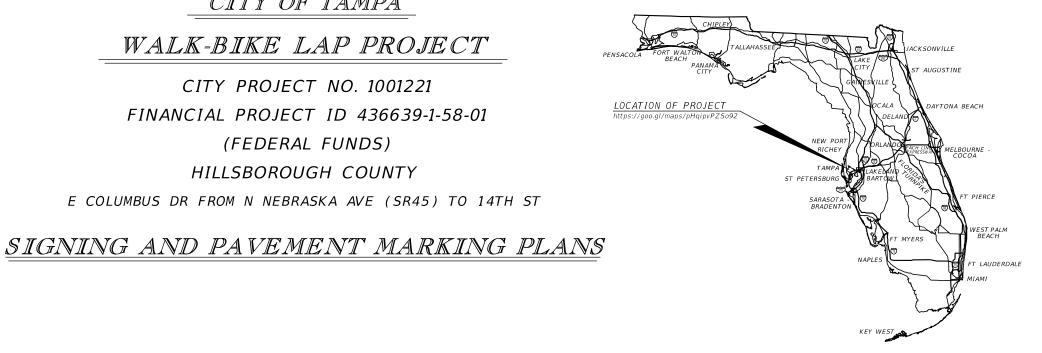



THIS ITEM HAS BEEN DIGITALLY SIGNED AND SEALED BY

### Jeffrey J Siewert 2020.05.20 16:18:30 -04'00'

ON THE DATE ADJACENT TO THE SEAL

PRINTED COPIES OF THIS DOCUMENT ARE NOT CONSIDERED SIGNED AND SEALED AND THE SIGNATURE MUST BE VERIFIED ON ANY ELECTRONIC COPIES.

### SIGNING AND PAVEMENT MARKING PLANS ENGINEER OF RECORD:

JEFFREY SIEWERT, P.E. P.E. LICENSE NUMBER 39196 AYRES ASSOCIATES 8875 HIDDEN RIVER PKWY, SUITE 200 TAMPA, FL 33637 (813) 978-8688 CERTIFICATE OF AUTHORIZATION 4356

CONSTRUCTION PLANS MARCH 2020

FDOT PROJECT MANAGER:

NINA MABILLEAU, E.I.

FISCAL	SHEET
YEAR	NO.
21	S-1

### TABULATION OF QUANTITIES

PAY ITEM	DECCRIPTION	11017					SI	HEET I	IUMBEF	RS			TOTAL THIS	GRA TOI	
NO.	DESCRIPTION	UNIT	S	- 4	S -	5 S	- 6	5	- 7	S - 8			SHEET	101	AL
<i>1</i> <b>.</b> .			PLAN	FINAL	PLAN	FINAL PLAN	FINAL	PLAN	FINAL	PLAN FINAL	PLAN FINAL	PLAN FINAL	PLAN FINAL	PLAN	FINAL
0700 1 11	SINGLE POST SIGN, F&I GROUND MOUNT, UP TO 12 SF	AS	3	3	1	í		3		7			15	15	
0700 1 12	SINGLE POST SIGN, F&I GROUND MOUNT, UP TO 12-20 SF	AS						1		3			4	4	
0700 1 11** (HISTORIC SIGNS)	SINGLE POST SIGN, F&I GROUND MOUNT, UP TO 12 SF	AS								1			1	1	
0700 1 12** (HISTORIC SIGNS)	SINGLE POST SIGN, F&I GROUND MOUNT, 12-20 SF	AS		1	2	2	,	1					6	6	
0700 1 60	SINGLE POST SIGN, REMOVE	AS		1	4	7	,	4		10			26	26	
700 3 501	SIGN PANEL, RELOCATE, UP TO 12 SF	EA		1	-					70			1	1	
700 3 301	SIGN PANEL, RELOCATE, UP TO 12 SF	EA	<u> </u>	1									1	1	
0710 90	PAINTED PAVEMENT MARKINGS, FINAL SURFACE	LS/LS											1	1	
*	RETRO-REFLECTIVE PAVEMENT MARKERS	EA	22	2	1					12			35	35	
*	PAINTED PM, STD, WHITE, SOLID, 6"	GM	0.215	5	0.231	0.217		0.234		0.126			1.023	1.023	
*	PAINT, STD., WHITE, SOLID, DIAG./CHEVRON, 18"	LF	77.3	3				26.8		115.8			219.9	220	
*	PAINT, WHITE, SOLID, STOP LINES/CROSSWALK, 24"	LF	52.0	)	22.0	10.7	,	21.5		122.4			228.6	229	
*	PAINT, STD., WHITE, GUIDE LINE, 6" (2/4)	GM	0.029	9						0.024			0.053	0.053	
*	PAINT, STD., MESSAGE OR SYMBOL (ONLY)	EA								1			1	1	
*	PAINT, STD., ARROWS	EA	2	2						4			6	6	
*	PAINTED PM, STD, YELLOW, SOLID, 6"	GM	0.136	5	0.188	0.169		0.210		0.063			0.766	0.766	
*	PAINT, STD., YELLOW, SOLID, DIAG/CHEVRONS, 18"	LF								14.7			14.7	15	
0711 11124	THERMOPLASTIC, STANDARD, WHITE, SOLID, 18" FOR DIAGONALS AND CHEVRONS	LF	77.3	3				26.8		115.8			219.9	220	
0711 11125	THERMOPLASTIC, STANDARD, WHITE, SOLID, 24" FOR STOP LINE AND CROSSWALK	LF	52.0		22.0	10.7		21.5		122.4			228.6	229	
0711 11141	THERMOPLASTIC, STANDARD, WHITE, 2-4 DOTTED GUIDELINE/6-10 GAP EXTENSION, 6"	GM	0.029	<del>)</del>						0.024			0.053	0.053	
0711 11160	THERMOPLASTIC, STANDARD, WHITE, MESSAGE OR SYMBOL	EA								1			1	1	
0711 11170	THERMOPLASTIC, STANDARD, WHITE, ARROW	EA	2	2						4			6	6	
0711 11224	THERMOPLASTIC, STANDARD, YELLOW, SOLID, 18" FOR DIAGONAL OR CHEVRON	LF								14.7			14.7	15	
0711 14123	THERMOPLASTIC, PREFORMED, WHITE, SOLID, 12" FOR CROSSWALK	LF	287.€		149.1	165.4	+	151.1		352.5			1105.8	1106	
0711 14125	THERMOPLASTIC, PREFORMED, WHITE, SOLID, 24" FOR CROSSWALK	LF	264.0		99.0	96.0		99.0		253.0			811.0	811	
0711 14160	THERMOPLASTIC, PREFORMED, WHITE MESSAGE	EA	5		4	5		5		3			22	22	
0711 16101	THERMOPLASTIC, STANDARD-OTHER SURFACES, WHITE, SOLID, 6"	GM	0.215		0.231	0.217	-	0.234		0.126			1.023	1.023	
0711 16201	THERMOPLASTIC, STANDARD-OTHER SURFACES, YELLOW, SOLID, 6"	GM	0.136	5	0.188	0.169		0.210		0.063			0.765	0.765	

\* THESE QUANTITIES ARE PAID FOR UNDER PAINTED PAVEMENT MARKINGS (FINAL SURFACE), LUMP SUM - ITEM NO. 710-90. THE QUANTITIES SHOWN ARE FOR ONE APPLICATION; SEE SPECIFICATION 710 FOR THE NUMBER OF APPLICATIONS REQUIRED.

#### PAY ITEM NOTES:

0700-1-11 - SIGN POSTS TO BE ALUMINUM POSTS. POSTS AND BACK OF TRAFFIC SIGN PANELS TO BE PAINTED WITH BLACK VINYL PAINT.

0700-1-12 - SIGN POSTS TO BE ALUMINUM POSTS. POSTS AND BACK OF TRAFFIC SIGN PANELS TO BE PAINTED WITH BLACK VINYL PAINT.

0700-1-11\*\* - COST OF HISTORIC SIGN ASSEMBLIES INCLUDES NEW DECORATIVE POST, NEW STREET NAME SIGNS AND NEW TRAFFIC SIGN PANELS. BACK OF TRAFFIC SIGN PANELS TO BE PAINTED WITH BLACK VINYL PAINT.

0700-1-12\*\* - COST OF HISTORIC SIGN ASSEMBLIES INCLUDES NEW DECORATIVE POST, NEW STREET NAME SIGNS AND NEW TRAFFIC SIGN PANELS. BACK OF TRAFFIC SIGN PANELS TO BE PAINTED WITH BLACK VINYL PAINT.

0700-3-501 - SIGN PANEL TO B PAINTED WITH BLACK VINYL PAINT.

	REVIS	SIONS		JEFFREY SIEWERT, P.E.
DATE	DESCRIPTION	DATE	DESCRIPTION	P.E. LICENSE NUMBER 39196
				AYRES ASSOCIATES 8875 HIDDEN RIVER PKWY, SUITE 200
				TAMPA, FL 33637
				CERTIFICATE OF AUTHORIZATION 4356

CITY OF TAMPA TRANSPORTATION DEPARTMENT						
CITY PROJECT NO.	COUNTY	FINANCIAL PROJECT ID				
1001221	HILLSBOROUGH	436639-1-58-01				

TAB ULA TION OF QUANTITIES SHEET NO. S-2

- 2. FOR RETRO-REFLECTIVE PAVEMENT MARKER PLACEMENT DETAILS, REFER TO FDOT STANDARD PLANS 706-001.
- 3. ALL CROSSWALKS ARE 10' WIDE AND WILL BE STRIPED USING SPECIAL EMPHASIS 12" AND 24" PREFORMED THERMOPLASTIC.

RPM LEGEND
BDWR = BI-DIRECTIONAL WHITE/RED
BDY = BI-DIRECTIONAL YELLOW

- 4. ALL EXISTING SIGNS ARE TO REMAIN UNLESS OTHERWISE NOTED IN THE PLANS. EXISTING SIGNS SHOWN FOR INFORMATION ONLY.
- ALL CALLOUTS ARE TO CENTERLINE OF CONSTRUCTION OF COLUMBUS AVENUE, UNLESS NOTED OTHERWISE.
- 6. ALL PARKING SPACES TO BE 6.5 FT FROM EDGE OF PAVEMENT.

#### HISTORIC SIGNS GENERAL NOTES

- THESE DRAWINGS ARE DIAGRAMMATIC ONLY AND INDICATE AESTHETICS OF DESIGN INTENT ONLY. DETAILS ARE INTENDED AS A GUIDE FOR THE INTERFACING OF ADJACENT SURFACES. THE FABRICATION CONTRACT IS RESPONSIBLE FOR ALL STRUCTURAL, FASTENING AND ENGINEERING OF SIGNS AND FOUNDATIONS.
- PROVIDE SCALED, SIGNED AND SEALED STRUCTURAL ENGINEERING DRAWINGS FOR ALL SIGNS AND FOUNDATIONS.
- 3. PROVIDE ALL LABOR, MATERIALS, EQUIPMENT, SUPERVISION, PERMITS, LICENSES AND INSURANCE NECESSARY TO FURNISH AND INSTALL ALL SIGNS.
- 4. PROVIDE COORDINATION OF ALL SUBMITTALS, CORRESPONDENCE, PROJECT DOCUMENTATION AND COMMUNICATION.
- ALL MATERIALS SHALL BE OF TOP QUALITY WORKMANSHIP AND TECHNIQUES, AND BE FREE OF DEFECTS. DEFECTIVE IS DEFINED TO INCLUDE LAMINATION FAILURES, ABNORMAL DETERIORATION, FADING AND DISCOLORATION, WEATHERING, FAILURE OF SECURING TO SUBSTRATES INDICATED, CRACKING, CORROSION OR COATING DAMAGE, OR VISIBLE SCRATCHES ON SURFACES.
- 6. SIGNAGE SHALL NOT BEAR MANUFACTURER'S CODE OR OTHER IDENTIFYING MARKS ON ANY AREA OR PART WHICH MAY BE VISIBLE IN THE NORMAL POSITIONING, ATTITUDE, OR USE OF THE SIGN.
- 7. THE DRAWINGS ARE DIAGRAMMATIC AND INDICATE THE AESTHETIC OF "DESIGN INTENT" ONLY. DETAILS SHOWN ARE INTENDED AS A GUIDE FOR THE INTERFACING OF ADJACENT SURFACES.
- 8. THE SPECIFICATION MAKES NO ATTEMPT TO CONSIDER ALL CONSTRUCTION REQUIREMENTS THAT MAY APPLY. THE CONTRACTOR SHALL FIELD VERIFY THE MEASUREMENTS, SITE CONDITIONS OF ANY EXISTING STRUCTURES.
- 9. THE CITY RESERVES THE RIGHT TO VISIT THE PLANT WHERE FABRICATION WILL OCCUR. THE CONTRACTOR SHALL SUBMIT PROOF OF PREVIOUS PROJECTS TO ILLUSTRATE MANUFACTURING CAPABILITIES.
- SHOP DRAWINGS SHALL SHOW ALL DIMENSIONS, DETAILS OF CONSTRUCTION, MATERIALS, TECHNICAL DATA AND INSTALLATION INSTRUCTIONS FOR EACH TYPE OF SIGN REQUIRED. SHOW ANCHORAGES AND ACCESSORY ITEMS.
- 11. SIGN SAMPLES AND LAYOUTS.
  - . SUBMIT PROOFS OF ART WORK AND SYMBOLS OF ACTUAL PAINTED ALUMINUM FINISHES FOR EACH COLOR SPECIFIED.
  - 2. SUBMIT PROTOTYPE SAMPLES AND COLOR MATCH SAMPLES.
  - 3. SUBMIT COMPLETE ALPHABET, NUMERALS, PUNCTUATION, AND GRAPHICS FOR REVIEW PRIOR TO START OF FABRICATION.

    IF MORE THAN ONE SUP-PLIER'S CUT WILL BE USED, SUBMIT EACH CUT FOR DEVIEW.
  - SUBMIT SCALED TEXT LAYOUTS FOR EACH SIGN FACE FOR APPROVAL OF FORMAT, SPACING AND COPY.
- 12. SUBMIT FABRICATION SCHEDULE.
- 13. PROVIDE WRITTEN CERTIFICATION THAT ALL REQUIRED PERMITS, VARIANCES AND APPROVALS FROM AGENCIES HAVING JURISDICTION HAVE BEEN SECURED.
- 4. THE SIGN CONTRACTORS ACCEPTS RESPONSIBILITY TO REVIEW THE SITE AND CONDITIONS AND WILL FIELD VERIFY EACH SIGN LOCATION.

#### HISTORIC SIGNS GENERAL NOTES- (CONT'D)

- 15. PROVIDE A WRITTEN WARRANTY FOR ONE YEAR FOR ELECTRICAL COMPONENTS EXCEPT LAMPS, AND A SEVEN-YEAR MINIMUM WARRANTY ON THE SIGN CONSTRUCTION, STRUCTURES, PAINTS AND FINISHES.
- 16. PROVIDE A WRITTEN MAINTENANCE CONTRACT WHICH, IF ACCEPTED, SHALL BECOME EFFECTIVE ON THE EXPIRATION DATE OF WRITTEN WARRANTY.
- 17. ALL EDGES OF LETTER FORMS SHALL BE SHARP AND CLEAN WITH NO EDGE BUILD-UP OR BLEEDING. ALL SURFACES OF LETTER FORMS SHALL BE WITHOUT PINHOLES OR DEFECTS.
- 18. ALL UNITS SHALL BE ADEQUATELY VENTED TO DISSIPATE HEAT AND SHALL BE PROPERLY VENTED AND DRAINED TO PREVENT WATER CONTAINMENT. ALL UNIT OPENINGS SHALL BE BACKED WITH A NON-FERROUS FINE SCREEN MESH AND SHALL NOT DIRECTLY INLET WATER CONDENSATION OR CONTAMINANTS.
- 19. ALL UNITS SHALL BE CONSTRUCTED OF VANDAL-RESISTANT CONSTRUCT ION MATERIALS, METHODS AND EQUIPMENT. ALL COMPONENTS SHALL BE PROPERLY INSULATED TO PREVENT CORROSION BETWEEN ALUMINUM, STEEL, AND NON-ALUMINUM METALLIC SURFACES. ALL COMPONENTS SHALL BE NON-FERROUS AND SHALL BE RUSTPROOF. ALL JOINTS AND SEAMS SHALL BE SEALED AND WEATHER PROOFED.
- FASTENERS SHALL BE STAINLESS STEEL, NON-CORROSIVE TYPE FASTENERS
  AND SHALL BE NON-CONDUCTIVE OR INSULATED WHEN JOINING NON-COMPATIBLE
  MATERIALS. VANDAL-RESISTANT FASTENERS SHALL BE USED WHENEVER
  POSSIBLE.
- 21. PAINTS: THE BACK OF ALL SIGNS, POSTS AND ENTIRE OVERHEAD SIGN STRUCTURES SHALL BE PAINTED BLACK. WORKMANSHIP IN CONNECTION WITH PAINT AND FINISHES SHALL CONFORM TO THE HIGHEST STANDARDS OF THE TRADE. PAINTS SHALL BE EVENLY APPLIED WITHOUT PINHOLES, SCRATCHES, PEELING, APPLICATION MARKS, DUST PARTICLES, ETC. NO PAINT THAT WILL FADE, DISCOLOR OR DELAMINATE AS A RESULT OF PROXIMITY TO AN ULTRAVIOLET LIGHT SOURCE OR HEAT SHALL BE USED. THE COST OF PRIMING ALL SURFACES (PRETREATMENT) SHALL BE INCLUDED IN THE WORK AS PART OF THE FINISHED SURFACE WORK. THE PAINT AND PRE-TREATMENTS SHALL BE APPLIED AS PER MANUFACTURERS WRITTEN INSTRUCTIONS AND SPECIFICATIONS. THE PAINT SHALL BE PORTER PAINT, GLIDEX 4100 SERIES OR EQUIVALENT.
- 22. INSPECT EXISTING CONDITIONS OF THE PROJECT, INCLUDING ELEMENTS SUBJECT TO DAMAGE OR TO MOVEMENT DURING CUTTING AND PATCHING. AFTER UNCOVERING WORK, INSPECT THE CONDITIONS AFFECTING THE INSTALLATION OF PRODUCTS OR PERFORMANCE OF THE WORK. REPORT UNSATISFACTORY OR QUESTIONABLE CONDITIONS IN WRITING; DO NOT PROCEED WITH THE WORK UNTIL THE CITY AND/OR THEIR APPOINTED REPRESENTATIVE HAS PROVIDED FURTHER INSTRUCTIONS.

- 23. ALL SIGNS SHOULD HAVE A CITY OF TAMPA DECAL (PROVIDED BY THE CITY) WITH DATE INSTALLED AFFIXED TO THE BACK OF THE SIGN IN THE BOTTOM RIGHT CORNER.
- 24. UTILITY CLEARANCE SHALL BE REQUIRED FOR ALL SIGN INSTALLATIONS INCLUDING EXISTING SIGN LOCATION. THE AWARDEE SHALL SECURE SAID UTILITY CLEARANCE.
- 25. ALL MATERIALS SHALL MEET FLORIDA DEPARTMENT OF TRANSPORTATION (FDOT) SPECIFICATIONS UNLESS APPROVED BY THE CITY OF TAMPA. SAID APPROVAL SHALL BE IN WRITING.
- 26. REPLACE STREET NAME SIGNS AS SHOWN ON THE SIGNING AND PAVEMENT MARKING PLANS AND THE HISTORIC SIGN DETAIL SHEETS, USING THE HISTORIC SIGNS TABLE BELOW.

	HISTOR	RIC SIGNS TABLE	
STA	OFFSET	SIGN ASSEMBLY NAME	SIGN TYPE
37 A	OFFSET	SIGN ASSEMBLI NAME	
104+25	39' LT	Columbus Dr	Α
		9th St	Α
107+56	39' LT	Columbus Dr	Α
		10th St	А
108+28	29' RT	Columbus Dr	Α
		10th St	А
114+43	29' LT	Columbus Dr	А
		12th St	Α
115+30	30' RT	Columbus Dr	А
		12th St	Α
119+91	34' RT	Columbus Dr	Α
		13th St	А
123+47	30' RT	Columbus Dr	А
		14th St/Republica de Cuba	В

LETTER STYLE: CAXTON BOLD

ABCDEFGHIJKLMNOPQR abcdefghijklmn 1234567890

LETTER STYLE: CHARLEMAGNE BOLD
ABCDEFGHIJKLMNOPQR
1234567890

LETTERSTYLE CVERHEAD SIGNS:

"E-MOD" per FDOT Standard

	REV I.	SIONS		JEFFREY SIEWERT, P.E.		CITY (
DATE	DESCRIPTION	DATE	DESCRIPTION	P.E. LICENSE NUMBER 39196	TRAN	SPORTATI
				AYRES ASSOCIATES 8875 HIDDEN RIVER PKWY, SUITE 200	CITY PROJECT NO.	COU
				TAMPA, FL 33637 CERTIFICATE OF AUTHORIZATION 4356	1001221	HILLSBO

CITY OF TAMPA TRANSPORTATION DEPARTMENT						
CITY PROJECT NO.	COUNTY	FINANCIAL PROJECT ID				
1001221	HILLSBOROUGH	436639-1-58-01				

GENERAL NOTES


SHEET NO.


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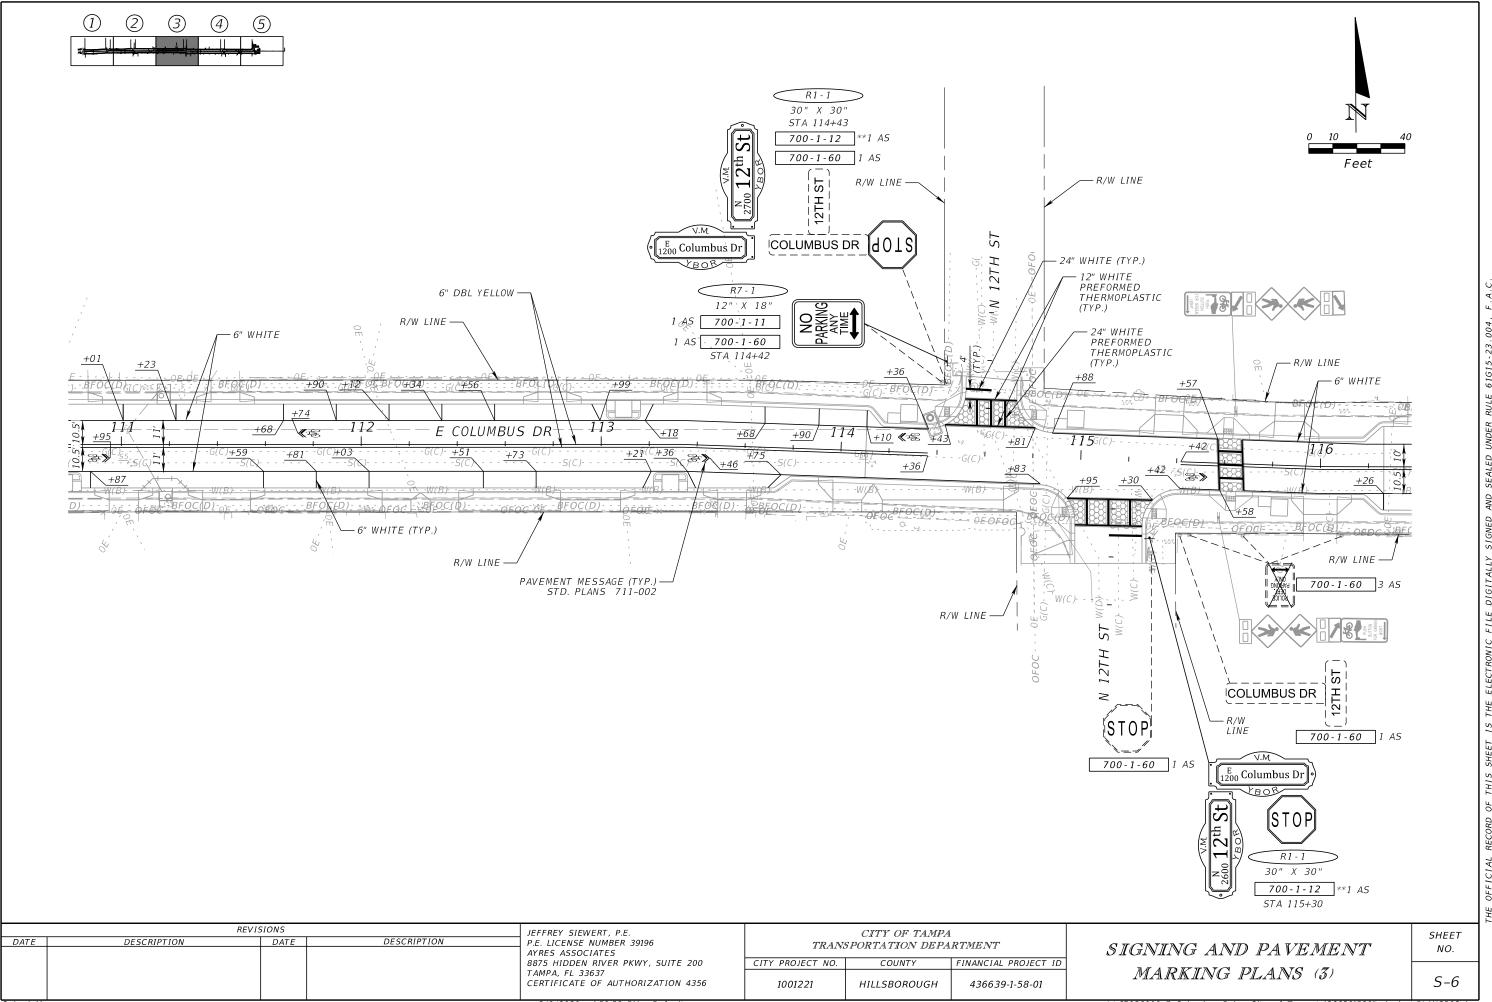
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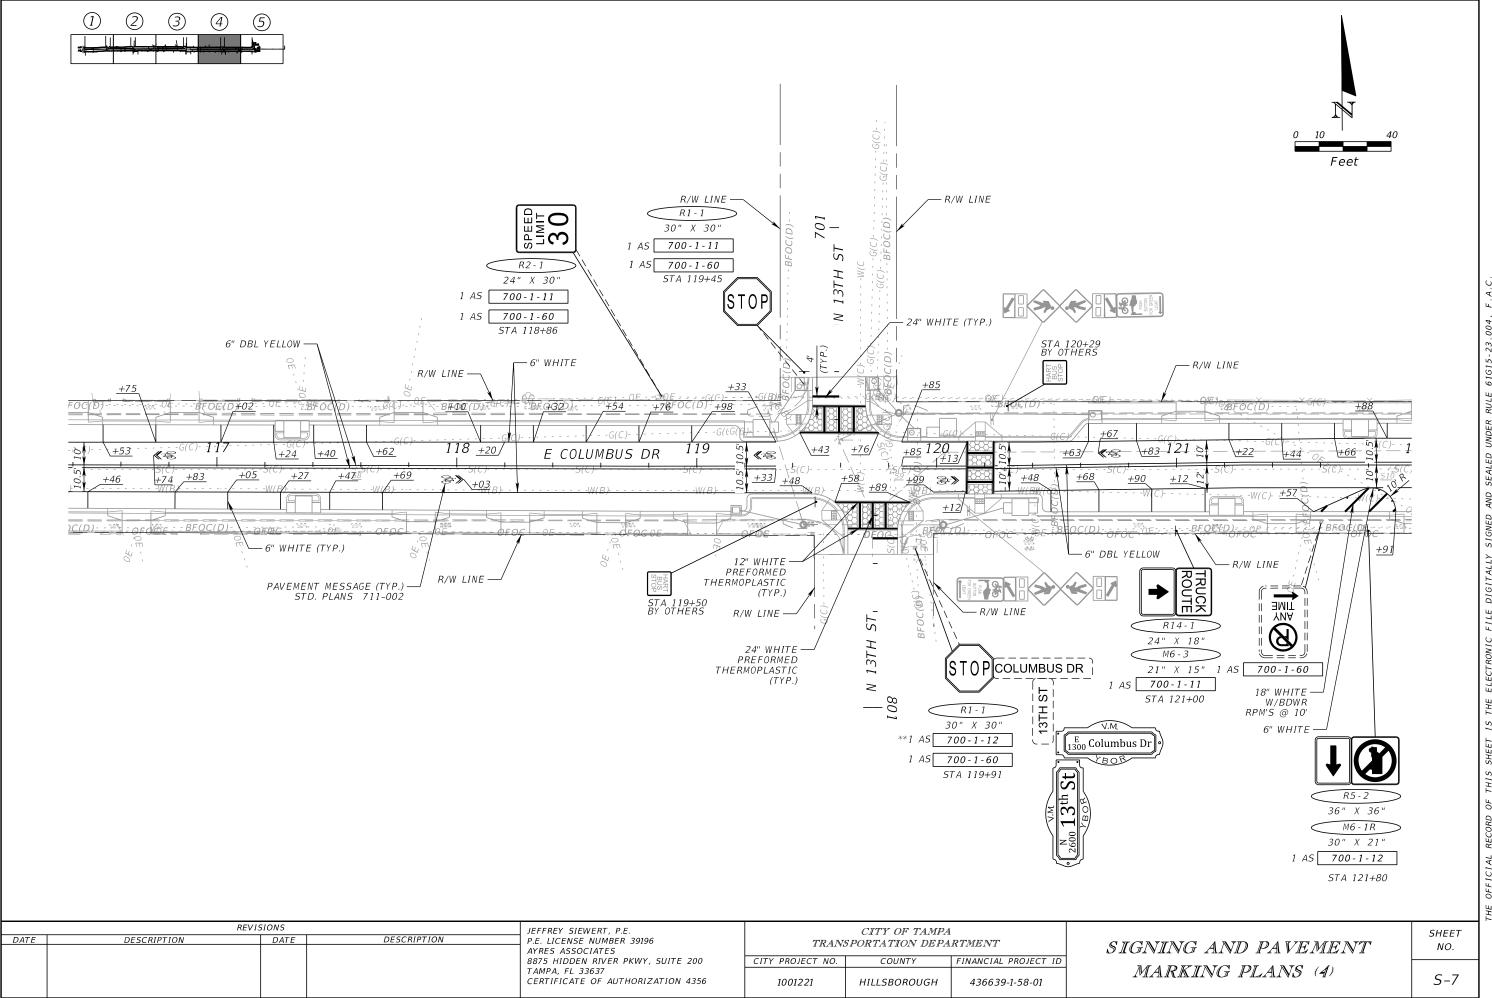






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NOTE

REFER TO LATEST MANUAL ON UNIFORM TRAFFIC CONTROL DEVICES FOR STREETS AND HIGHWAYS, 2009 EDITION, INCLUDING REVISION 1, DATED MAY 2012 AND REVISION 2, DATED MAY 2012 FOR MAINTAINING MINIMUM RETROREFLECTIVITY.

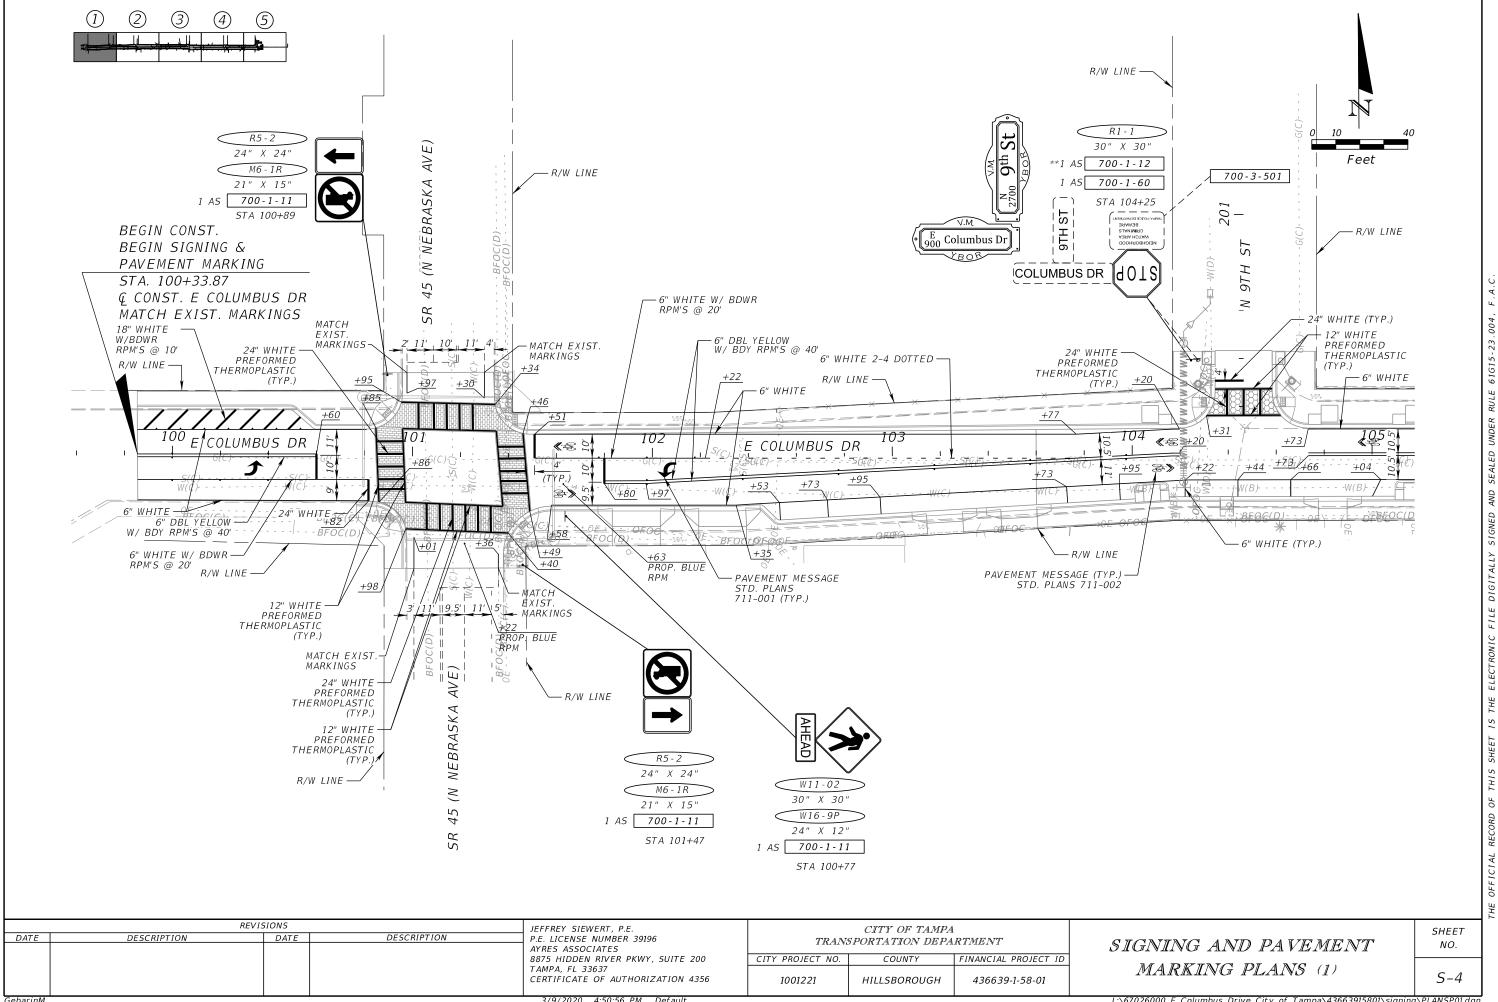	REVIS	SIONS		JEFFREY SIEWERT, P.E.
DATE	DESCRIPTION	DATE	DESCRIPTION	P.E. LICENSE NUMBER 39196
				AYRES ASSOCIATES
				8875 HIDDEN RIVER PKWY, SUITE 200
				TAMPA, FL 33637
				CERTIFICATE OF AUTHORIZATION 4356

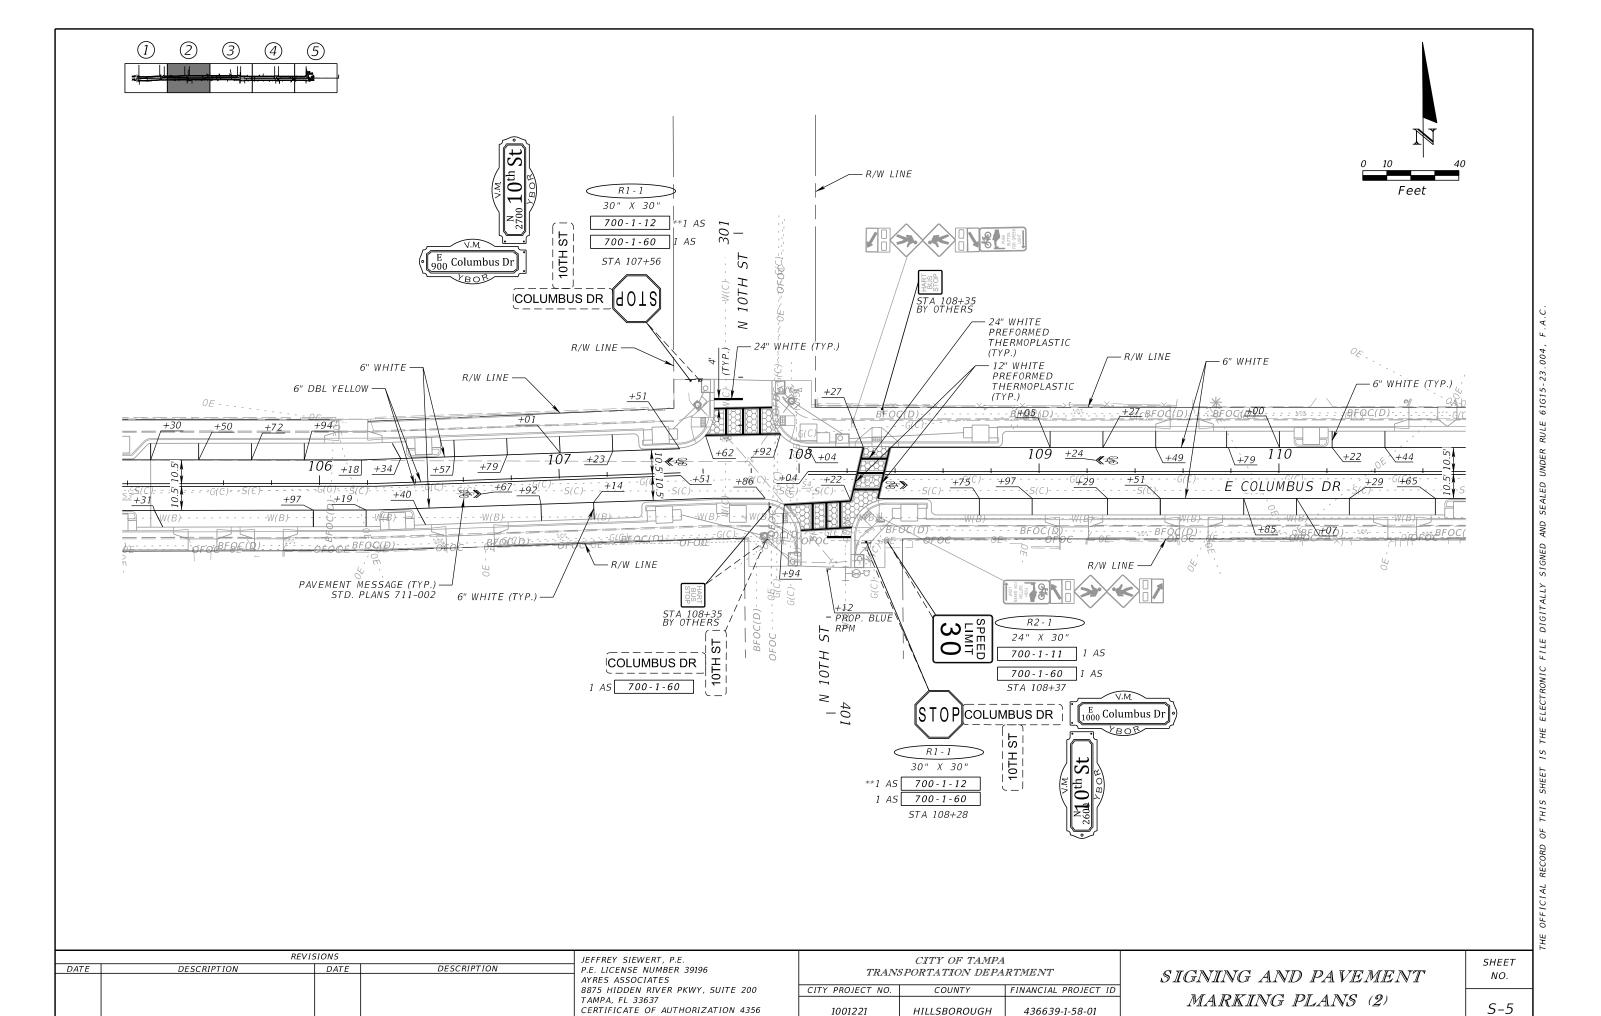CITY OF TAMPA TRANSPORTATION DEPARTMENT						
CITY PROJECT NO.	COUNTY	FINANCIAL PROJECT ID				
1001221	HILLSBOROUGH	436639-1-58-01				

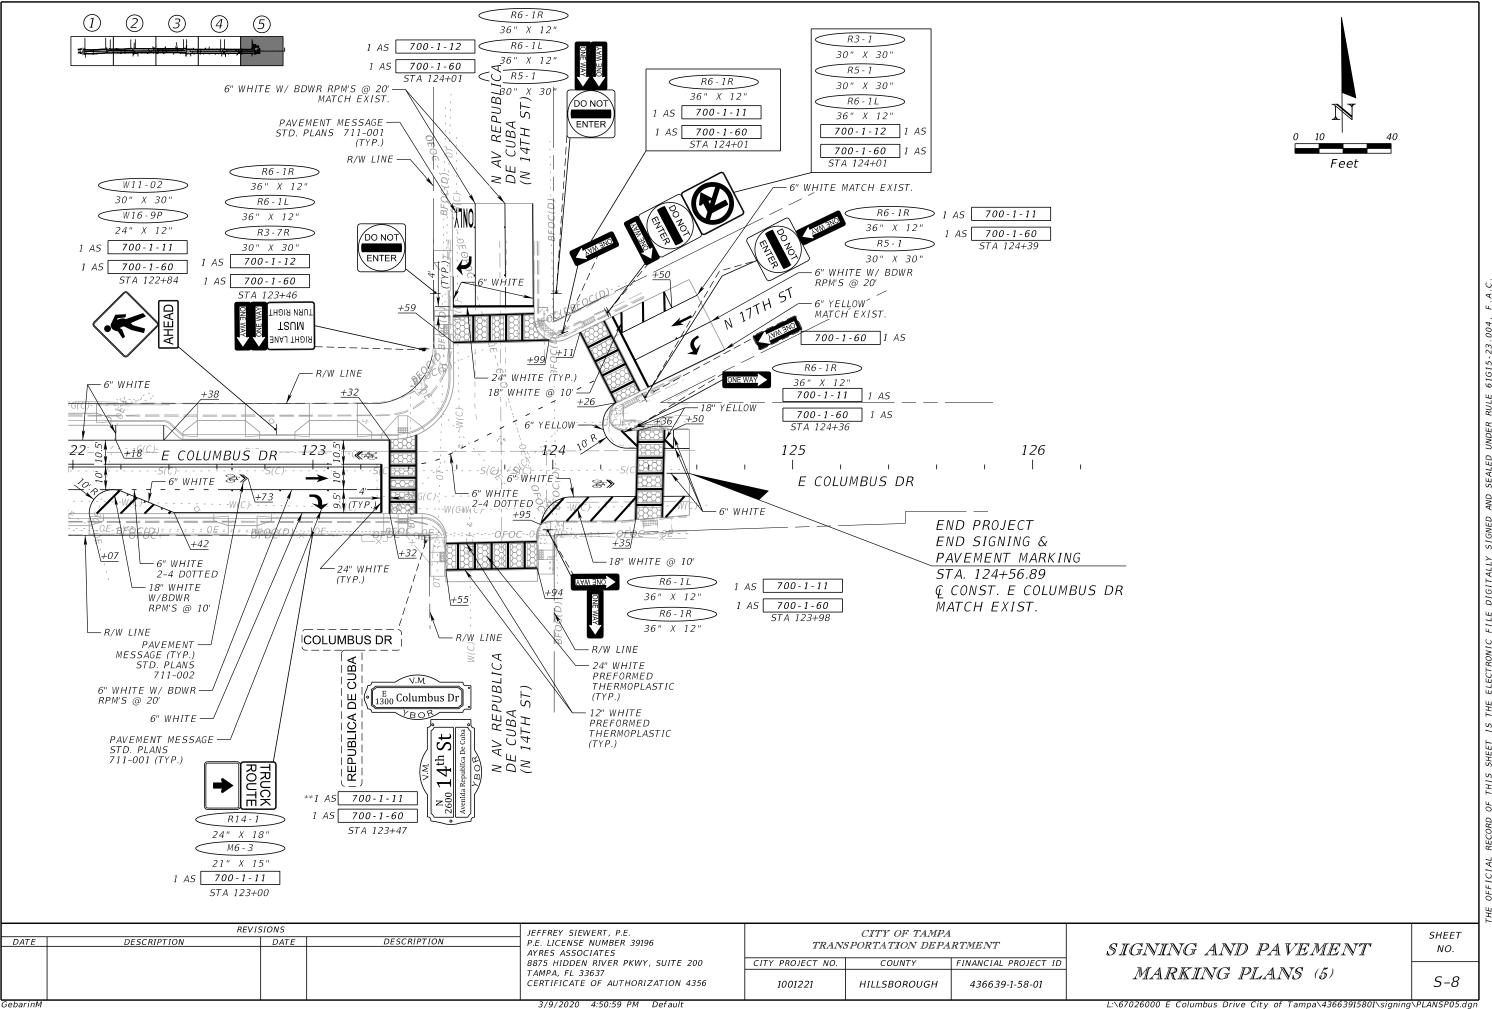HISTORIC SIGN DETAILS (1)

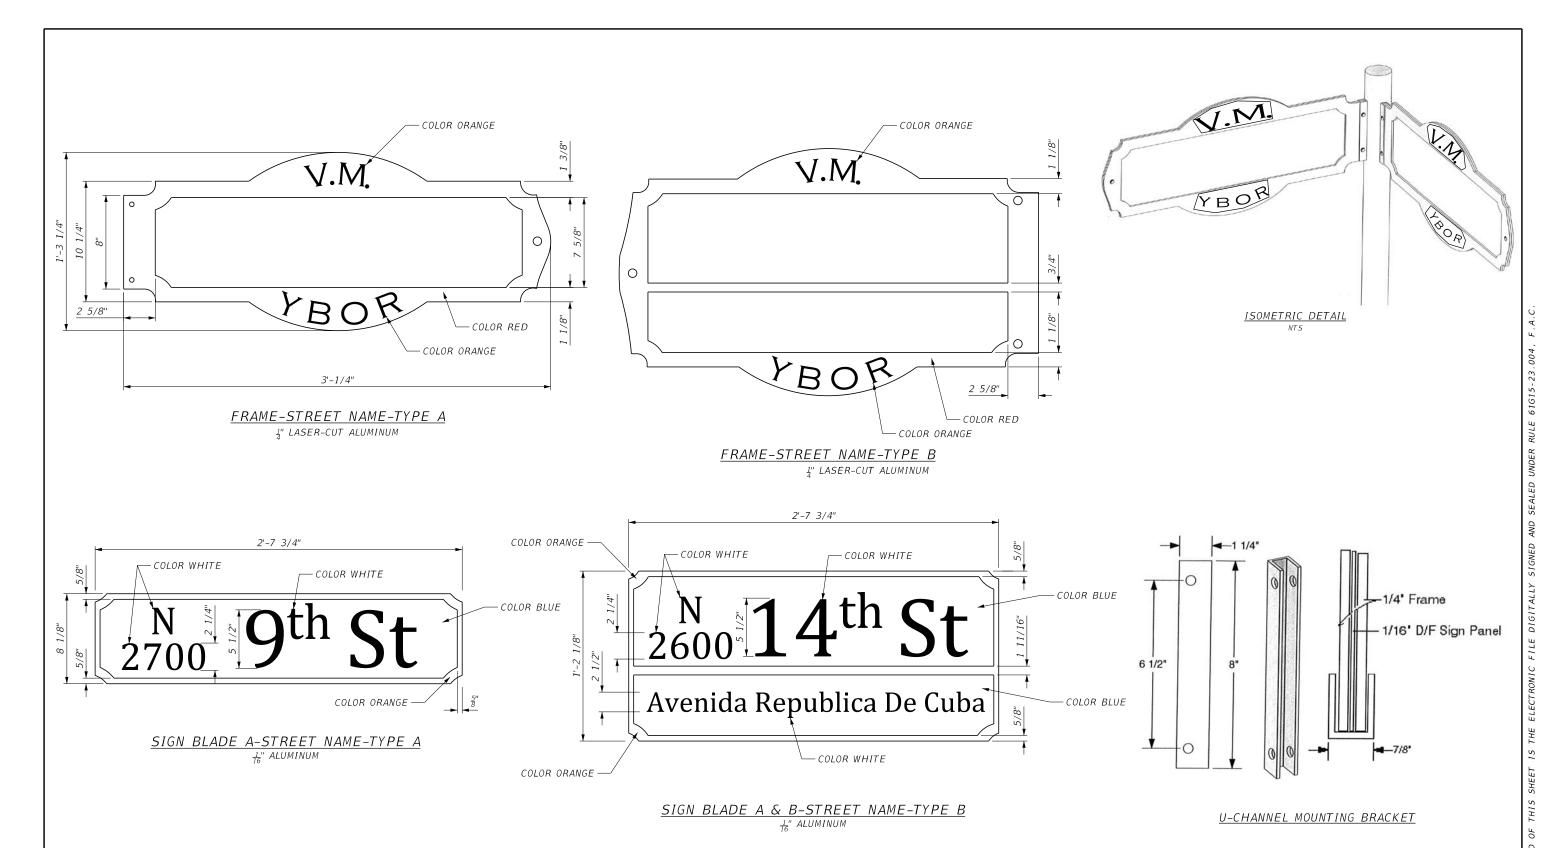
SHEET NO. S-9

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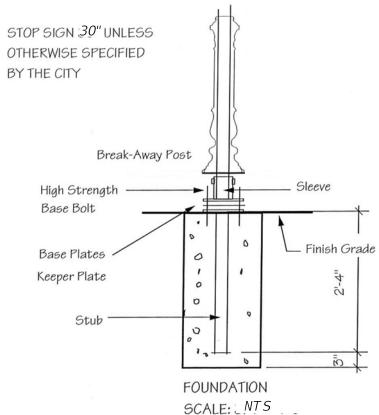




CROWN FINIAL NTS

NOTE: MODIFIED CAP TO BE TRIMMED AS SHOWN. (2) PIECE CAST ALUM. WELD, FILL, SAND, PRIME & PAINT BLACK. PROVIDED POST CAP. FITS 2 1/2"POST. 5" H X 5 1/2 W.

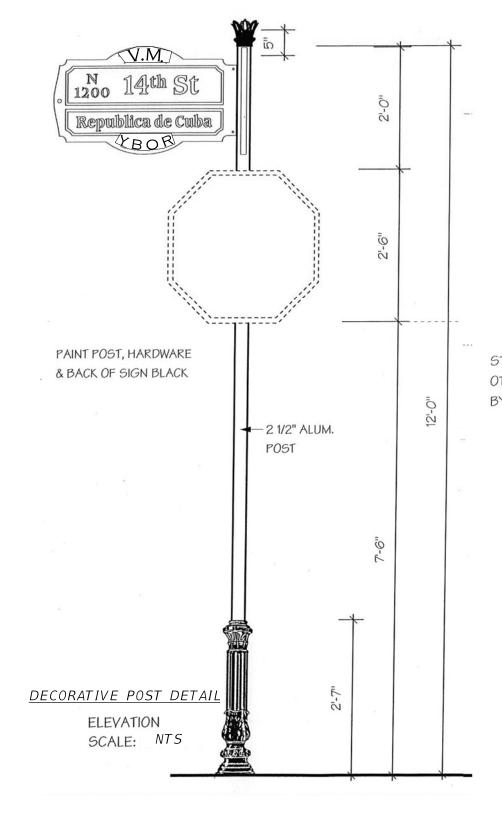Corinthian Post & Cap Orleans Ornamental Iron 3053 N. Rampart St. New Orleans, LA 70117 800-824-3608



	REVI	SIONS	
DATE	DESCRIPTION	DATE	DESCRIPTION

PAINT POST, HARDWARE

& BACK OF SIGN BLACK

STANDARD POST DETAIL

**ELEVATION** 

SCALE:

JEFFREY SIEWERT, P.E.
P.E. LICENSE NUMBER 39196
AYRES ASSOCIATES
8875 HIDDEN RIVER PKWY, SUITE 200
TAMPA, FL 33637
CERTIFICATE OF AUTHORIZATION 4356

CITY OF TAMPA
TRANSPORTATION DEPARTMENT

CITY PROJECT NO. COUNTY FINANCIAL PROJECT ID

1001221 HILLSBOROUGH 436639-1-58-01

HISTORIC SIGN DETAILS (2)

SHEET

2-6

2 1/2" ALUM.

POST

# WALK-BIKE LAP PROJECT

#### INDEX OF SIGNALIZATION PLANS

SHEET NO. SHEET DESCRIPTION

T-1 KEY SHEET

T-2 SIGNATURE SHEET

T-3 TABULATION OF QUANTITIES

T-4 GENERAL NOTES

T-5 THRU T-9 SIGNALIZATION PLAN

T-10 MAST ARM TABULATION SHEET

T-11 STANDARD MAST ARM ASSEMBLIES DATA TABLE
T-12 THRU T-13 GUIDESIGN WORKSHEET
T-14 REPORT OF CORE BORINGS

REFERENCE HART SPLICING AND CONNECTION DETAIL

CITY PROJECT NO. 1001221


FINANCIAL PROJECT ID 436639-1-58-01

(FEDERAL FUNDS)

HILLSBOROUGH COUNTY

E COLUMBUS DR FROM SR 45 (N NEBRASKA AVE) TO N 14TH ST

SIGNALIZATION PLANS

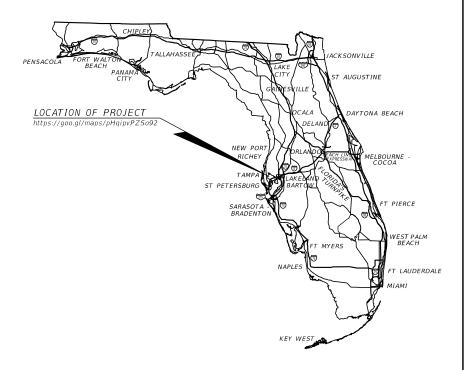

CONSTRUCTION PLANS MARCH, 2020


### SIGNALIZATION PLANS ENGINEER OF RECORD:

MICHAEL J. NOESEN, P.E.
P.E. LICENSE NUMBER 42255
BES INC.
11007 N. 56TH ST., SUITE 208
TEMPLE TERRACE, FL 33617
813-985-7800
CERTIFICATE OF AUTHORIZATION 9835

### CITY PROJECT MANAGER:

NINA MABILEAU, E.I.

FISCAL	SHEET
YEAR	NO.
21	T-1

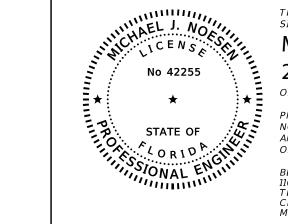

THIS ITEM HAS BEEN DIGITALLY SIGNED AND SEALED BY

## Michael J Noesen 2020.05.20 15:10:17 -04'00'


ON THE DATE ADJACENT TO THE SEAL

PRINTED COPIES OF THIS DOCUMENT ARE NOT CONSIDERED SIGNED AND SEALED AND THE SIGNATURE MUST BE VERIFIED ON ANY ELECTRONIC COPIES.

BES INC. 1107 N 56TH ST, SUITE 209 TEMPLE TERRACE, FL 33617 CERTIFICATE OF AUTHORIZATION: 9835 MICHAEL J. NOESON, P.E. NO. 52144

THE ABOVE NAMED PROFESSIONAL ENGINEER SHALL BE RESPONSIBLE FOR THE FOLLOWING SHEETS IN ACCORDANCE WITH RULE 61G15-23.004, F.A.C.

SHEET NO.	SHEET DESCRIPTION
T- 1	KEY SHEET
T- 2	SIGNATURE SHEET
T- 3	TABULATION OF QUANTITIES
T- 4	GENERAL NOTES
T- 5 THRU T- 9	SIGNALIZATION PLAN
T- 10	MAST ARM TABULATION SHEET
T- 12 THRU T- 13	GUIDESIGN WORKSHEET

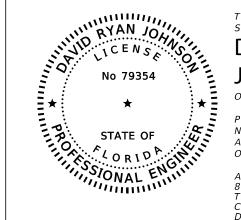

THIS ITEM HAS BEEN DIGITALLY SIGNED AND SEALED BY

David


Digitally signed by David Johnson Date: 2020.05.19 Johnson 15:07:51 -04'00' ON THE DATE ADJACENT TO THE SEAL

PRINTED COPIES OF THIS DOCUMENT ARE NOT CONSIDERED SIGNED AND SEALED AND THE SIGNATURE MUST BE VERIFIED ON ANY ELECTRONIC COPIES.

AYRES ASSOCIATES INC 8875 HIDDEN RIVER PKWY, SUITE 200 CERTIFICATE OF AUTHORIZATION: 4356 DAVID RYAN JOHNSON, P.E. NO. 79354

THE ABOVE NAMED PROFESSIONAL ENGINEER SHALL BE RESPONSIBLE FOR THE FOLLOWING SHEETS IN ACCORDANCE WITH RULE 61G15-23.004, F.A.C.

SHEET NO.	SHEET DESCRIPTION
T-2	SIGNATURE SHEET
T-11	STANDARD MAST ARM ASSEMBLIES DATA TABLE

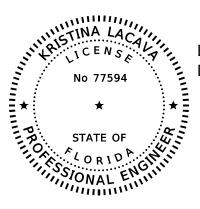

THIS ITEM HAS BEEN DIGITALLY SIGNED AND SEALED BY

Digitally signed by Kristina S LaCava Date: 2020.05.19 08:25:04 -04'00'

ON THE DATE ADJACENT TO THE SEAL

PRINTED COPIES OF THIS DOCUMENT ARE NOT CONSIDERED SIGNED AND SEALED AND THE SIGNATURE MUST BE VERIFIED ON ANY ELECTRONIC COPIES.

AREHNA ENGINEERING INC. 5012 WEST LEMON STREET TAMPA, FL 33609 CERTIFICATE OF AUTHORIZATION: 28410 KRISTINA LACAVA, P.E. NO. 77594

THE ABOVE NAMED PROFESSIONAL ENGINEER SHALL BE RESPONSIBLE FOR THE FOLLOWING SHEETS IN ACCORDANCE WITH RULE 61G15-23.004, F.A.C.

SHEET NO.	<u>SHEET DESCRIPTION</u>
T- 2	SIGNATURE SHEET
T- 14	REPORT OF CORE BORING.

	REVIS	MICHAEL J. NOESEN		
DATE	DESCRIPTION	P.E. LICENSE NO. 42255		
				BES INC.
				11007 N. 56TH ST., #208
				TEMPLE TERRACE, FL 33617
				CERTIFICATE OF AUTHORIZATION NO. 9835

CITY OF TAMPA TRANSPORTATION DEPARTMENT CITY PROJECT NO. COUNTY FINANCIAL PROJECT ID 33617 1001221 HILLSBOROUGH 436639-1-58-01

SIGNATURE SHEET

SHEET NO.

T-2

### TABULATION OF QUANTITIES

PAY ITEM	DESCRIPTION	UNIT	T			HEET I	NUMBER	 T	<u>. g</u>			TOT TH SHE	IS	GRAN TOTA	
NO .				FINAL PLAN						PLAN	FINAL			PLAN F	INAL
630-2-11	CONDUIT, F& I, OPEN TRENCH	LF	80					120				200		200	
630-2-12	CONDUIT, F& I, DIRECTIONAL BORE	LF	305					220				525		525	-+
632-7-1	SIGNAL CABLE- NEW OR RECONSTRUCTED INTERSECTION, FURNISH & INSTALL	PI	1					7				2		2	-+
632-7-6	SIGNAL CABLE, REMOVE - INTERSECTION	PI	1					1				1		1	-+
633-1-121	FIBER OPTIC CABLE, F&I, 2-12 FIBERS	LF	150									150		150	
633-2-32	FIBER OPTIC CONNECTION, INSTALL, TERMINATION	EΑ	12									12		12	
633-4-1	SIGNALS COMMUNICATION CABLE-TWISTED PAIR CABLE, F&I	LF						50				50		50	
633-4-6	SIGNALS COMMUNICATION CABLE-TWISTED PAIR CABLE, REMOVE	LF.	4.5					30				30		30	$\longrightarrow$
535-2-11	PULL & SPLICE BOX, F&I, 17" X 30" COVER SIZE	EA EA	13					15				28		28	$\longrightarrow$
<u>635-2-12</u> 639-1-122	PULL & SPLICE BOX, F&I, 24" X 36" COVER SIZE  ELECTRICAL POWER SERVICE, F& I, UNDERGROUND, METER PURCHASED BY CONTRACTOR	AS	1									1		1	-+
639-1-610	ELECTRICAL POWER SERVICE, REMOVE OVERHEAD	AS	1									1		1	-+
639-2-1	ELECTRICAL SERVICE WIRE, F&I	LF	75					30				105		105	
639-3-11	ELECTRICAL SERVICE DISCONNECT, F&I, POLE MOUNT	EΑ	1									1		1	
		ļ												<del></del>	
641-2-11	PRESTRESSED CONCRETE POLE, F&I, TYPE P-II, PEDESTAL	EA	2									2		2	$\longrightarrow$
641-2-12 641-2-70	PRESTRESSED CONCRETE POLE, F&I, TYPE P-II, SERVICE POLE (TEMPORARY)	EA	1 2									2		2	$\longrightarrow$
641-2-70	PRESTRESSED CONCRETE POLE, SHALLOW POLE REMOVAL- POLE 30' AND GREATER	EA	2			+									
646-1-11	ALUMINUM SIGNALS POLE, PEDESTAL	EA	.5					10				15		15	
646-1-60	ALUMINUM SIGNALS POLE, REMOVAL	EΑ	2					3				5		5	
649-21-12	STEEL MAST ARM ASSEMBLY, FURNISH AND INSTALL, DOUBLE ARM 60'-40'	EA	2									2		2	
CEO 1 11	VELVEN AS TRAFFIC CIONAL ENDINGLE O MOTAL ANNUAL RESTANCE AND RESTANC	1.6										0		<del></del>	$\longrightarrow$
650-1-14	VEHICULAR TRAFFIC SIGNAL, FURNISH & INSTALL ALUMINUM, 3 SECTION, 1 WAY	AS	8									8		8	-+
650-1-16	VEHICULAR TRAFFIC SIGNAL, FURNISH & INSTALL ALUMINUM, 4 SECTION, 1 WAY	AS	4									4		4	<del></del>
030 1 10	VEHICLEAN THAT TE STONAL, FORMISH & INSTALL ALBERTON, 4 SECTION, 1 WAI	1 73										7			
650-2-102	VEHICULAR SIGNAL AUXILIARIES, REPAIR/REPLACE/RETROFIT- F& I, BACKPLATE- BLACK	EΑ						7				7		7	
	WITH REFLECTIVE BORDER														
		L												<del></del>	$\longrightarrow$
<u>653-1-11</u>	PED. SIGNAL, F&I, LED-COUNTDOWN, 1 WAY	AS	2					10				12		12	$\longrightarrow$
<u>653-1-12</u> 653-1-60	PED SIGNAL, F&I, LED-COUNTDOWN, 2-WAYS PED. SIGNAL, REMOVE PED SIGNAL - POLE/PEDESTAL TO REMAIN	AS AS	3					4				3 4		3 4	
055-1-00	FED. SIGNAL, ALMOVE FED SIGNAL - FOLE/FEDESTAL TO ALMAIN	H A3						- 4				4			-
654-2-22	RECTANGULAR RAPID FLASHING BEACON, FURNISH & INSTALL- SOLAR POWERED, COMPLETE SIGN ASSEMBLY- BACK TO BACK	AS		2	2		2					6		6	
660-1-103	LOOP DETECTOR, INDUCTIVE, F&I, TYPE 3	EΑ						4				4		4	
660-2-101	LOOP ASSEMBLY- F&I, TYPE A	AS						4				4		4	
660-4-11	VEHICLE DETECTION SYSTEM-VIDEO, F&I, CABINET EQUIPMENT	EA	1									1		1	$\longrightarrow$
660-4-12	VEHICLE DETECTION SYSTEM-VIDEO, F&I, ABOVE GROUND EQUIPMENT	EA	4									4		4	-+
000-4-12	VEHICLE DETECTION STATEM-VIDEO, FAI, ABOVE GROUND EQUIFMENT	EA	+									4		-4	
665-1-12	PEDESTRIAN DETECTOR, F&I, ACCESSIBLE	EΑ	8					10				18		18	
665-1-60	PEDESTRIAN DETECTOR, REMOVE - POLE/PEDESTAL TO REMAIN	EΑ						5				5		5	
												_		<del></del>	$\longrightarrow$
670-5-110	TRAFFIC CONTROLLER ASSEMBLY, F&I, NEMA	AS	1					1				2		2	$\longrightarrow$
<u>670-5-600</u> 685-1-13	TRAFFIC CONTROLLER ASSEMBLY, REMOVE CONTROLLER WITH CABINET UNINTERRUPTIBLE POWER SUPPLY, F&I, LINE INTERACTIVE WITH CABINET	AS EA	1					<u> 1</u>				2		2	
009-1-19	OWINIERMOITIBLE TOWER SOTTET, TOXI, LINE INTERACTIVE WITH CADINET	LA	1					1							-+
700-3-201	SIGN PANEL, F&I, OVERHEAD MOUNT, UP TO 12 SF	EA	4									4		4	
700-5-22	INTERNALLY ILLUMINATED SIGN, FURNISH & INSTALL, OVERHEAD MOUNT, 12-18 SF	EA	4					4				8		8	
-														$\vdash$	
		<u> </u>				1								$\vdash$	$-\!\!\!\!-\!\!\!\!\!\!\!+$
						1									$\longrightarrow$
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	REVIS	MICHAEL J. NOESEN	
DATE	DESCRIPTION	P.E. LICENSE NO. 42255	
			BES INC.
			11007 N. 56TH ST., #208
			TEMPLE TERRACE, FL 33617 CERTIFICATE OF
			AUTHORIZATION NO. 9835

TRAI	CITY OF TAM NSPORTATION DEP	
CITY PROJECT NO.	COUNTY	FINANCIAL PROJECT ID
1001221	HILLSBOROUGH	436639-1-58-01

TABULATION OF QUANTITIES

SHEET NO.

T-3

TRAFFIC SIGNAL SHOP SUPERVISOR MR. SCOTT KEITH CITY OF TAMPA PHONE: (813) 951-2915 EMAIL: SCOTT.KEITH@TAMPAGOV.NET

- 2. DISPOSE ALL REMOVED EQUIPMENT IN CONTRACTOR PROVIDED AREAS EXCEPT FOR THE TRAFFIC CONTROLLER. THE TRAFFIC CONTROLLER SHALL BE RETURNED TO THE TAMPA SIGNAL SHOP.
- 3. CONTACT MR JOHN GASKINS @ 813-351-9973 FOR INFORMATION AND INSTALLATION OF CITY OF TAMPA COMPATIBLE VIDEO DETECTION
- 4. ALL HART EQUIPMENT WITHIN THE CABINET ON THE SOUTHEAST STRAIN POLE SHALL BE TRANSFERRED TO THE NEW CABINET AND MOUNTED WITHIN THE NEW CONTROLLER CABINET AND PLACED BACK INTO OPERATION. HART MUST BE CONTACTED 72 HOURS BEFORE TRANSFER. COST SHALL BE INCLUDED IN THE COST OF THE NEW CONTROLLER. HART'S ITS SPLICING AND CONNECTION DETAIL IS INCLUDED IN THE PLAN SET FOR REFERENCE. ITS SYSTEM SHALL NOT BE OUT OF SERVICE FOR MORE THAN 24 HOURS.
- 5. TEMPORARY VEHICLE DETECTION AND PEDESTRIAN CROSSING DETECTION SHALL BE MAINTAINED PER PAY 102-104 AND 102-107 IN THE ROADWAY PLANS.
- 6. SUBMIT SIGNALIZATION BORE LOGS WITH THE AS-BUILT PLANS.
- 7. REQUEST AND OBTAIN APPROVAL FROM THE ENGINEER FOR AVIAN ABATEMENT TO PREVENT NESTING IN THE MAST ARM ASSEMBLY, INCLUDING THE ARM CONNECTION AREA.
- 8. EXISTING OVERHEAD COPPER COMMUNICATIONS CABLE AT COLUMBUS DR AND NEBRASKA AVE SHALL NOT BE REMOVED. THE COPPER COMMUNICATION CABLE IS IN USE AND MUST BE SUPPORTED BY A POLE AT THE SOUTHEAST CORNER. CONTACT MR SCOTT KEITH (CITY OF TAMPA, 813-951-2915) FOR GUIDANCE IN REMOVING THE DROP FROM THE AERIAL SPLICE BAGGIE AND ANY OTHER NECESSARY SPLICING NEEDS. PROVIDE MATERIAL FOR ANY NECESSARY RE-SPLICING/TERMINATING OF ANY ACTIVE/INACTIVE COPPER PAIRS. BEAR RESPONSIBILITY FOR ANY DAMAGE AND/OR REPLACEMENT OF ANY COPPER CABLE AND/OR RELATED EQUIPMENT.
- 9. CONTACT MR. SCOTT KEITH (CITY OF TAMPA, 813-951-2915) PRIOR TO REMOVAL AND REPLACEMENT OF THE 6 PAIR COPPER COMMUNICATIONS CABLE AT AVENIDA REPUBLICA DE CUBA INTERSECTION TO ENSURE PROPER COLORS ARE SPLICED.

PAY ITEM NOTES:

- 1. 630-2-11 AND 630-2-12
- CONDUITS INSTALLED WITH THE DIRECTIONAL BORE METHOD ARE HDPE, UNLESS OTHERWISE NOTED IN THE PLANS.

TWO SEPARATE UNDERGROUND CONDUIT RUNS LOCATED 180 DEGREES APART ARE REQUIRED FOR MAST ARMS. INSTALL A MINIMUM OF TWO RUNS OF TWO INCH CONDUIT BETWEEN THE LAST LOW VOLTAGE (LOOPS) PULL BOX LOCATED NEAR THE CONTROLLER CABINET AND THE CONTROLLER CABINET.

CONDUIT RUNS SHOWN ARE SCHEMATIC AND FIELD ADJUSTMENTS MAY BE NECESSARY. DETERMINE EXACT LOCATIONS OF ALL UTILITIES PRIOR TO DIGGING. ALL CONDUITS SHALL BE TERMINATED WITH A BELL END. SPARE CONDUITS ARE TO BE CAPPED AND HAVE TRACK WIRE OR MULE TAPE.

2. 632-7-1:

WIRE EACH PHASE/MOVEMENT FROM THE SIGNAL DISPLAY TO THE CONTROLLER AS A SEPARATE PHASE/MOVEMENT. THIS
INCLUDES THE LEFT TURN MOVEMENT WHICH HAVE CONDUCTORS AVAILABLE FOR EITHER PROTECTED OR PERMISSIVE MOVEMENTS.
VERIFY COLOR CODES FOR SIGNAL CABLE AND INTERCONNECT CABLE WITH THE CITY OF TAMPA TRAFFIC SIGNAL SUPERVISOR BEFORE
ORDERING, AND WIRE THE SIGNAL IN ACCORDANCE WITH THAT COLOR CODE AND F.D.O.T. SPECIFICATIONS. INSTALL ONE NEUTRAL PER APPROACH.

ALL FIELD WIRING MUST BE NEATLY BUNDLED AND CLEARLY IDENTIFIED WITH PERMANENT, LEGIBLE, WEATHER-PROOF TAGS SECURELY ATTACHED TO EACH CABLE. THE TAGGING SYSTEM SHALL BE SUBMITTED FOR APPROVAL WITH THE OTHER EQUIPMENT SUBMITTALS.

3. 635-2-11: ANY PULL BOXES THAT REMAIN AFTER THE CONSTRUCTION OF THE PROJECT BUT NO LONGER NEEDED FOR THE TRAFFIC OPERATION ARE TO BE REMOVED, AND FILLED IN WITH CONCRETE OR REPLACEMENT OF SIDEWALK PANEL.

GROUND RODS CAN BE WITHIN THE PEDESTRIAN SIGNAL FOUNDATION OR WITHIN THE PEDESTRIAN SIGNAL PULL BOX THAT IS WITHIN 10 FEET OF THE PEDESTRIAN POLE. IF THESE APPLICATIONS ARE NOT AVAILABLE, GROUND RODS NEED TO BE ACCESSIBLE FOR INSPECTION. ONE GROUND ROD PER POLE.

- 4. 649-21-12: MAST ARM STRUCTURES ARE TO BE RATED FOR 150 MPH WIND SPEED.
- 5. 654-2-22: RRFB'S MUST BE ACCEPTABLE TO THE CITY. RRFB PEDESTRIAN BUTTONS MUST HAVE A TACTILE ARROW WITH NO LED, CHIRP OR LATCHING CAPABILITIES.
  RRFB'S MUST HAVE SUPPORT COLLARS WITH ROLL PINS. SIDE CAPS MOUNTED ON THE EDGES OF THE FLASHER HOUSING ARE TO BE REMOVED.
- 6. 660-4-12: ONE FISHEYE, BELL TYPE CAMERA TO DETECT TRAFFIC IN ALL DIRECTIONS.
- 7. 665-1-12:

COORDINATE WITH THE CITY OF TAMPA SIGNAL SHOP FOR ACCEPTABLE CHOICES OF PEDESTRIAN DETECTORS AND OPERATIONS. PIEZO STYLE LATCHING PUSH BUTTON SHALL INCLUDE VISUAL INDICATION OF ACTUATION AND SHALL REMAIN ILLUMINATED UNTIL THE PEDESTRIAN WALK INDICATION IS DISPLAYED. DIRECTION SPECIFIC PUSH BUTTON SHALL HAVE A TACTILE ARROW. APPROPRIATE BUTTONS MUST HAVE LEFT OR RIGHT ARROWS AND MUST BE ALIGNED WITH AND POINTING AT THE DESIGNATED PEDESTRIAN RAMP. THE BUTTON MUST BE MOUNTED SO SPEAKER IS FACING DOWN. INCIDENTAL EQUIPMENT MAY BE REQUIRED FOR PROPER OPERATION.


8. 670-5-100:


THIS PAY ITEM SHALL INCLUDE ALL COSTS ASSOCIATED WITH FURNISHING AND INSTALLING A FULLY LOADED TS2 TYPE-1, SIZE P-44 CONTROLLER ASSEMBLY WITH AN EIGHT PHASE BACKPLANE, MINIMUM SIXTEEN LOAD BAY POSITIONS, NO PAINT OUTSIDE, WHITE PAINT INSIDE, GPS CLOCK SYNC, TWO QUAD OUTLETS, ONE DUPLEX GFI, WALL MOUNT PATCH PANEL (12X SINGLE MODE WITH SC-CONNECTORS), ETHERNET EDGE SWITCH, CONTROLLER WITH CENTRAL SOFTWARE LICENSE COMPATIBLE WITH THE CITY'S CENTRACS TRAFFIC CONTROL SYSTEM MMU AND ANY HART EQUIPMENT. NOTIFY CITY OF TAMPA SIGNAL SHOP (MR SCOTT KEITH @ 813-951-2915, SCOTT.KEITH @ TAMPAGOC.NET) AND FDOT DISTRICT SEVEN TRAFFIC OPERATION (MR DWAYNE DEMPSEY, 813-975-6226, CURTIS.DEMPSEY @ DOT.STATE.FL.US) AT LEAST 48 HOURS IN ADVANCE OF TURNING ON A NOW OR MODIFIED CONTROLLER CABINET ASSEMBLY. CABINET DOOR SHALL OPEN AWAY FROM THE TRAFFIC. THE TECHNICIAN SLAB SHALL BE A MAXIMUM OF 4" BELOW THE TOP OF THE CONCRETE PAD.


9. 700-5-21; 700-5-22:


SUBMIT DESIGN CALCULATIONS AND SHOP DRAWINGS FOR THE FREE-SWINGING INTERNALLY ILLUMINATED STREET NAME BRACKET ARMS PER STANDARD PLAN INDEX 700-050. THE DESIGN WIND SPEED IS 150 MPH. THE PANELS SHALL BE TWO-SIDED (BACK TO BACK).


										_ ⊦				
	REVI.	SIONS		MICHAEL J. NOESEN		CITY OF TAI	C							
DATE	DESCRIPTION	DATE	DESCRIPTION	P.E. LICENSE NO. 42255 BES INC.	TRAI	NSPORTATION DE			SHEET NO.					
				11007 N. 56TH ST., #208	CITY PROJECT NO.	COUNTY	FINANCIAL PROJECT ID	$GENERAL\ NOTES$	<del></del>	$\dashv$				
				TEMPLE TERRACE, FL 33617 CERTIFICATE OF AUTHORIZATION NO. 9835	1001221	HILLSBOROUGH	436639-1-58-01		T-4					

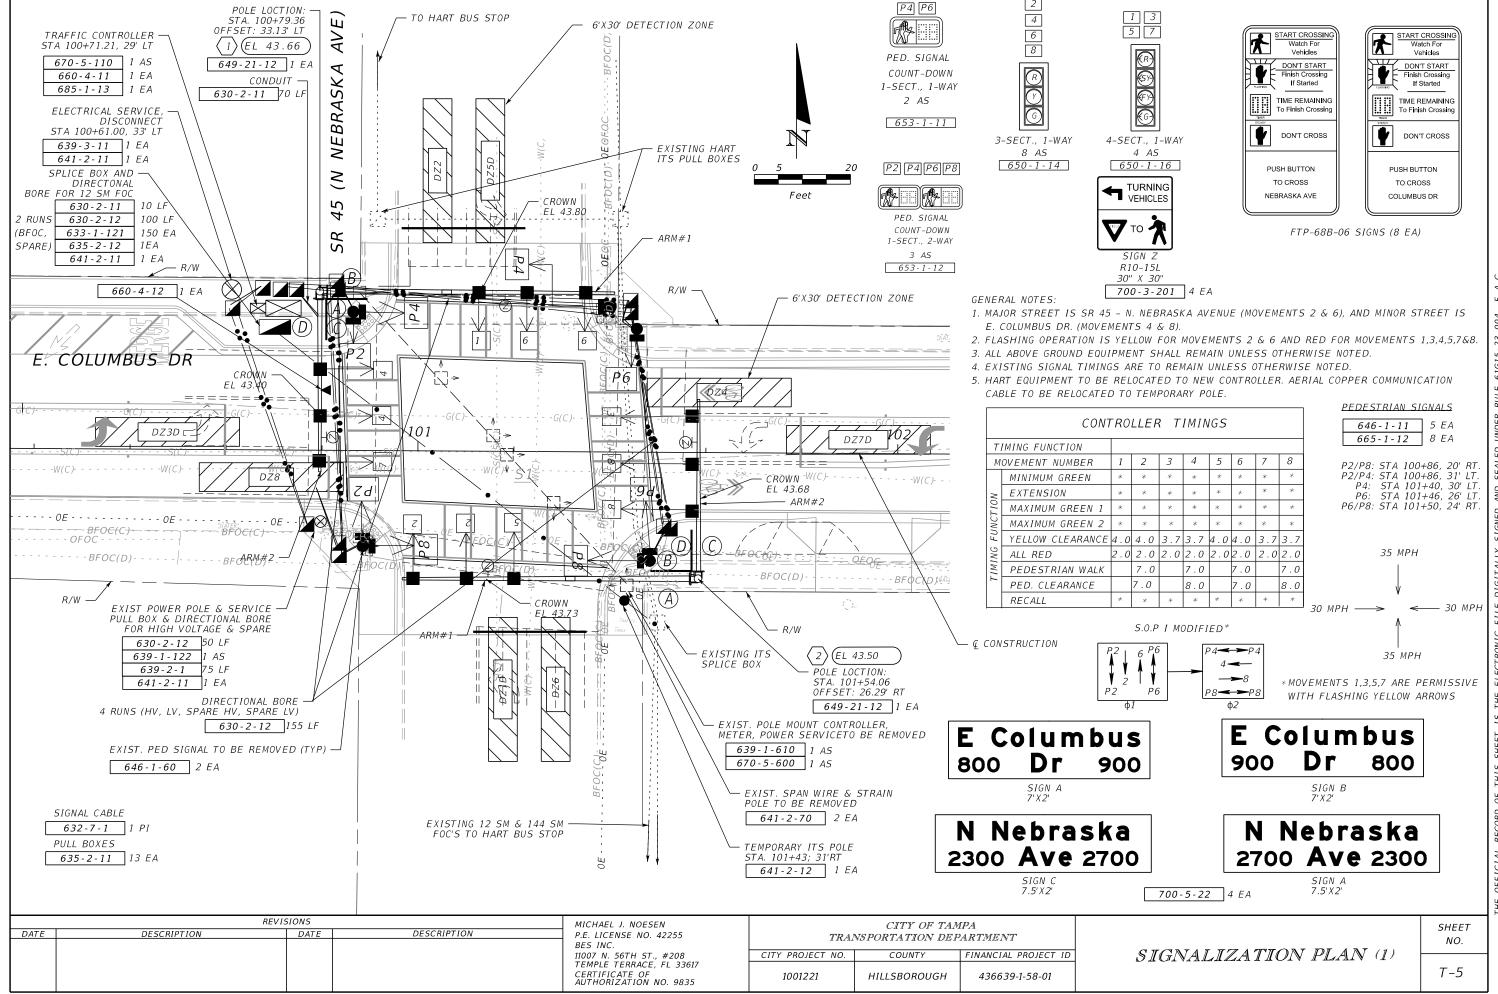


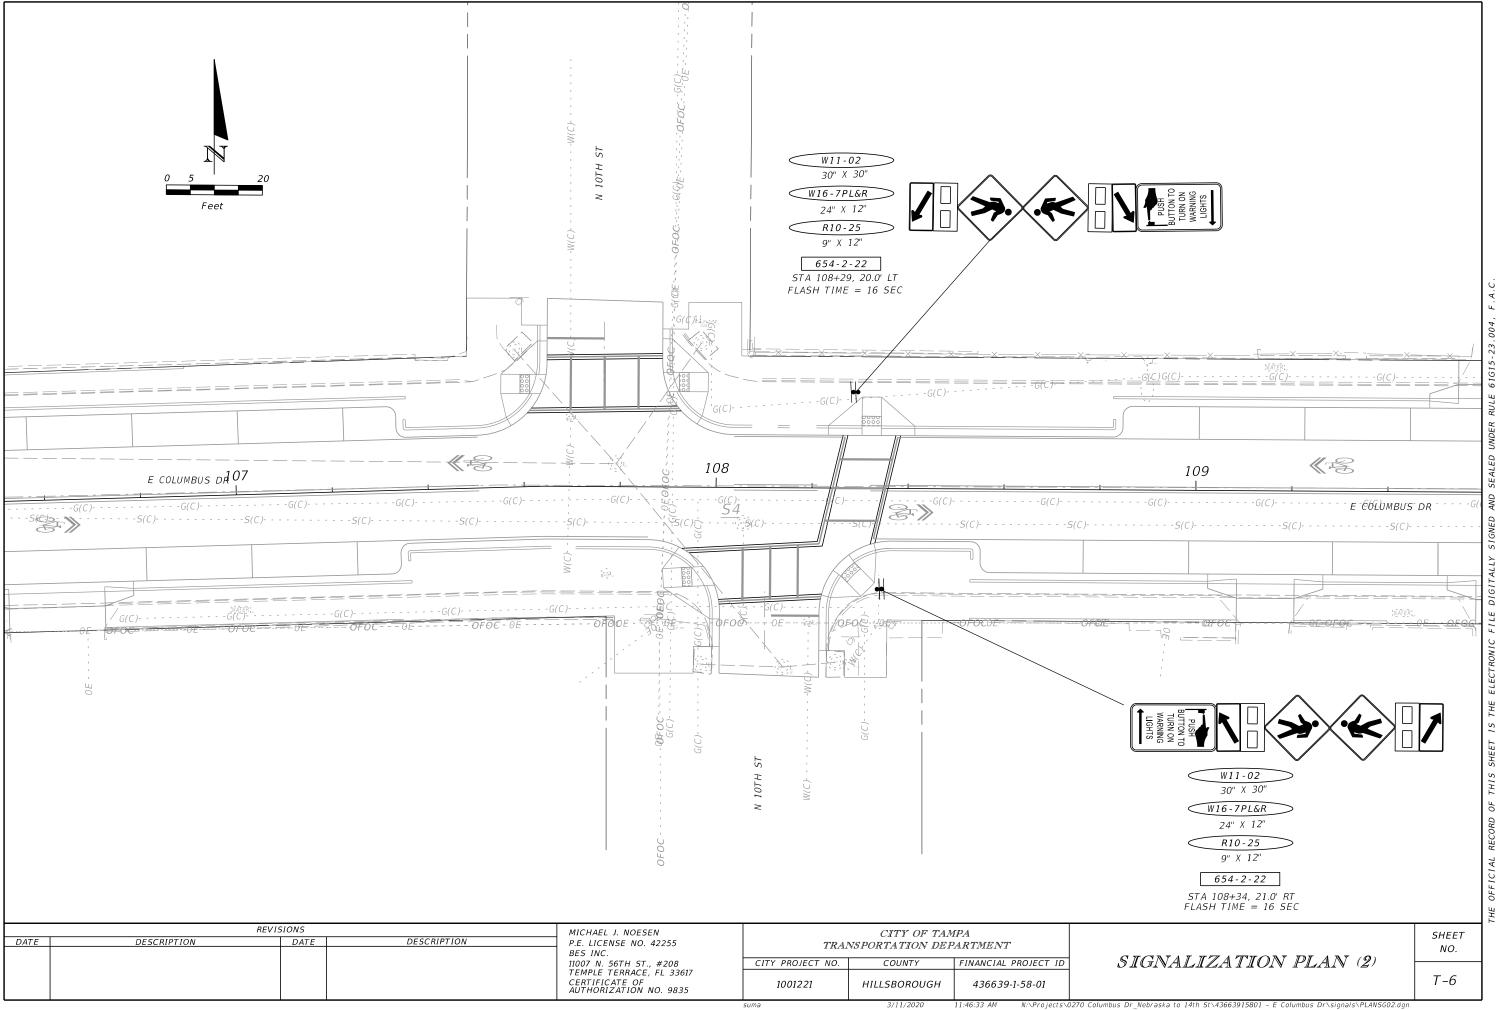


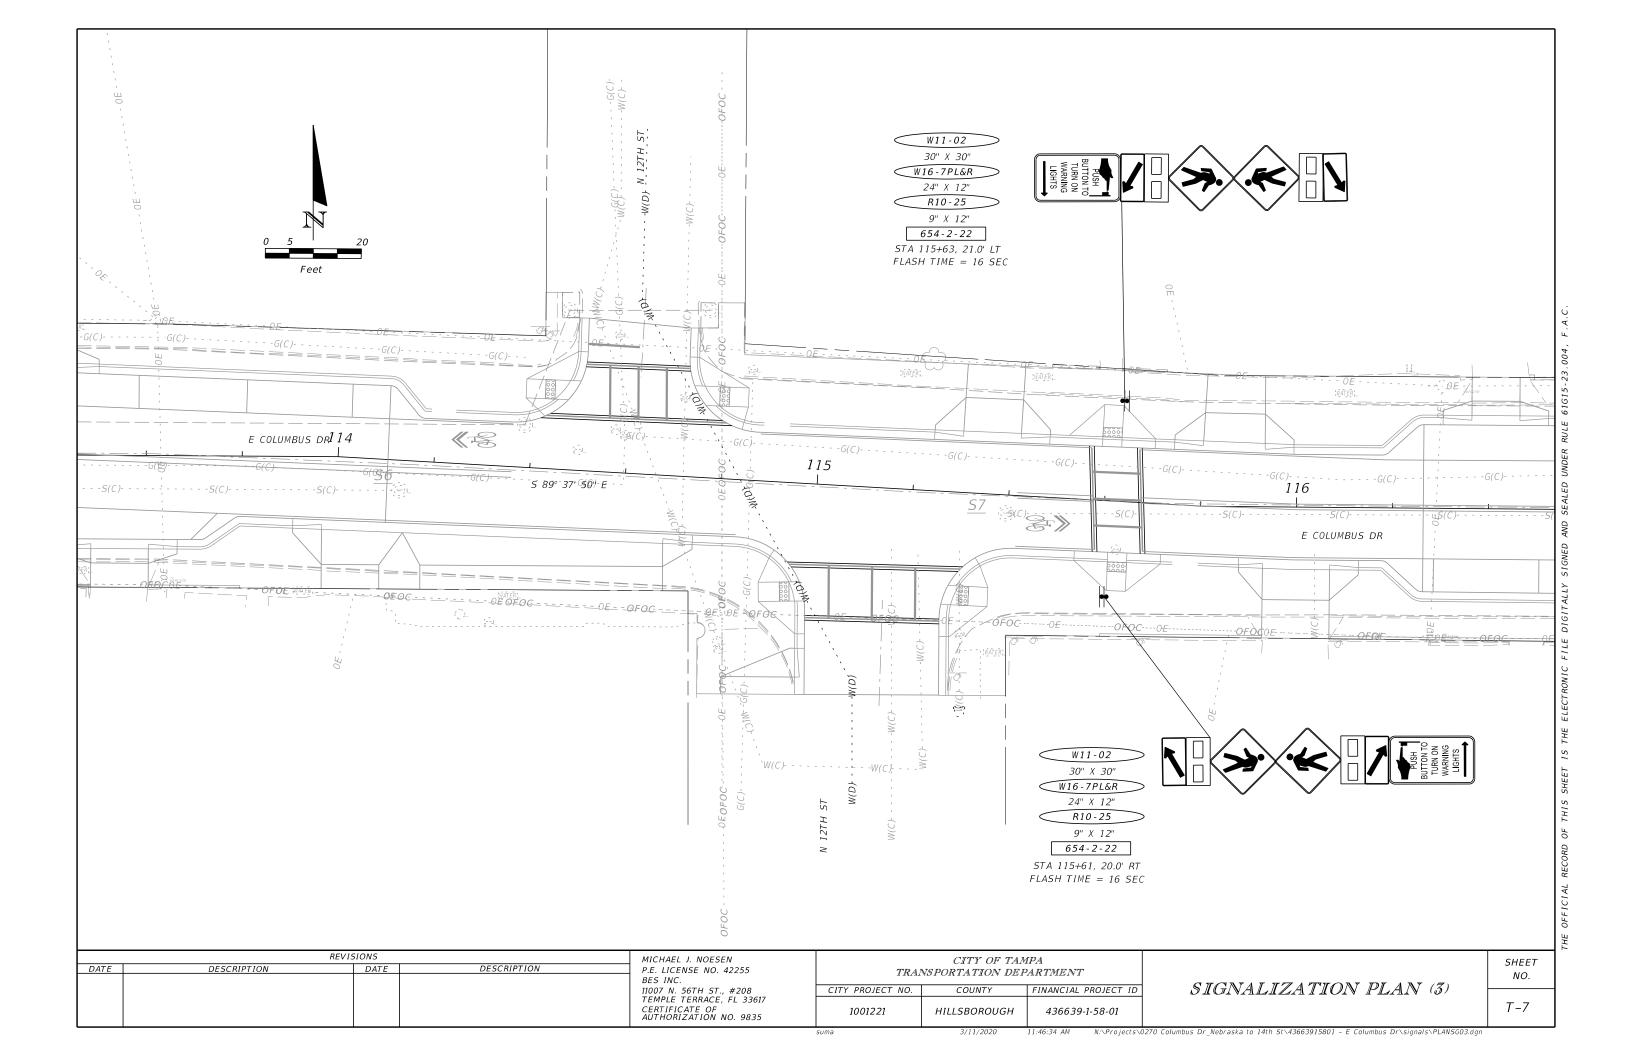

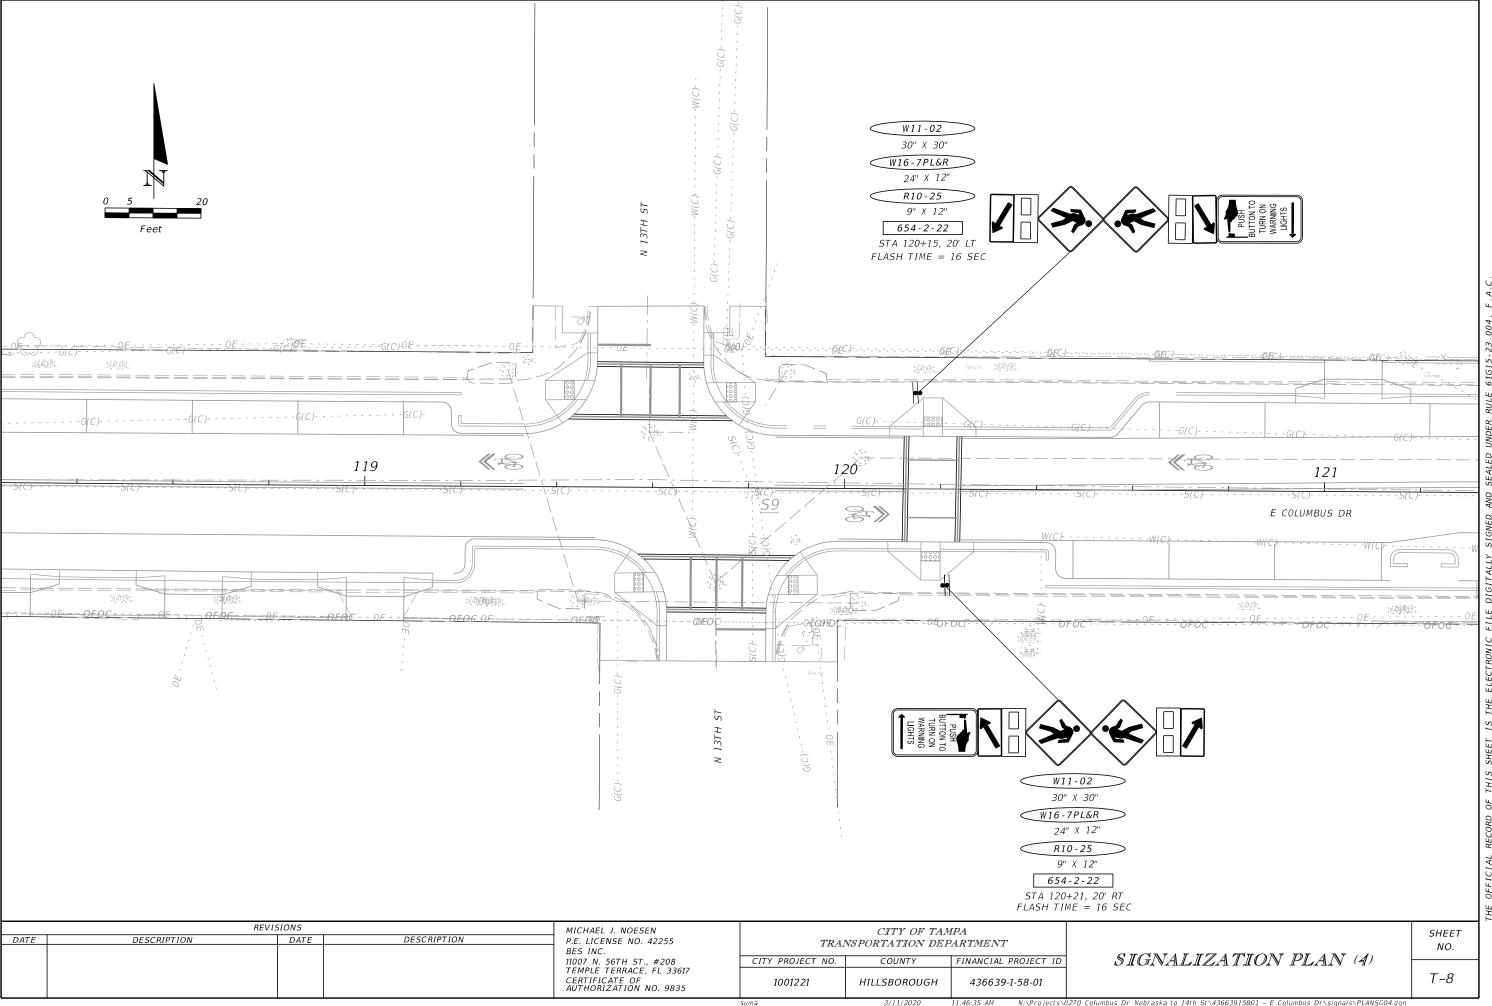

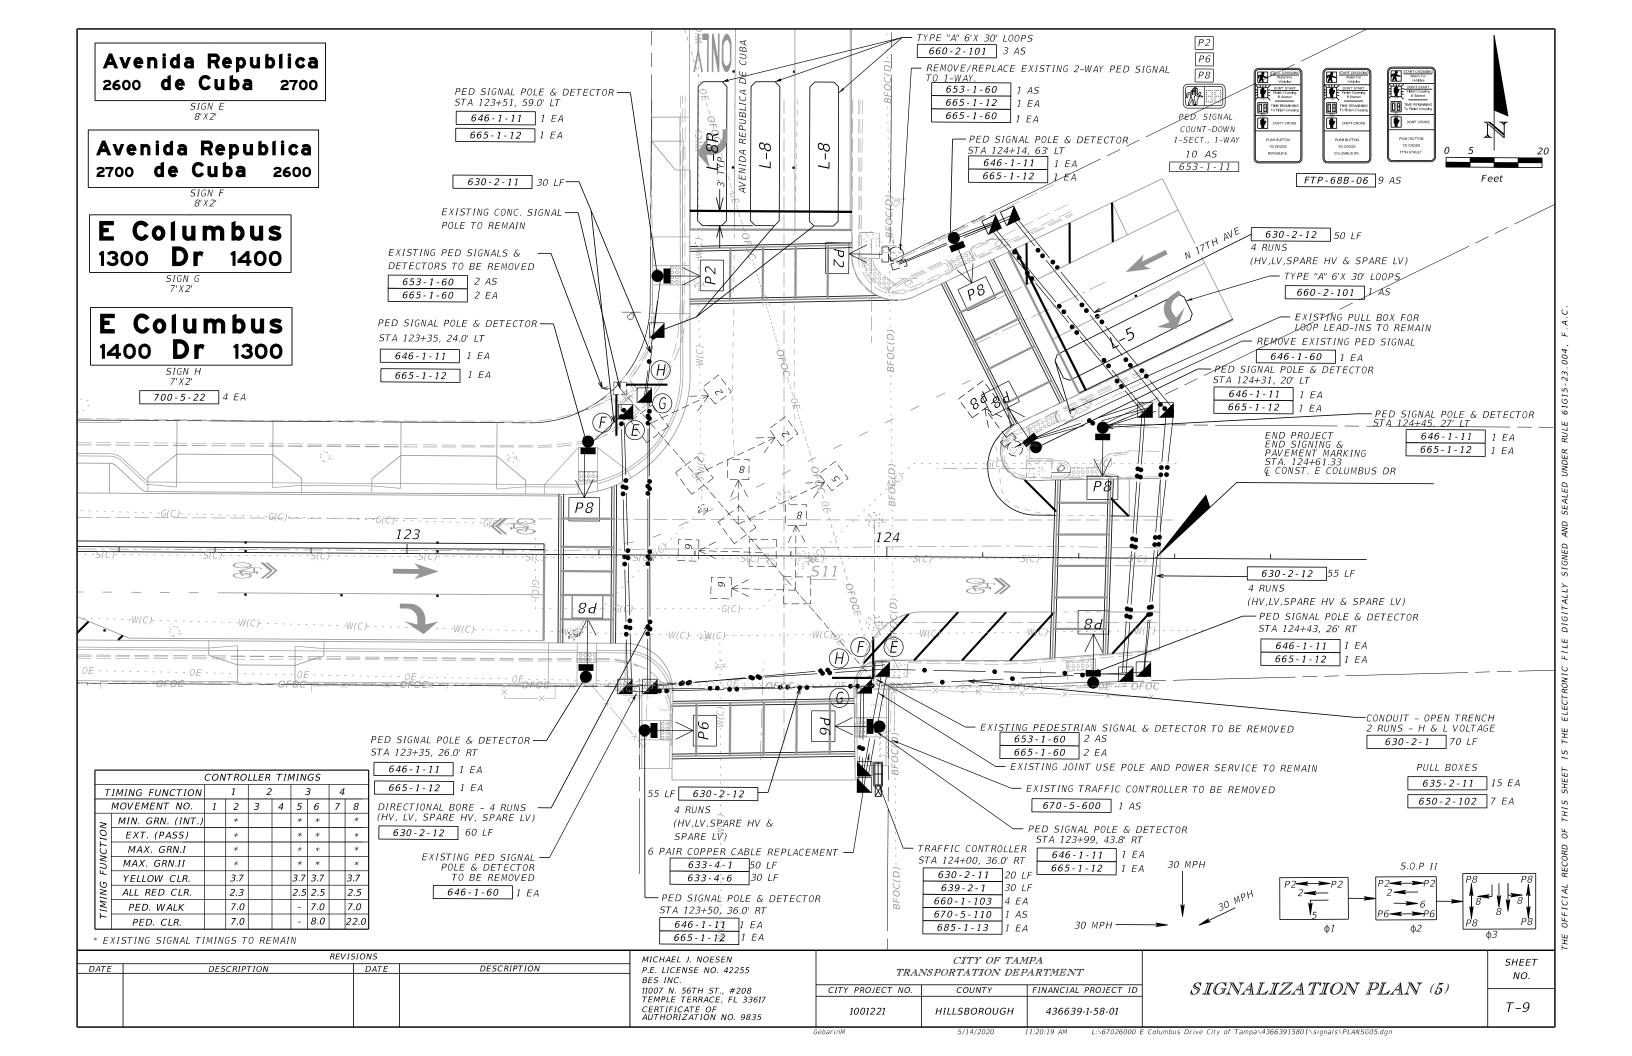

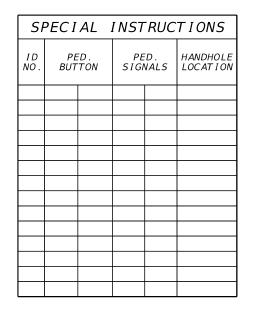

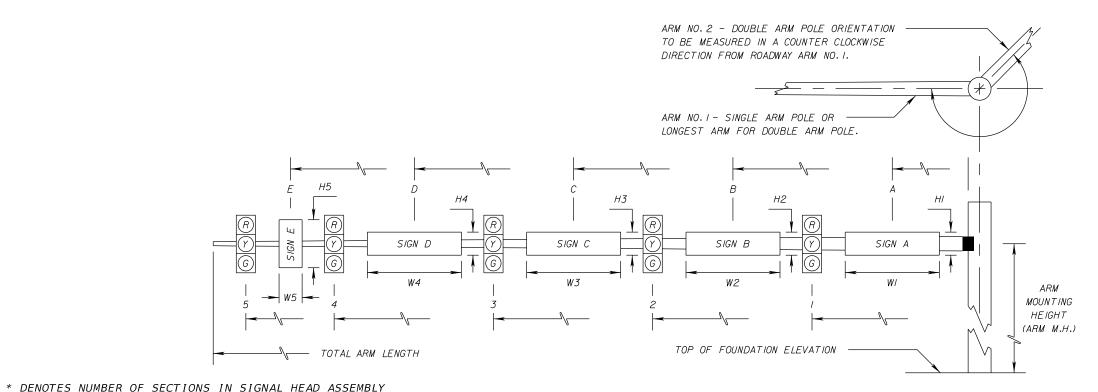

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I D	SHEET NO.	LOCATION	TOP OF	RDWY	CROWN	SIGNA	BACK	PED.				DIS	ST AN	ICE F	ROM	1 POLI	E			то	TAL A	\RM	ANGLE BETWEEN	DISTANCE FROM POLE / HEIGHT AND WIDTH OF SIGN					DISTANCE FROM POLE / HEIGH	PAIN									
10 .	NO.	LOCATION BY STA.	TOP OF FOUND. ELEVATION	I ARM NO.	CROWN ELEV.	V/H	BACK PLATES Y/N	Y/N	1	k	k	2	*	3	*	4	*	5	k	k LEN	GTH M	. H .	ANGLE BETWEEN DUAL ARMS 90/270	Α	H1	W 1	В	H2	W2	· C	НЗ	3 W.	3 i	D	Н4	W4	Ε	H5 W5	COLO
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	REVISIONS													
DATE	DESCRIPTION	P.E. LICENSE NO. 42255												
				BES INC.										
				11007 N. 56TH ST., #208 TEMPLE TERRACE, FL 33617 CERTIFICATE OF AUTHORIZATION NO. 9835										

CITY OF TAMPA TRANSPORTATION DEPARTMENT						
CITY PROJECT NO.	COUNTY	FINANCIAL PROJECT ID				
1001221	HILLSBOROUGH	436639-1-58-01				

MAST ARM TABULATION SHEET SHEET NO.

T-10

suma

	STAN	DARD M	AST ARI	M ASSEN	<i>1BLIES</i>	DATA T	ABLE				Table Date 11-16-18
STRUCTURE	DESIGNATION	FIRST ARM SEC		SECON	D ARM	UF		POLE			DRILLED
ID NUMBERS		ARM ID	FAA (ft.)	ARM ID	SAA (ft.)	(deg)	LL (deg)	POLE ID	UAA (ft.)	UB (ft.)	SHAFT ID
1	A60/D-A40/D-P4/D	A60/D		A40/D	34	270		P4/D		22	D5/18/5.0
2	A60/D-A40/D-P4/D	A60/D		A40/D	36	270		P4/D		22	D5/18/5.0
					•			•			

NOTES [Notes Date 11-01-16]:

- 1. If an entry appears in column FAA, a shorter arm is required. This is obtained by removing length from the arm tip and the arm length shortened from FA to FAA. SAA Similar.
- 2. If an entry appears in column UAA, a shorter pole is required. This is obtained by removing length from the pole tip and the pole height shortened from UA to UAA.
- 3. Work with Index 649-030 and 649-031.
- 4. Design based on Borings taken by Arehna Engineering Inc. on March 27, 2018. Geotechnical Engineering Services Report sealed by Kristina S. Lacava, P.E.

Assumptions and Values used in design:

Soil Type: Sand

Soil Layer Thickness = 30 ft.

Soil Friction Angle = 29 deg.

Soil Weight = 43 pcf

Design Water Table is assumed at groundline.


	DAVID RYAN JOHNSON			
DATE	DESCRIPTION	DATE	DESCRIPTION	P.E. LICENSE NUMBER 79354
				AYRES ASSOCIATES 8875 HIDDEN RIVER PKWY, SUITE 200 TAMPA, FL 33637 CERTIFICATE OF AUTHORIZATION 4356


CITY OF TAMPA TRANSPORTATION DEPARTMENT						
CITY PROJECT NO.	COUNTY	FINANCIAL PROJECT ID				
1001221	HILLSBOROUGH	436639-1-58-01				

STANDARD MAST ARM ASSEMBLIES DATA TABLE SHEET NO.

T - 1.1

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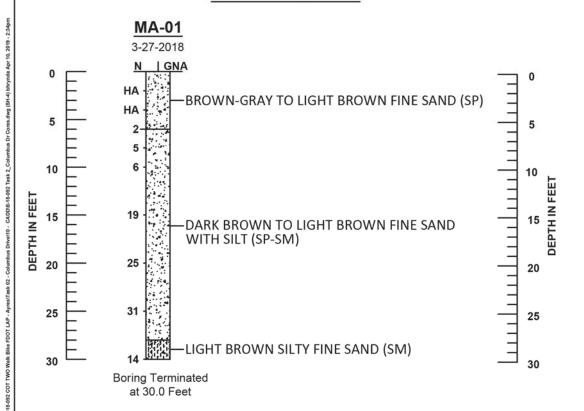


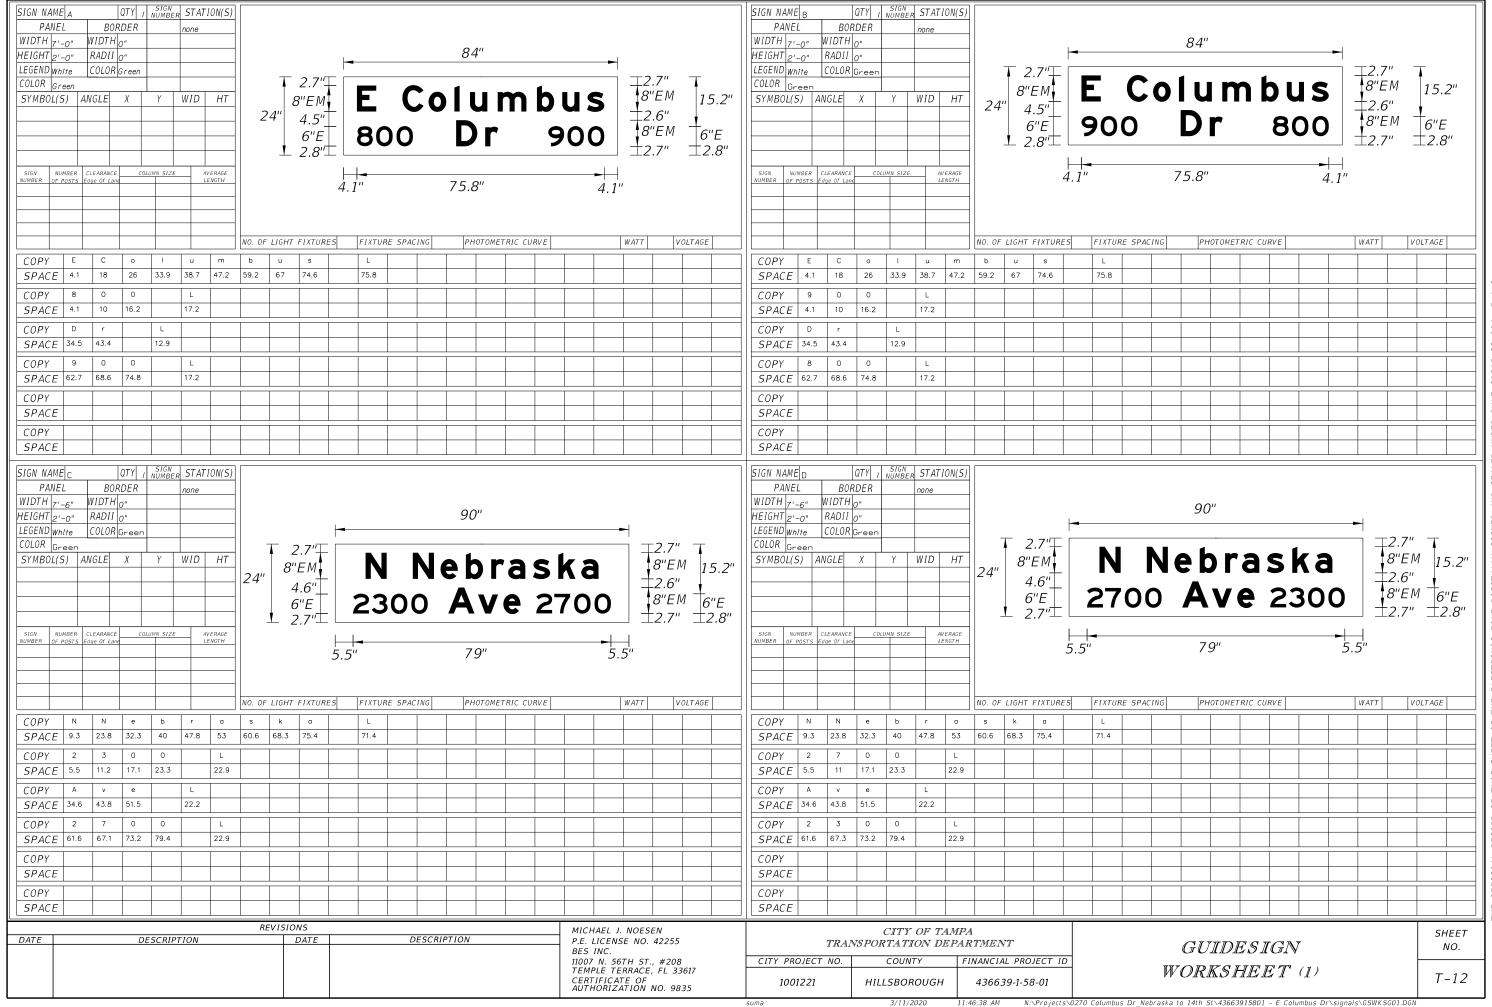
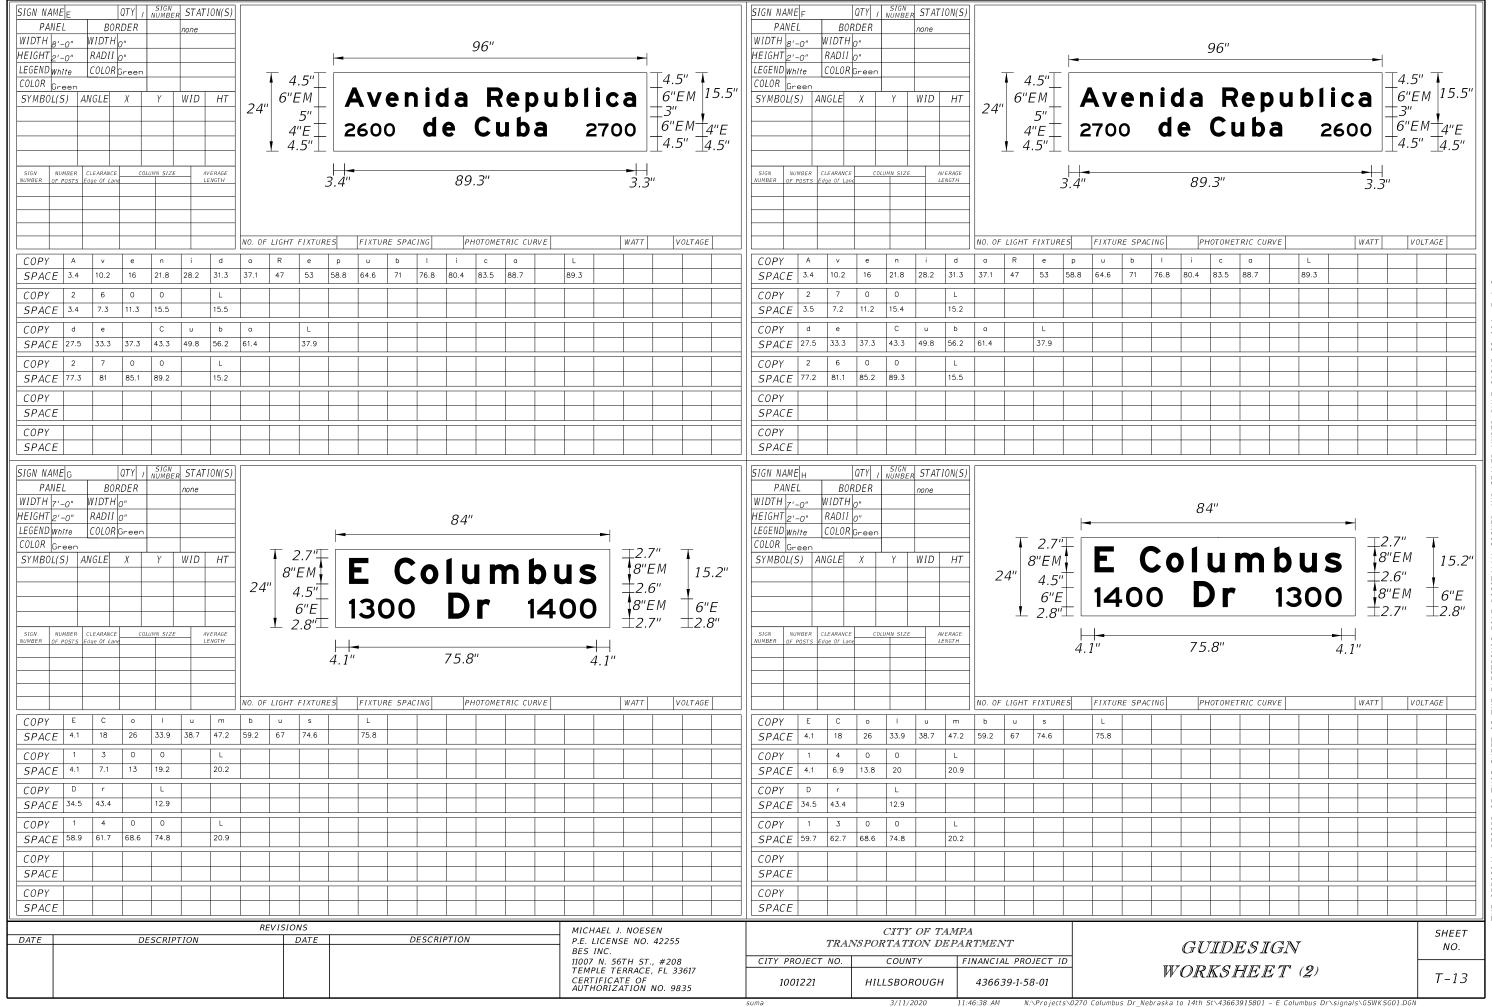
## REPORT OF CORE BORING



# **SOIL PROFILE**



# **LEGEND**



SAND (SP/SP-SM)



SILTY SAND (SM)

- SP Unified Soil Classification System (ASTM D 2488) Group Symbol as Determined by Visual Review and/or Laboratory Testing
- HA Hand Augered To Avoid Utility Conflicts and Safety Reasons
- N SPT N-Value in Blows/Foot for 12 Inches of Penetration Utilizing Automatic Hammer
- GNA Groundwater Table Not Apparent at Time of Drilling

BORING NUMBER	DEPTH (FEET)	SPT "N" AVERAGE	SOIL CLASSIFICATION	APPROXIMATE SOIL UNIT WEIGHT (PCF)				COHESION (PSF)	SOIL ANGLE OF FRICTION	EARTH P COEFF	ICIENT
				y SAT	y SUB		(DEGREES)	Ka	Кр		
MA-01	0 -13	4	SP	100	37.6	-	29	0.350	2.859		
IVIA-U1	13 - 30	22	SP-SM, SM	115	52.6	-	32	0.302	3.309		

### Soil Profile Notes:

- 1. The profiles depicted are of a generalized nature to highlight the major subsurface stratification features and material characteristics. The soil profiles include soil description, stratifications and penetration resistances. The stratifications shown on the boring profiles represent the conditions only at the actual boring location. Variations may occur and should be expected between boring locations. The stratifications represent the approximate boundary between subsurface materials and the actual transition may be gradual.
- Groundwater levels generally fluctuate during periods of prolonged drought and extended rainfall
  and may be affected by man-made influences. In addition, a seasonal effect will also occur in
  which higher groundwater levels or temporary perched conditions are normally recorded in rainy
  seasons.

	SAFETY HAMMER	AUTOMATIC HAMMER
GRANULAR MATERIALS-	SPT N-VALUE	SPT N-VALUE
RELATIVE DENSITY	(BLOWS/FT.)	(BLOWS/FT.)
VERY LOOSE	LESS THAN 4	LESS THAN 3
LOOSE	4 to 10	3 to 8
MEDIUM DENSE	10 to 30	8 to 24
DENSE	30 to 50	24 to 40
VERY DENSE	GREATER THAN 50	GREATER THAN 40
SILTS AND CLAYS	SPT N-VALUE	SPT N-VALUE
CONSISTENCY	(BLOWS/FT.)	(BLOWS/FT.)
VERY SOFT	LESS THAN 2	LESS THAN 1
SOFT	2 to 4	1 to 3
FIRM	4 to 8	3 to 6
STIFF	8 to 15	6 to 12
VERY STIFF	16 to 30	12 to 24
HARD	GREATER THAN 30	GREATER THAN 24
LIMESTONE	SPT N-VALUE	SPT N-VALUE
CONSISTENCY	(BLOWS/FT.)	(BLOWS/FT.)
SOFT	LESS THAN 20	LESS THAN 17
MEDIUM	20 to 50	17 to 41
HARD	51 to 50/3"	42 to 50/6"
VERY HARD	GREATER THAN 50/3"	GREATER THAN 50/6"

## Report of Core Borings

		REVISIONS		PREPARED BY:		NAM	E DATE	PROJECT NAME	PROJECT NO.	SH
	DATE	DESCRIPTIONS APP	ROVED	<b>A</b>	DESIGNED BY:	BRH	04/2019	E. Columbus DrCity of Tampa Walk\Bike		$\top$
4				ADELINIA E : : :	DRAWN BY:	BRH	04/2019	, ,	D 40 000 00	1
+				AREHNA Engineering, Inc.	CHECKED BY:	KL	04/2019	From North Nebraska to 14th Street	B-18-092.02	1
+	-			Phone 813.944.3464 Fax 813.944.4959 Certificate of Authorization No. 28410	SUPERVISED BY	: Krist	ina LaCava, P.E	Tampa, Florida		

#### INDEX OF ROADWAY PLANS

SHEET NO	SHEET DESCRIPTION
u	COVER SHEET
L2	PLANTING PLAN 1
L3	PLANTING PLAN 2
L4	PLANTING PLAN 3
L5	PLANTING PLAN 4
L6	PLANTING PLAN 5
L7	GENERAL LANDSCAPE NOTES 1
L8	GENERAL LANDSCAPE NOTES 2
L9	GENERAL NOTES AND PAY ITEM NOTES
L10	LANDSCAPE TABULATIONS
L11	PLANTING DETAILS
L12	TREE WELL DETAILS 1
L13	TREE WELL DETAILS 2
L14	TREE GRATE DETAILS
L15	BRICK PAVER DETAILS
L16	LANDSCAPE MAINTENANCE NOTES

# STATE OF FLORIDA CITY OF TAMPA

## WALK-BIKE LAP PROJECT LANDSCAPE PLANS

FINANCIAL PROJECT ID 436639-1-58-01
CITY PROJECT NO. 1001221
HILLSBOROUGH COUNTY

COLUMBUS DRIVE FROM EAST OF NEBRASKA AVE. (STA 110+33.87)
TO EAST OF N. 14TH STREET (STA 124+61.33)



THIS ITEM HAS BEEN DIGITALLY SIGNED AND SEALED BY:

#### Jonathan H Toner 2020.05.19 11:58:33 -04'00'

ON THE DATE ADJACENT TO THE SEAL.
PRINTED COPIES OF THIS DOCUMENT ARE
NOT CONSIDERED SIGNED AND SEALED
AND THE SIGNATURE MUST BE VERIFIED
ON ANY ELECTRONIC COPIES

LOCATION OF PROJECT

CONSTRUCTION PLANS APRIL 2020

## LANDSCAPE PLANS LANDSCAPE ARCHITECT OF RECORD:


JONATHAN H. TONER, RLA LIC# FL0001123 TERRA TECTONICS DESIGN GROUP, INC. 1188 KAPP DRIVE CLEARWATER, FLORIDA 33765 CERTIFICATE OF AUTHORIZATION: #254


#### PROJECT MANAGER:


NINA MABILLEAU, E.I.
City of Tampa Transportation and Stormwater Services


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YEAR	NO.
21	L1


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- The work includes soil preparation, finish grading, supplying and planting of trees, shrubs, groundcovers and sod, of the species, sizes and quality as shown on the drawings and/or as specified herein.
- 3. Provided plant material to be graded Florida No.1 or better as outlined under the 2015 Grades and Standards for Nursery Plants, Parts I and II, State of Florida, Department of Agriculture, and to conform to AAN Standards for Nursery Stock (ANSI 260.1-1980).
- 4. Provide any necessary truck watering to maintain the plant materials in a Florida No.1 condition, according to the 2015 Florida Nursery Grades and Standards.
- Provide a Lump Sum Price for truck watering with potable water, as needed. The pricing is to be for potable quality water as Reclaimed water not acceptable for this project.
- 6. Verify all utility locations (existing and proposed), related paving, elevations, water and electrical supply, etc. prior to start of work and excavations. Notify City of Tampa Construction Representative in writing of unsatisfactory conditions prior to start of work. Start of work will indicate acceptance of conditions and full responsibility for completed work.
- 7. Provide sole responsibility for any and all damages that result from activities due to improper verification of utilities and/or operator error during excavations. Coordinate on-site with the City of Tampa Construction representative before digging or commencement of any work.
- 8. Project Site to be clear of debris and weed growth before any plantings to commence. If weed growth is still present and viable, re-spray with herbicide and wait the required time period, according to manufacturer's instructions.
- 9. Required erosion control measures to remain intact throughout construction. Proposed storm water runoff for the street trees and palms to be directed to the Tree Well areas by way of the roadway inlets and any surface grading within the project. Do not place silt barriers or other blockage devices between the street run-off and the tree wells, after the trees are installed.
- 10. Notify the City of Tampa Construction Representative of site conditions which may require planting design adjustments. Submit proposed changes for written approval to City of Tampa & Landscape Architect, prior to the installation of plant materials.
- 11. Planting Limits refer to FDOT Standard Index 700 and are based on project design speed and median applications for this project, which is based on <30mph.</p>
  Outside roadways: Locate trees no less than 4 feet from face of curb in accordance with Design
- 12. Structured soils as shown on the plan consist of the following: (see specifications)
  - a. STRUCTURED SOIL:

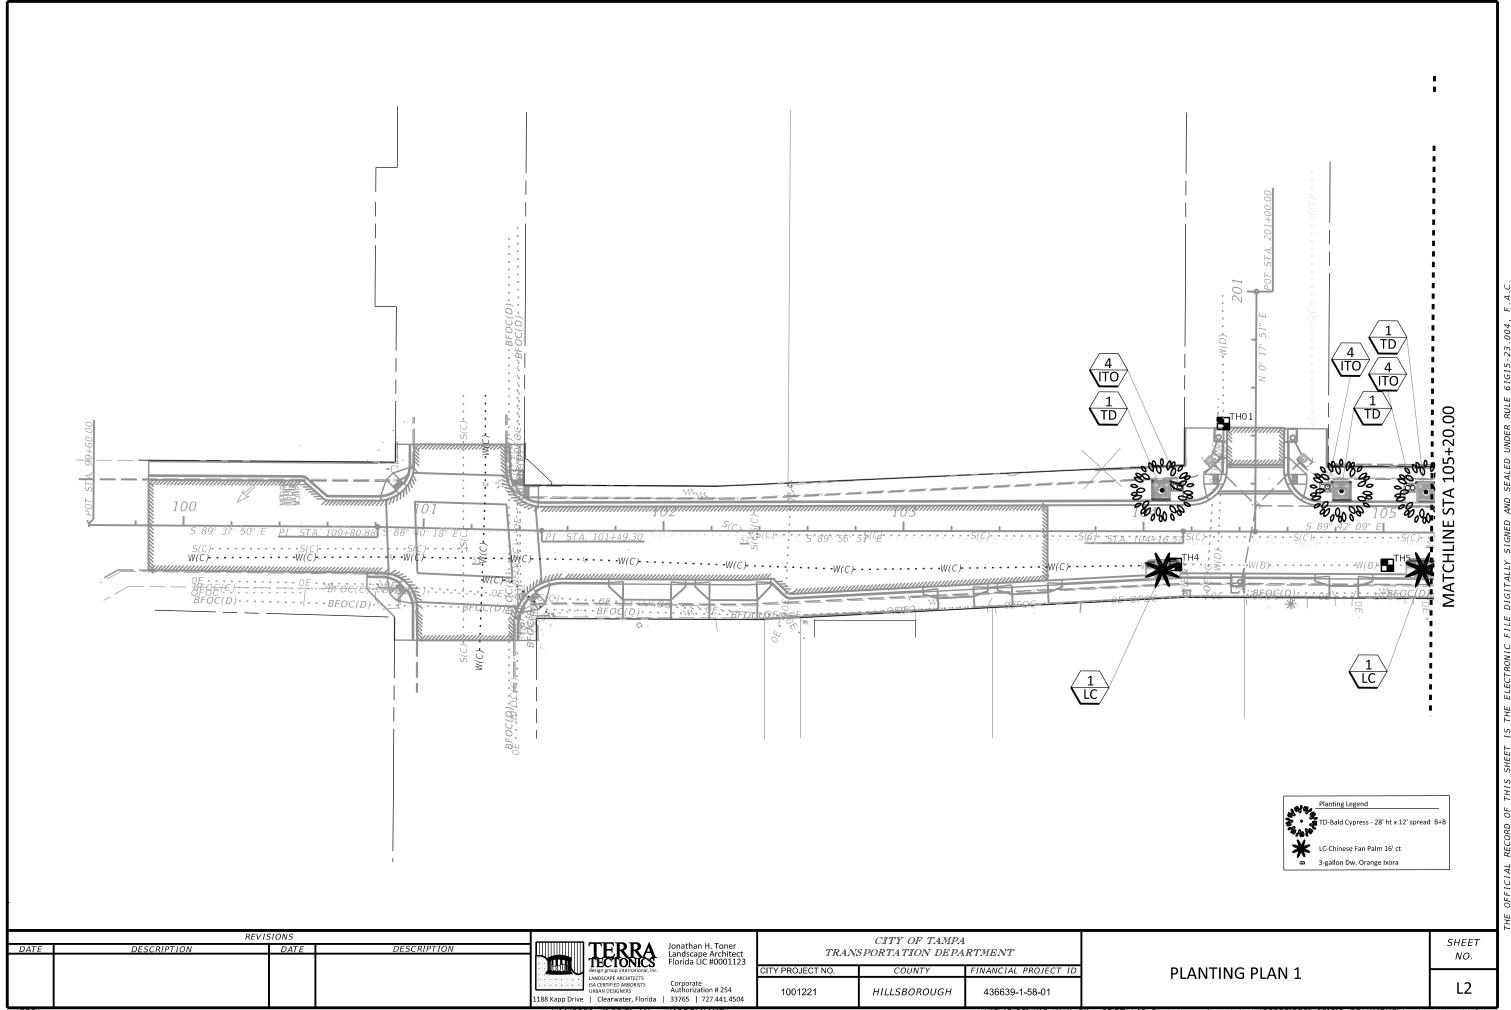Standard Index 546

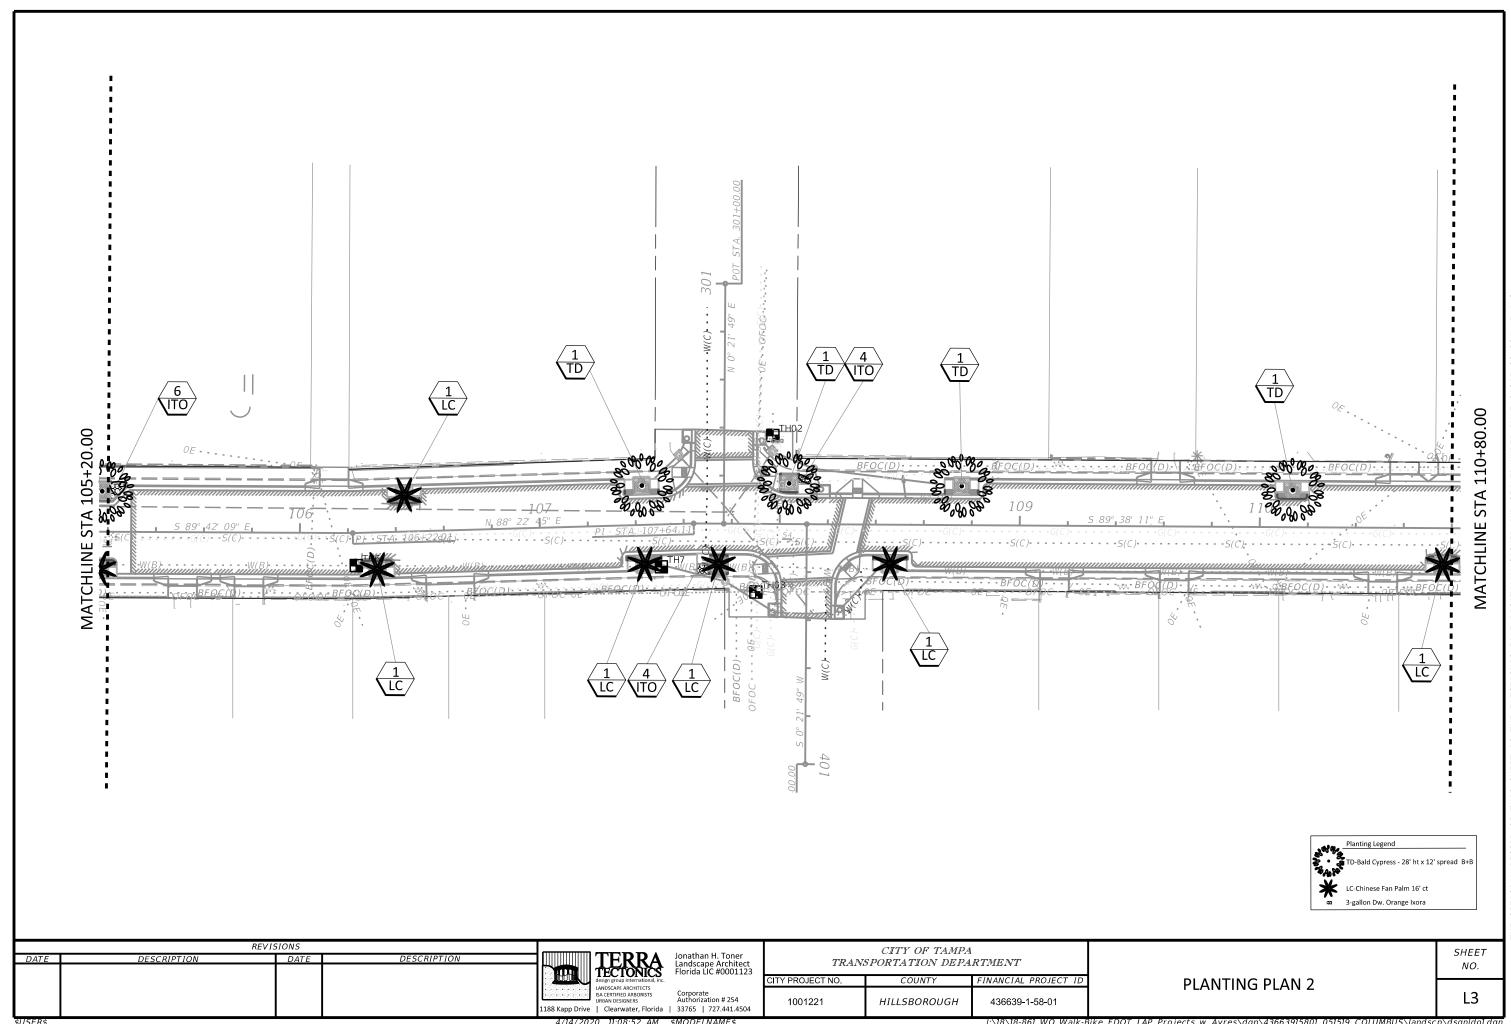- i. 35% #57 Aggregate- consisting of washed crushed concrete or crushed granite.
   Crushed Limestone will not be acceptable.
- ii. 35% White Builders sand
- iii. 30% Organic Topsoil
- 13. All trees to be single trunked and cleared to a height of a min of 8.5' above finished grade of tree wells and sidewalks. See FDOT index 700 and FDOT Index 546.
- 14. If containers are used, then container size is to be as specified. A minimum of 80% of the container root ball must contain active and viable root system. Girdling or "ring" roots are prohibited and will be cause for rejection of plant material. See notes and details for root observations and corrective actions. Be responsible to demonstrate the root ball conditions of the plan materials while the plantings are either on the truck at time of delivery or in-field, to Landscape Architect to illustrate root conditions of the plant materials. Any root ball or container planted materials that cannot be corrected in field to be rejected and will need to be replaced at contractors' expense.
- 15. No substitutions will be made without the explicit written permission of the City of Tampa Construction Representative. Submit written verification of any plant material(s) that may be unavailable as specified during the bid process, to the City of Tampa Construction Representative.

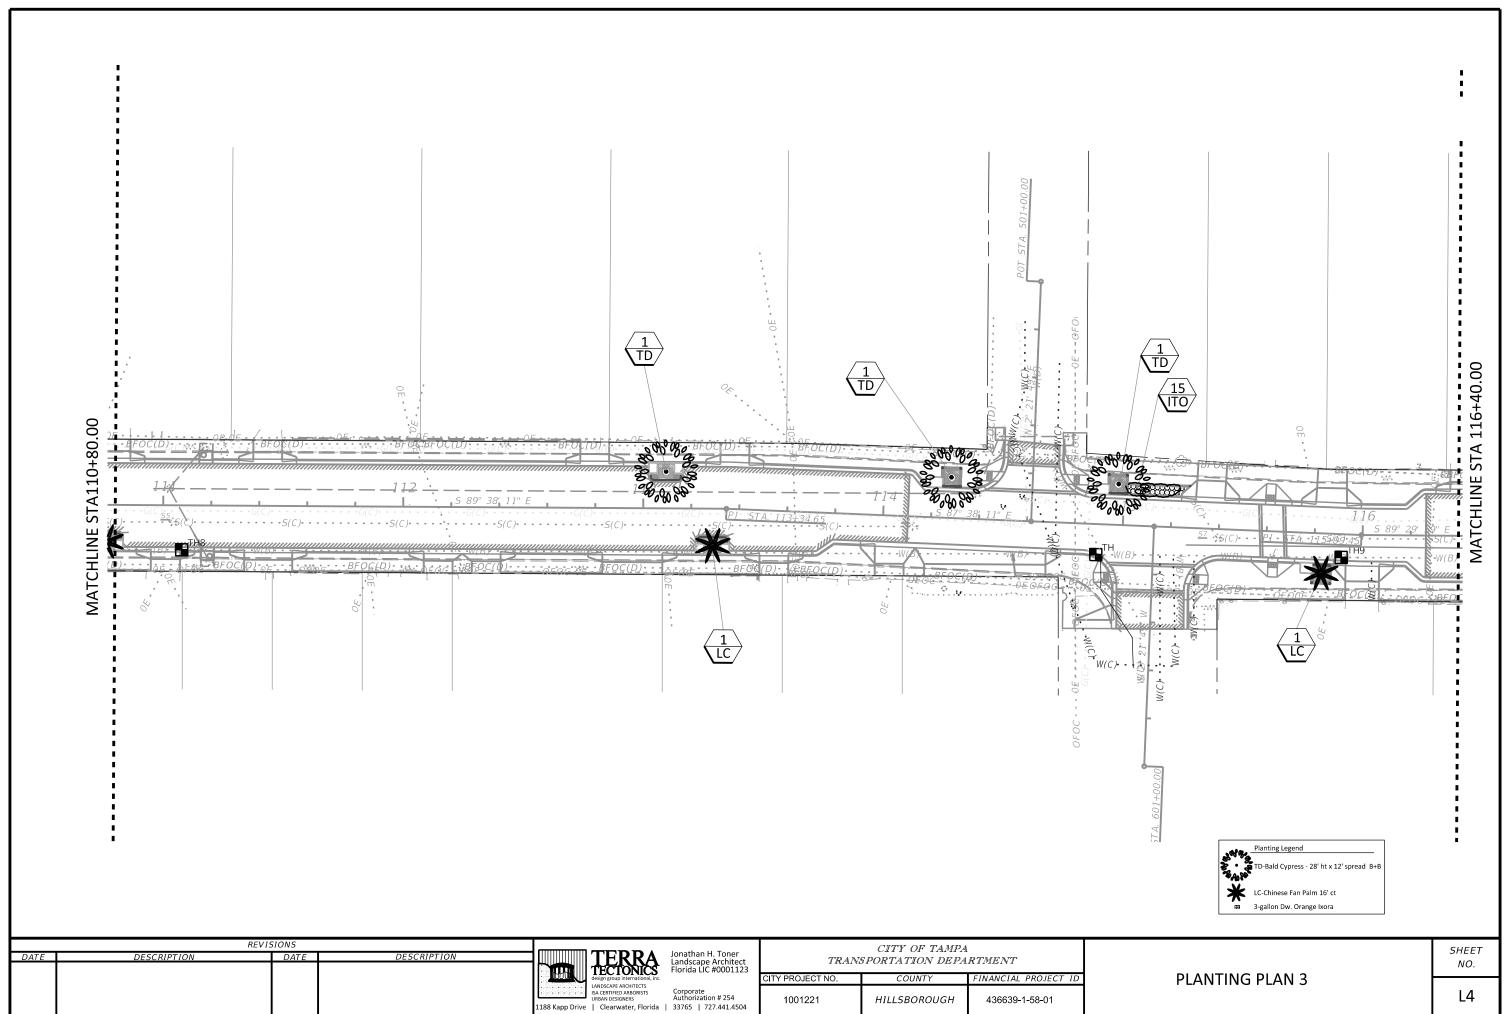- 16. Landscape Architect of Record to review, before any delivery to the construction site, all proposed trees, shrubs and ground cover materials, by means of accurate and representative photographs taken from nursery of the grower of the materials, that will be delivered to job site. Submittal to be in an electronic e-mail format sent to City of Tampa Construction representative. The project name and location to be labeled on the front of each e-mail, with the Contractor's name, address and phone number listed on the inside first page with the index of photographs.
- 17. The City of Tampa Construction Representative reserves the right to make minor adjustments, in the field, to the locations of trees, palms, shrubs and groundcovers. Do not remove vegetation by grubbing or place soil deposits, debris, solvents, concrete, paint, chemicals or other foreign substance in or on the soil. Required tree barricades and erosion control measures to remain intact during construction. No construction debris, construction materials, machinery or equipment of any kind placed within the dripline of a tree to remain on the site. All areas within the dripline of a protected tree to be maintained at their original grade with no trenching of cutting of any kind.
- 18. In the event of a variation between the plant list and the actual number of plants shown or noted on the plans, the plans to control. City of Tampa Construction Representative to be notified of any discrepancy during bid process in writing, with the plans taking precedent over tabulation list.
- 19. Plants and trees to be set plumb, at the same grade at which they have been grown, best side facing prime visibility and thoroughly watered-in at time of planting to eliminate air pockets. If site conditions are unfavorable to vigorous plant growth, the City of Tampa Construction Representative to be notified prior to submitting bid and commencing construction. The conditions are considered accepted, if written notification is not received by City of Tampa Construction Representative before commencement of installation of the materials.
- 20. Provide proper drainage for all trees and plant materials. Trees set too high or low may be rejected. Verify proposed finish grades and set trees accordingly. See details for planting, staking and guying.
- 21. Properly securing all trees, palms and large shrubs immediately after planting. Tree bracing to be performed by the detail shown on plans for bracing the rootball within the Tree Well. No external guy wires will be permitted.
- 22. Shrubs to be planted as shown on plans. Trees and palms to be backfilled with Structured Soils, as specified and shown in locations on plans and details. Remove container and all synthetic bindings from trees and palms, Upon installation of Trees and Palms in Tree Wells, a blanket of #57 stone (washed crushed concrete or granite not limestone) and wrapped on all sides with Mirifi 140 fabric 4" deep to be laid over the rootball for erosion control as shown on details.
- 23. Provide a 12-month Warranty, from date of Final Acceptance, for all plantings as part of this contract. Dead plantings to be replaced within 30 days of the time they have perished.
- 24. Maintain the watering required for the establishment of plant materials from the date of installation to the date of the Final Acceptance. The cost of watering and its application to be borne by contractor until Final Acceptance by City of Tampa.
- 25. Replace all Plant Materials that are in a deteriorated and/or perished Condition or that have perished within the 12-month warranty period. Monthly inspections are required to be performed to determine deficiencies and perished items to be replaced on a Monthly basis, as needed.
- 26. Trees, Palms or shrubs shown in a line on the plan to have the trunks/canopies in proper alignment upon visual inspection after installation. Groundcover and shrub beds to be planted on triangular spacing with plants installed and faced for optimum growth into the bed.
- 27. Any areas subject to erosion (e.g. grass swales, retention area embankments) must be stabilized by solid Bahia sod.
- 28. The job site to be kept orderly and reasonably clean on a daily basis during construction operations. Upon daily completion of work, remove all debris and waste generated by operations on-site, including the cleaning of walks and paving.
- 29. The maintenance period for plantings begins at time of installation and continues until end of 12-Month Warranty period.

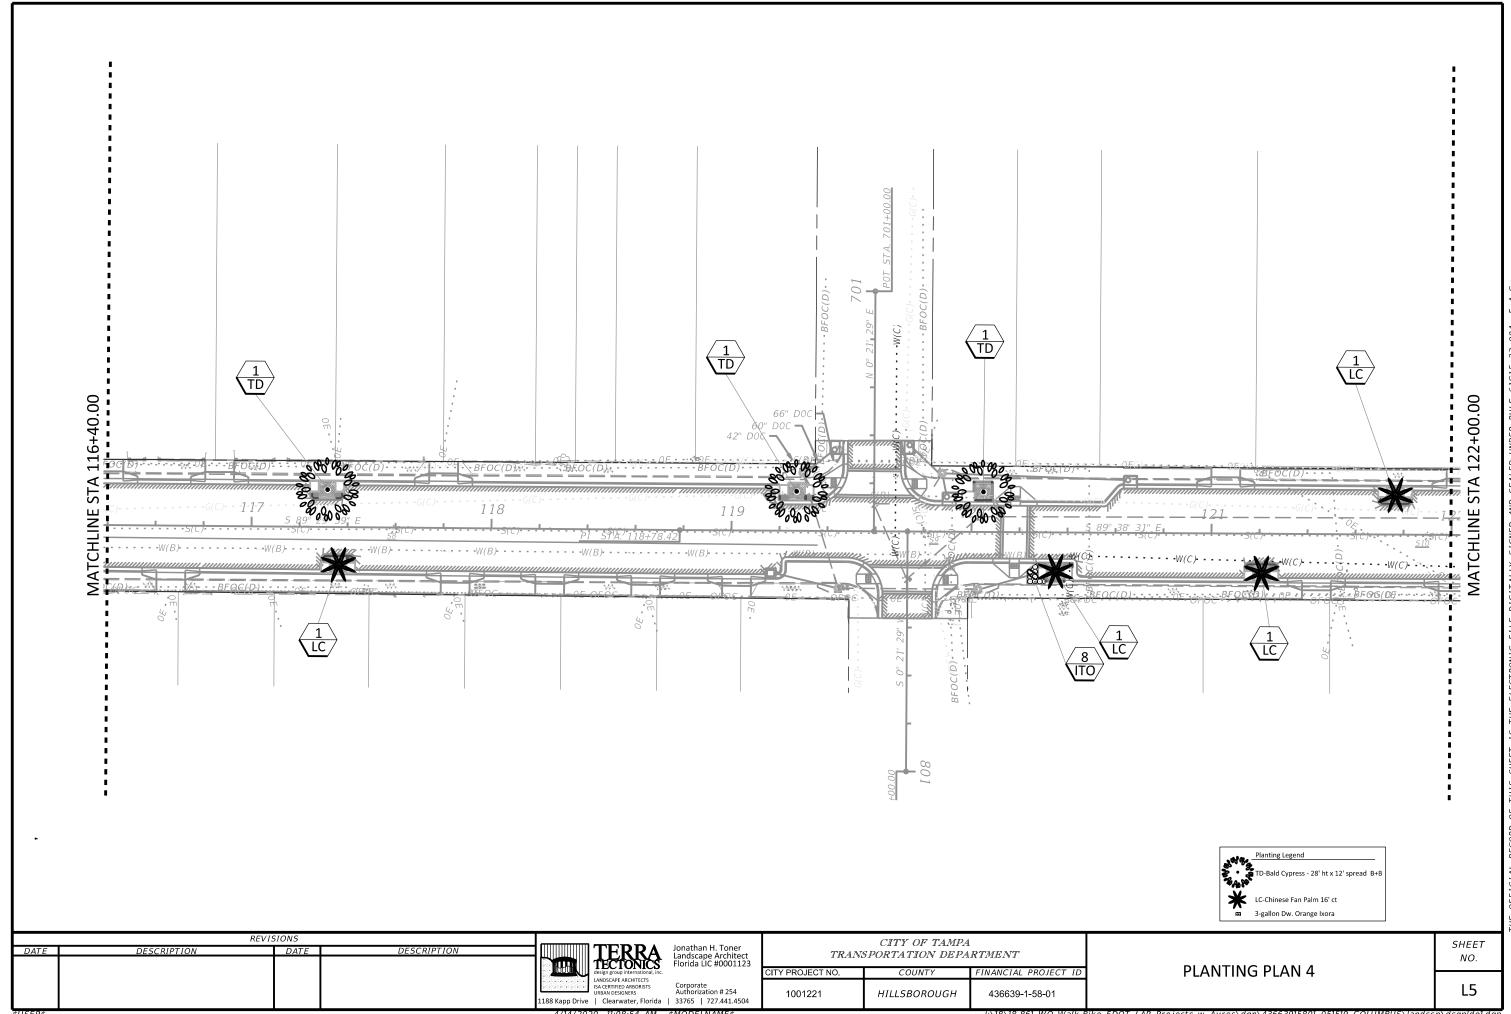REVISIONS

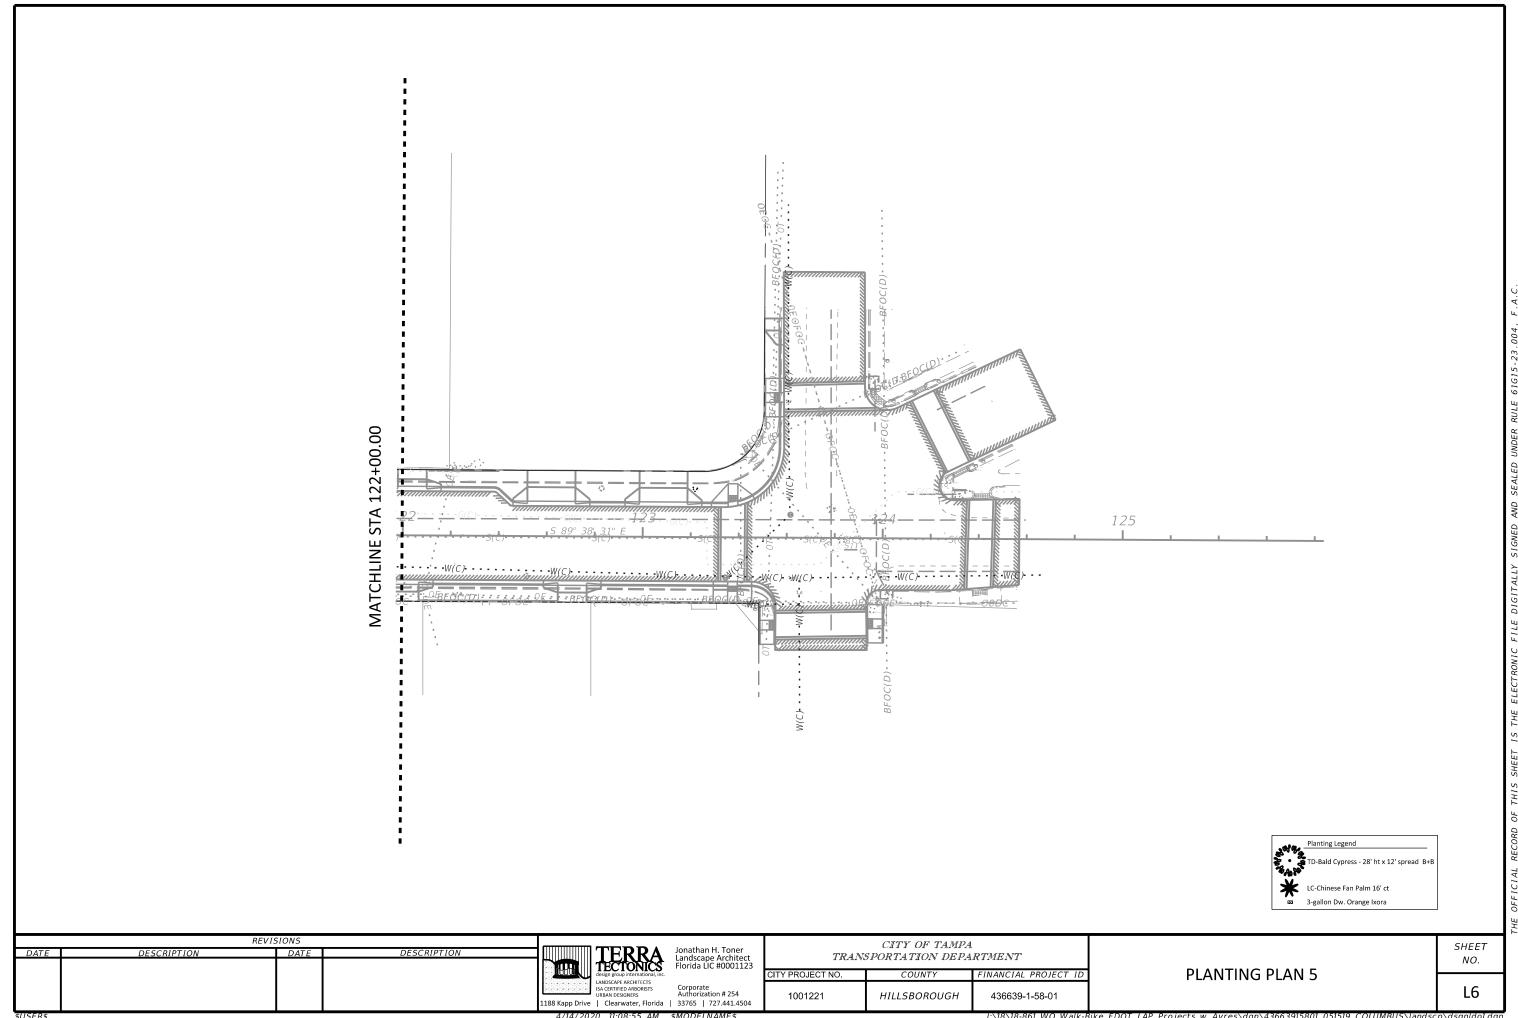DESCRIPTION

DESCRIPTION

DESCRIPTION

TERRA
design group international, inc.
LANDSCAPE ARCHITECT
LANDSCAPE ARCHITECT
SUBBAN DESIGNERS
URBAN DESIGNERS
1188 Kann Drive | Cearmater Florida | 33765 | 727 441 4504

GENERAL LANDSCAPE NOTES 1

SHEET NO.

L7

¢EII E d

\$DATE\$ \$TIME\$ \$MODELNAME\$

- 30. Provide clearly delineated electronic prepared As-Built PDF drawings of landscape and irrigation, to the City of Tampa Construction representative at end of project. This consists of representations of quantities and locations all planted palms, trees, shrubs, groundcovers and turf areas prior to final acceptance. Any and all deviations from the original construction documents to be duly and accurately recorded. A PDF of the Final Construction Plans to be the basis for the As-Builts mark-ups. Upon completion, deliver to City of Tampa Construction representative. Hand marked plans will not be acceptable.
- 31. An "As-Built" of the landscape plans to be provided by the contractor and signed and sealed by a Landscape Architect Registered in the State of Florida. The Landscape Architect to be obtained by the Contractor. Submit to the City of Tampa Construction Representative prior to the final walk-through and Final Acceptance. The "As-Built" to be up-dated daily and to be kept on-site at all times during the construction period.
- 32. At the time of Final Acceptance, provide the City of Tampa Construction Representative, with a maintenance manual containing instructions for the proper care of all materials specific to the job, and any pertinent manufacturer's literature.
- 33. All landscape material to be installed and maintained at all times in a manner whereby traffic control signage and devices are visible to motorists and pedestrians.
- 34. No work to be performed on City Holidays
- 35. All Landscape material to be maintained in accordance with FDOT Standard indices 546 and 700 and all other applicable Department standards and regulations.

  <a href="http://www.dot.state.fl.us/rddesign/DS/15/STDs.shtm">http://www.dot.state.fl.us/rddesign/DS/15/STDs.shtm</a>
- 36. Application of herbicides to be performed by a person possessing a current Florida Restricted Use Pesticide License in the Core Curriculum, Right-of-way and Aquatic Categories.
- 37. Pursuant to section 2.10 of the departments "Roadway and Roadside Maintenance" Procedure (topic No. 850-000-015-I of 91/01/2014), all individuals who contract the application of fertilizer to ensure that they are licensed commercial applicators who have been trained through the Green Industry BMP Program, and have obtained a limited certification for Urban commercial fertilizer application under Section 482.1562, F.S. Furnish the City of Tampa Construction representative, current copies of licenses/certifications belonging to the personnel that will be involved in the application of fertilizer on the Hillsborough County right of way prior to start of work.

	REVIS	IONS					CITY OF TAMPA	
DATE	DESCRIPTION	DATE	DESCRIPTION	TERRA TECTONICS	Jonathan H. Toner Landscape Architect Florida LIC #0001123	TRANS	SPORTATION DEPA	
				design group international, inc.		CITY PROJECT NO.	COUNTY	FINANCIAL PROJECT ID
				LANDSCAPE ARCHITECTS ISA CERTIFIED ARBORISTS URBAN DESIGNERS  1188 Kapp Drive   Clearwater, Florida	Corporate Authorization # 254   33765   727.441.4504	1001221	HILLSBOROUGH	436639-1-58-01

**GENERAL LANDSCAPE NOTES 2** 

SHEET NO.

L8

#### **GENERAL NOTES:**

- 1. Roadway Design Speed is **30 MPH**. Criteria for a **30 MPH** design speed for **COLUMBUS AVENUE STREETSCAPE PROJECT** was the basis for the design setbacks criteria for this project.
- 2. Project limits are from Nebraska Avenue to the west and 14<sup>th</sup> street to the east, as shown on plan. These have been used in order to establish Landscaping Clear Zones for the median plantings, for the roadway for the project.
- 3. Standard Indexes 613, 616 and 619 will be used for the Maintenance of Traffic for landscaping work as well as the FDOT 2019 Design Standards.
- 4. Criteria based on the FDOT 2019 Plans Preparation Manual and the 2007 AASHTO "Green Book".
- 5. In accordance with Rule 14.40.003(3)(b), Florida Administrative Code, no planting is allowed which screens, or when mature will screen an outdoor advertising sign permitted under Chapter 479 F.S. billboard noticed have been issued to billboard owners by certified letter.
- 6. No vegetation to be placed in a manner whereby official departmental traffic control signing would be discerned as being screened.
- 7. All applicable departmental Maintenance of Traffic standards to be utilized at all times while construction and maintenance activities are being performed as a result of this project.
- 8. A minimum vertical clearance of 14.5' between the grade of roadway and the bottom canopy of foliage to be maintained at all times.

#### **PAY ITEM NOTES:**

#### **EXISTING LANDSCAPE**

All existing landscape to remain in place unless specified on the plans. Patch existing sod in areas disturbed by construction with utilizing the existing sod type, after construction is completed.

#### **CLEARING AND GRUBBING**

Where plant beds, trees and palms are installed in sodded areas or areas with other plant growth, existing plants to be removed, and the plant bed prepared to meet the requirements below before planting. Existing sod to be treated with herbicide and follow manufacturer's directions for the appropriate waiting period to confirm the sod is dead, before continuing construction of the landscape. The plant beds to be marked, and the sod removed within the plant beds areas. Project site to be free of shrub/tree/palm paper, boards, chips, sticks, trash, or any other undesirable material. There to be no exotic or noxious weeds or weed seeds (i.e. Nut grass, Bermuda grass, Sedges and the like). In no case to there be more than 5% by volume of stones, limestone, asphalt waste to pay items ratio. Where plant beds, trees and palms are installed in sodded areas or areas with other plant growth, existing plants to be removed, and the plant bed prepared to meet the requirements below before planting. with the peanut. Plant beds to have Bahia sod removed in its entirety to a depth of 3" before planting any of the shrub and ground cover materials.

#### STRUCTURED SOILS

As shown on plans, backfill around the Tree Wells to be with Structured Soils. Contractor to submit sample of structured soils in 1 gal Ziplock bag along with applicable soil analysis, for approval by City of Tampa Construction Representative, before delivery to site.

Structured sols shall consist of the following: Crushed Granite or washed Crushed Concrete Aggregate 35%, White Builders Sand 35% & Organic Topsoil 30%

#### PREPARED SOIL LAYER 3" DEPTH

All shrub planting pits to be supplemented with 3" of Prepared Planting Soils for each plant item during installation. See Specifications for Prepared Planting Soils. Maximum Soluble Salts: 200 ppm. Contractor to submit sample and soil analysis, for approval by City of Tampa Construction Representative, before delivery to site.

#### IRRIGATION

The Contractor to provide a Lump Sum Price for Truck watering as needed for watering the landscape shown on plans.

Supplemental watering may be needed during the establishment period, to be provided in the form of truck watering. MOT practices to be employed during truck watering practices. Inform City of Tampa Construction Representative before performing truck watering. The entire 12-month Warranty Period will require plant watering, as needed. Watering timing shall be determined by the need to keep plant materials in no less than a Florida #1 condition. Any plant materials that suffer or perish due to over or under watering will need to be replaced. Truck watering, if used, to comply with potable water standards and not be reclaimed water. Truck water costs to be the responsibility of the Contractor and shall be shown in a Lump Sum price. Watering shall be for the duration of the project, until the end of the 12-month Warranty period.

#### PRE-EMERGENT ON PREPARED SOIL LAYER

Prior to mulching, the proposed plant beds indicated on plans, to be treated with granular Pre-Emergent Herbicide containing 1% Benefin and 1% Oryzalyn. Apply granular herbicide per manufacturer's directions. Use a properly calibrated granular applicator and do not apply chemical directly onto leaves of plants. Applicator to be licensed by State of Florida and trained for proper application.

#### **LANDSCAPE COMPLETE - B+B Plant Materials**

The B+B (Balled + Burlapped) plant materials to be field grown, hardened-off a minimum of 90 days before delivery to job site and to be balled and burlapped and of sizes according to the 2015 Florida Grade and Standards for Nursery Plants. All other material under this pay item number is to be container grown.

#### LANDSCAPE QUALITY STANDARD

All Plant materials to be delivered to the site in a 'Florida No.1' condition, according to the 2015 Florida Grades and Standards for Nursery Plants. Root ball, canopy spread, overall height as well as caliper inches, to comply with 'Florida No.1' requirements.

#### TREE PLACEMENT

Adjust trees and palms to be placed as far from utilities as possible with the 811 locator.

#### LANDSCAPE COMPLETE - STAKING AND GUYING

Staking and Guying to be included in the cost of the plant material. Staking and guying to be per the details shown on plans. Staking and Guying to be maintained throughout the one-year warranty period, and to be removed at the end of the one-year Warranty period at Contractors expense.

#### LANDSCAPE COMPLETE - MULCH - WOOD CHIPS

All new shrub beds to be mulched with 3" depth of either Pine Bark-Mini-Nuggets (1-1/2-3" pieces) or "Enviro-mulch" mulch material. Cypress mulch will not be allowed on the job site. Planting quantities do not include mulch in shrub beds or tree/palm beds and individual trees/palms. The mulch to be free of other vegetative yard waste, plastic, glass, metal, palm trees, sand and other foreign materials. The mulch to have the consistency of appearance. The mulch to be certified to be sterile and free from viable weed and grass seed. Submit samples in 1-gallon Ziplocs bags to Project Tampa Construction Representative, for approval before delivery to site.

#### LANDSCAPE COMPLETE - 12 MONTH MAINTENANCE & WARRANTY PERIOD

There will be a Landscape Establishment and Maintenance period of 12-Months after Final Acceptance, included in the contract pricing from Contractors during bidding, for the items shown in the project specifications. The date of Final Acceptance will be determined by City of Tampa Project Representative and will be based on the contract being fully and satisfactorily executed to the requirements of the plans and specifications. All plant materials to be maintained in a Florida #1 Condition. Any plant materials not found to be in this condition to be replaced, including materials and labor, at the end of every calendar month, from date of Final Acceptance until 12 months from the date of Final Acceptance.

#### MAINTENANCE AFTER COMPLETION

All landscape maintenance after completion of 12-month Warranty period, shall be the responsibility of Hillsborough County.

	REVIS	IONS					CITY OF TAMPA	
ATE	DESCRIPTION	DATE	DESCRIPTION	TERRA TECTONICS	Jonathan H. Toner Landscape Architect Florida LIC #0001123	TRANS	PORTATION DEPA	
				design group international, inc.		CITY PROJECT NO.	COUNTY	FINANCIAL PROJECT ID
				LANDSCAPE ARCHITECTS ISA CERTIFIED ARBORISTS URBAN DESIGNERS  1188 Kapp Drive   Clearwater, Florida	Corporate Authorization # 254 33765   727.441.4504	1001221	HILLSBOROUGH	436639-1-58-01

\$DATE\$ \$TIME\$

GENERAL NOTES & PAY ITEM NOTES

SHEET NO.

L9

## **COLUMBUS DRIVE WALK/BIKE PROJECT**

LANDSCAPE TABULATIONS

100% SUBMITTAL

PLANTINGS:				PLAN	PLAN	PLAN	PLAN	PLAN	
		Container		1	2	3	4	5	
SYM COMMON NAME	BOTANICAL NAME	size	SPECIFICATION						TOTAL
LARGE TREES AND PALMS:									
LC * Chinese Fan Palm- *FURNISH AND INSTALL *	LIVISTONA chinensis	B+B	16' CT. to frond base. Min 18" caliper	2	6	2	4	0	14
			26' ht' 10' spread, 9' ct 8" caliper B+B max 72"						
TD * Bald Cypress *FURNISH AND INSTALL*	TAXODIUM distichum	B+B	rootball-max 42" depth	3	4	3	3	0	13
LC ** Chinese Fan Palm - INSTALL ONLY	LIVISTONA chinensis	В+В	16' CT. to frond base. Min 18" caliper	2	6	2	4	0	14
			26' ht' 10' spread, 9' ct 8" caliper B+B max 72"						
TD ** Bald Cypress - INSTALL ONLY	TAXODIUM distichum	B+B	rootball-max 42" depth	3	4	3	3	0	13
Small shrubs and ground covers:									
ITO Dw Orange Ixora	IXORA taiwanensis' Orange'	3 gallon	18" ht x 12" spread	12	14	15	8	0	49
Site work soils and mulch									
City of TAMPA BRICK BLOCK PAVERS	SEE PLANS FOR DETAILS	SF	USE COT STOCKPILE	150	300	150	210	0	810
6' SQ X 2" - FABRIC WRAPPED #57 STONE MATT					' I	<b></b>			
FOR ROOTBALL	SEE PLANS FOR DETAILS	EA	Crush Granite or Crushed concrete	5	10	5	7	0	27
TREE GRATE TREE BRACING	SEE PLANS FOR DETAILS	EA	Aluminum angle - see details	5	10	5	7	0	27
TREE GRATE 16" dia opening	FOR PALMS	EA	Cast Iron #8718a	2	6	2	4	0	14
TREE GRATE 36" dia opening	FOR CYPRESS TREES	EA	Cast Iron #8718	3	4	3	3	0	13
TREE GRATE FRAMES	SEE PLANS FOR DETAILS	EA	cast into tree well structure	3	4	3	3	0	13
			TO MATCH TREE GRATE - Assemble in-field to						
TREE GUARDS Type E	FOR ALL CYPRESS TREE LOCATIONS	EA	tree grate - for 36" dia opening	3	4	3	3	0	13
	PREPARED STRUCTURAL SOILS -SEE								
STRUCTURAL SOILS	SPECIFICATIONS	cu yard		45	90	45	63		243
PREPARED PLANTING SOILS	SEE SPECIFICATIONS	cu yard		0.7	0.8	0.8	0.4	0.0	2.7
PINE BARK MULCH	3" -SEE PLANS FOR LOCATIONS	cu yard		0.6	0.6	0.7	0.4	0.0	2.3
THE SAME MODEL	for watering of all plant materials as	- ca yara		0.0	0.0	0.7	0.1	0.0	
1 YEAR OF TRUCK WATERING AS NEEDED	needed	LS	Until end of 12-month Warranty period						1
			action representative before delivery to project si	te.					
* Trees shall be dug and root pruned and hardene									
			ry to assure trees will be available for project at ti	me of tree nla	cement				

Price shall be for install of previously purchased and tagged Palm and Tree materials only. Pickup from nursery, install and provide bracing, soils, fertilizers as specified. Coodinate with City of Tampa Construction Representative

REVISIONS


	TERRA TECTONICS design group international, inc.	Jonathan H. Toner Landscape Architect Florida LIC #0001123
1188 Kapp Drive	LANDSCAPE ARCHITECTS ISA CERTIFIED ARBORISTS URBAN DESIGNERS   Clearwater, Florida	Corporate Authorization # 254   33765   727.441.4504

Jonathan H. Toner Landscape Architect Florida LIC #0001123


CITY OF TAMPA TRANSPORTATION DEPARTMENT 1001221 HILLSBOROUGH 436639-1-58-01

LANDSCAPE TABULATIONS

SHEET L10

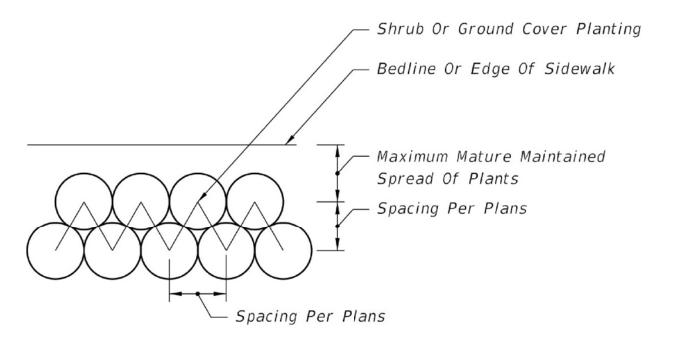

### GROUND COVER/SHRUB LAYOUT DETAIL

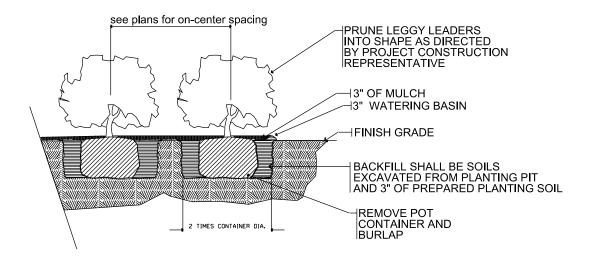


## SHRUB BED PLANTING DETAIL NO SCALE


	REVISIONS						CITY OF TAMPA	
DATE	DESCRIPTION	DATE	DESCRIPTION		Jonathan H. Toner Landscape Architect	TRANS	SPORTATION DEPA	
				TECTONICS	Florida LIC #0001123			
				design group international, inc.  LANDSCAPE ARCHITECTS		CITY PROJECT NO.	COUNTY	FINANCIAL PROJECT ID
				ISA CERTIFIED ARBORISTS URBAN DESIGNERS	Corporate Authorization # 254	1001221	HILLSBOROUGH	436639-1-58-01
				1188 Kapp Drive   Clearwater, Florida	33765   727.441.4504			


PLANTING DETAILS 1

SHEET L11

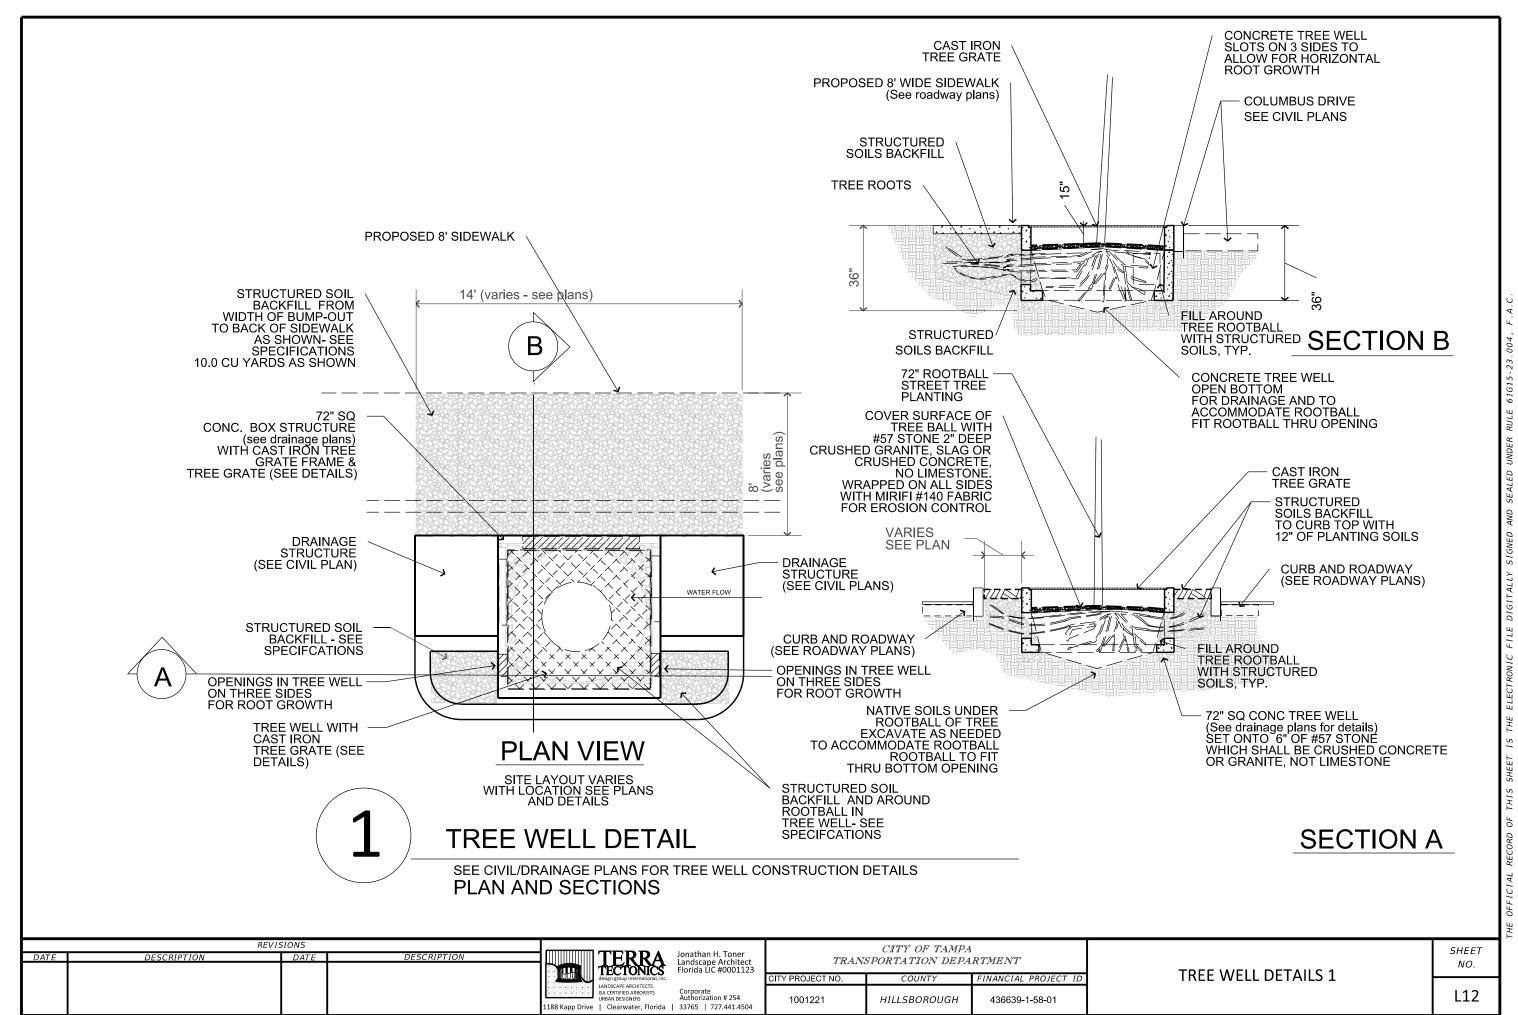

\$FILE\$

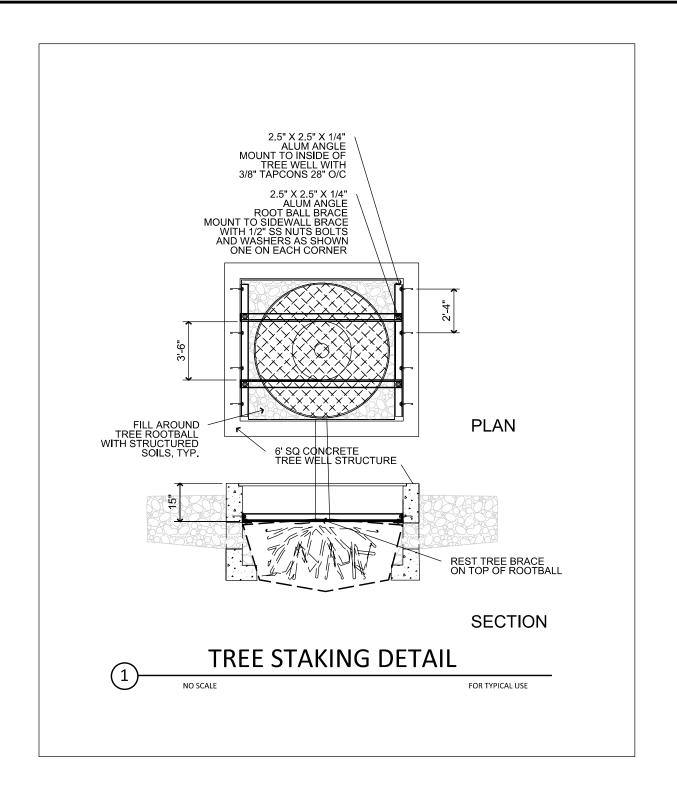

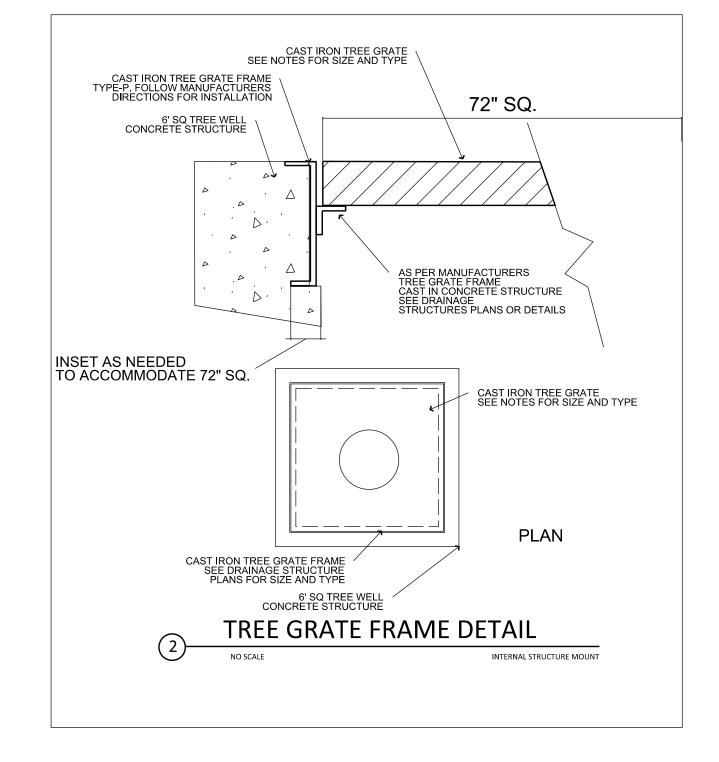

#### TREE GRATE NOTES:

CAST IRON R-8718A -CAST IRON POWDER COATED BLACK - 72" SQ OPENING
 MATCH EXISTING STYLE AND TYPE LOCATED WITHIN YBOR CITY AND APPROVED BY CITY OF TAMPA.


3. TREE GRATE SHALL BE APPROVED IN WRITING FROM CITY OF TAMPA PRIOR TO ORDERING
4. TREE GRATE FRAME SHALL BE CAST INTO TREE WELL STRUCTURE- SEE CIVL PLANS FOR STRUCTURAL DETAILS
5. TREE WELL GRATE FRAME SHALL BE MOUNTED INTO OPENING OF TREE WELL AFTER TREE/PALM IS INSTALLED

6. TREE GUARDS TO BE INSTALLED IN TREE WELLS WITH BALD CYPRESS TREES ONLY.

											_
	REV	ISIONS					CITY OF TAMPA	1		SHEET	1
DATE	DESCRIPTION	DATE	DESCRIPTION	TERRA TECTONICS	Jonathan H. Toner Landscape Architect Florida LIC #0001123	TRAN	SPORTATION DEPA		TREE WELL BETALLS 2	NO.	ı
				design group international, in	с.	CITY PROJECT NO.	COUNTY	FINANCIAL PROJECT ID	TREE WELL DETAILS 2		1
				LANDSCAPE ARCHITECTS ISA CERTIFIED ARBORISTS URBAN DESIGNERS  1188 Kapp Drive   Clearwater, Florida	Corporate Authorization # 254 a   33765   727.441.4504	1001221	HILLSBOROUGH	436639-1-58-01		L13	
\$USER\$				\$DATE\$ \$TIME\$	\$MODELNAME\$	_				\$FILE\$	\$


### **SQUARE**

SERIES NO.	GRATE SIZE	AVAILABLE TREE OPENING SIZES	SLOT SIZE
R-8719	48" x 48"	32" dia.	0.25"
R-8717	60" x 60"	36" dia.	0.25"
R-8717-A	60" x 60"	16" dia.	0.25"
R-8718	72" x 72"	36" dia.	0.25"
R-8718-A	72" x 72"	16" dia.	0.25"

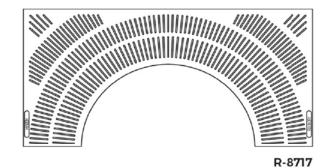

#### **DETAILS**

- · Available with light openings: R-8718, R-8718-A
- $\cdot$  R-8717-A and R-8718-A use reducer grates for smaller tree opening

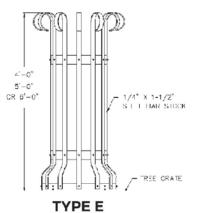

#### SPECIFY WHEN ORDERING:

- 2. Dimension "L" (guard height as measured from top of grate - standard heights are 4', 5' or 6')
- 3. Tree opening diameter
- 4. Paint specifications if different from standard
- 5. Shop drawings for approval

#### TREE GRATE NOTES:

- CAST IRON R-8718A -CAST IRON POWDER COATED BLACK 72" SQ OPENING
   MATCH EXISTING STYLE AND TYPE LOCATED WITHIN YBOR CITY AND APPROVED BY CITY OF TAMPA.
   TREE GRATE SHALL BE APPROVED IN WRITING FROM CITY OF TAMPA PRIOR TO ORDERING


- 4. TREE GRATE FRAME SHALL BE CAST INTO TREE WELL STRUCTURE- SEE CIVL PLANS FOR STRUCTURAL DETAILS
  5. TREE WELL GRATE FRAME SHALL BE MOUNTED INTO OPENING OF TREE WELL AFTER TREE/PALM IS INSTALLED
- 6. TREE GUARDS TO BE INSTALLED IN TREE WELLS WITH BALD CYPRESS TREES ONLY.

ATE	REVIS		DESCRIPTION		Jonathan H. Toner		CITY OF TAMPA	
ATE	DESCRIPTION	DATE	DESCRIPTION	TECTONICS	Landscape Architect Florida LIC #0001123	TRANS	SPORTATION DEPA	RTMENT
				design group international, inc.		CITY PROJECT NO.	COUNTY	FINANCIAL PROJECT ID
				LANDSCAPE ARCHITECTS ISA CERTIFIED ARBORISTS URBAN DESIGNERS 1188 Kapp Drive   Clearwater, Florida	Corporate Authorization # 254   33765   727.441.4504	1001221	HILLSBOROUGH	436639-1-58-01
ER\$				\$DATE\$ \$TIME\$	\$MODELNAME\$			

L14

SHEET NO.

TREE GRATE DETAILS

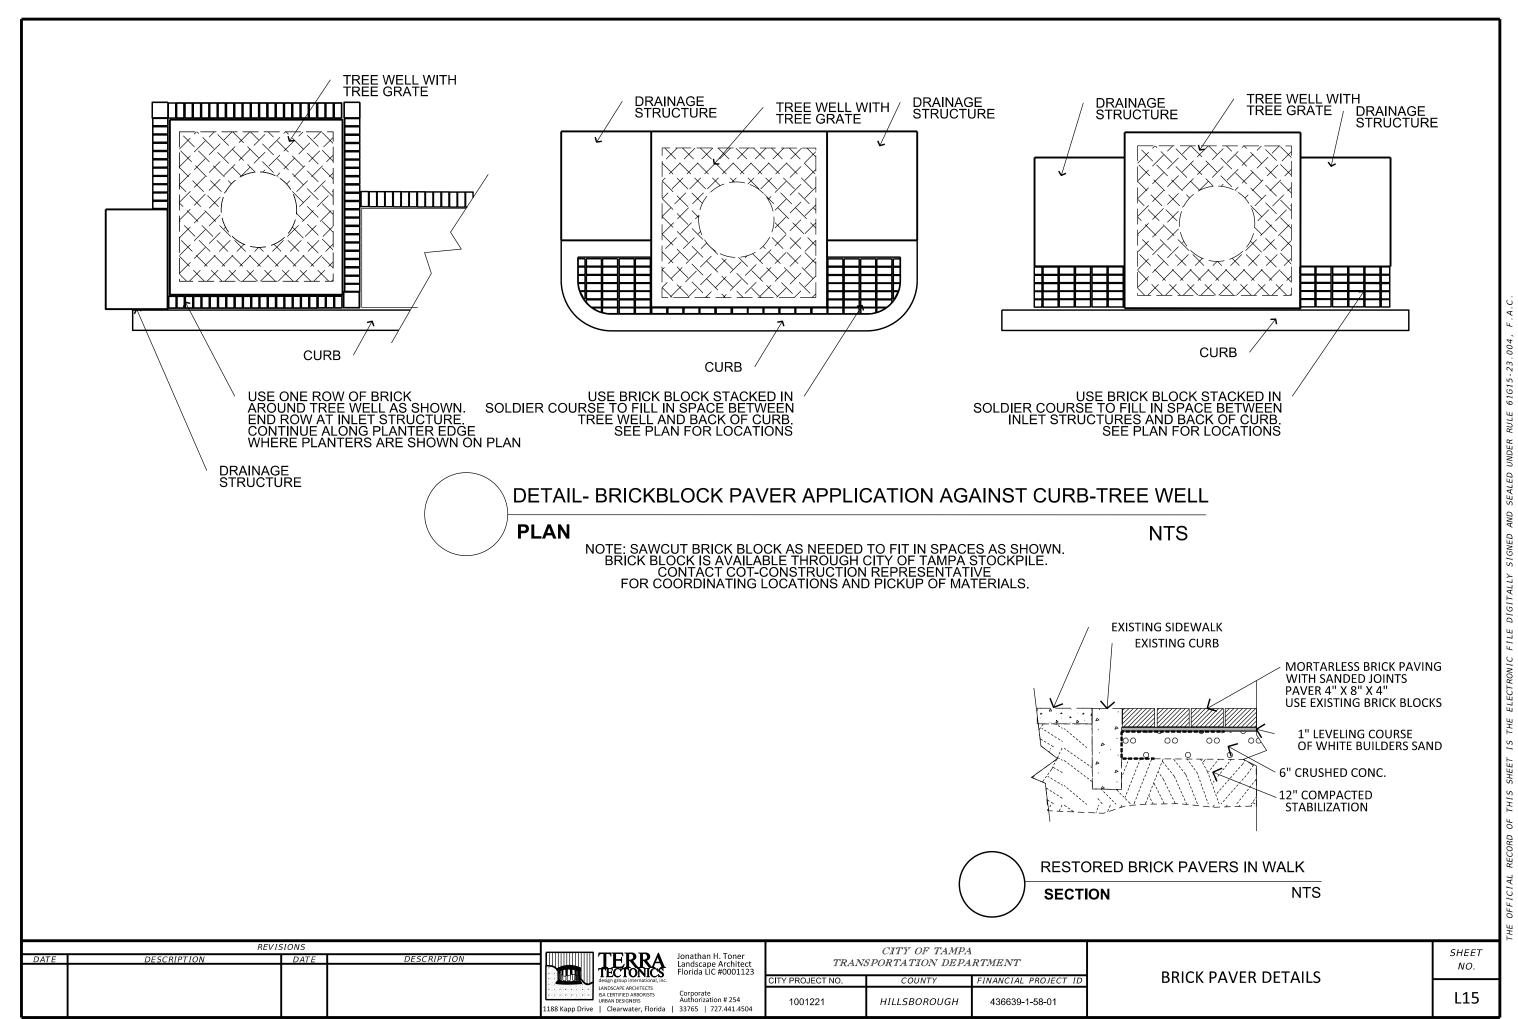

FILE\$

### **Columbus Avenue Streetscape**

### **Streetscape Maintenance Plan Narrative:**

This project will be maintained by Hillsborough County upon the ending of the 12-Month Warranty Period. During the 12-Month Warranty Period, this project will be maintained by Contractor. The project falls within the USDA Zone 9-9A, with minimum temps between 26-32 degrees F, but only every few years. This project is surrounded by mostly residential and some industrial areas. It can be expected that this landscape will be subjected to incoming winter fronts from the NW and then summer daily rain from June to September with a drastic increase during tropical storms and hurricanes. Summers are typically very hot humid and frequent rainfall in the afternoons. Temperatures in the roadway edges can be harsh as it is surrounded by roadway asphalt & development. The summer warm evening temps can have the tendency to create conditions conducive to fungus production when combined with the high daily rainfall. Tree wells are design to use existing rainfall to water the trees. However, in periods of low or no rainfall, supplemental watering will be required. Supplemental truck watering if needed, will be the source of shrub landscape watering. Supplemental watering will be required to establish the plantings after installation and up to end of warranty period.

#### MAINTENANCE PLAN:

Maintenance to be done on the current Hillsborough County schedules. This to be on a bi-weekly basis from April through September and a month basis September through March. This includes litter pickup, mowing, edging weed removal and line trimming Pruning, fertilization and mulch replenishment to be done on an annual or semi-annual basis

#### Mowing:

The final project surface will be completed with Bahia sod in all areas not defined as plant bed. The mowing to be to a height of 3". This is to remove the seed heads from weeds and help control the invasive weeds. It can also be controlled by applications of specific herbicides, according to manufacturer's directions and frequency, to control initial weed growth after construction.

#### Edging:

Edging to be performed around the rootball perimeter of the street tree and palm root balls, with a diameter of 6' for each tree and palm. This to coincide with the mowing schedule.

#### Weeding:

Use of herbicides is encouraged to minimize hand pulling of weeds along the edge of the busy roadway. Care should be taken not to overspray onto the leaves of the desired landscape plantings. Correct applications of the proper herbicides have been proven to work effectively to reduce weeds, but not harm the trees and palms. Only Florida State licensed applicators will be permitted to apply herbicides.

#### Mulch:

Frequent observation and replacement of mini-pine bark mulch as required to maintain a 2-3" cover will help reduce invasive weeds. Spot mulch, semi-annually as needed for areas that need mulch cover. Replenish Mulch to a 3" depth at the end of the 12-month warranty period prior to turning the site over to the Hillsborough County Representative for maintenance.

#### Pruning:

The shrub selections are chosen for their habit of maintaining a small size and pruning should not be required other than an annual trimming of overgrown palm fronds and branches. Dead tree limbs and palm fronds need to be removed as soon as they are seen.

#### Fertilization:

The trees, shrubs and ground covers to be fertilized annually in March. Use a Time-release 2-8-10 Osmocote or equal, and according to manufacturer's recommendations for the particular plant material. Do not Fertilize in summer months, Check local ordinances for times of non-fertilization within City of Tampa.

#### Watering:

The watering will be by use of either Truck Watering or natural rainfall. Watering to be performed daily if needed, for the first month after Substantial Completion, and then weekly as needed to maintain the plantings in a Florida #1 condition up to Final Acceptance and to end of the 12-month warranty period. Watering to be the responsibility of the Landscape Contractor up to Final Acceptance and also during the entire 12-month Warranty Period. After the 12-month Warranty Period, Hillsborough County will be responsible for watering.

REVISIONS

DESCRIPTION

DATE

DESCRIPTION

DESCRIPTION

DESCRIPTION

DESCRIPTION

DESCRIPTION

TERRA disagree Architect Florida LIC #0001123

LANDSCAPE ARCHITECTS ISLANDENISTS URBAN DESIGNERS
URBAN DESIGNERS
URBAN DESIGNERS
1188 Kapp Drive | Clerwater, Florida | 33765 | 727,441,4504 |

1186 Carry OF TAMPA

TRANSPORTATION DEPARTMENT

CITY OF TAMPA

TRANSPORTATION DEPARTMENT

CITY PROJECT NO. COUNTY FINANCIAL PROJECT

Authorization # 254

1001221 HILLSBOROUGH 436639-1-58-01

LANDSCAPE MAINTENANCE NOTES

SHEET NO.

NO. L16

### WALK-BIKE LAP PROJECT

#### INDEX OF WATER RELOCATION PLANS

SHEET NO. SHEET DESCRIPTION

U-01 KEY SHEET

TABULATION OF QUANTITIES U-02

U-03 GENERAL NOTES

U-04 - U-08 WATER MAIN PLAN SHEETS U-09 WATER MAIN PROFILE SHEET

U-10 WATER MAIN DRAINAGE STRUCTURE DETAIL U-11 WATER MAIN CROSS SECTION DETAIL


U-12 - U-19 WATER MAIN STANDARD DETAILS


## CITY PROJECT NO. 1001221 FINANCIAL PROJECT ID 436639-1-58-01

E COLUMBUS DR FROM SR 45 (N NEBRASKA AVE) TO N 14TH ST

HILLSBOROUGH COUNTY

## UTILITY WORK BY HIGHWAY CONTRACTOR WATER RELOCATION PLANS

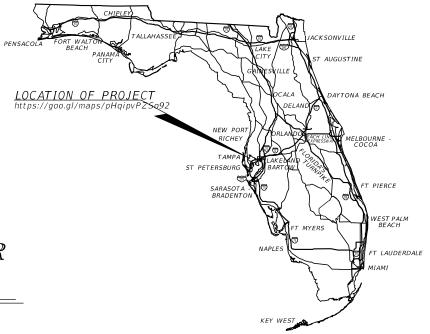

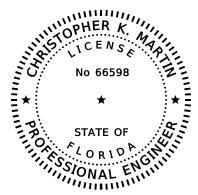

Christoph Christopher K Martin DN: c=US, o=AYRES er K

Martin /

CONSTRUCTION PLANS MARCH 2020

THIS ITEM HAS BEEN DIGITALLY SIGNED AND SEALED BY

ON THE DATE ADJACENT TO THE SEAL

PRINTED COPIES OF THIS DOCUMENT ARE NOT CONSIDERED SIGNED AND SEALED AND THE SIGNATURE MUST BE VERIFIED ON ANY ELECTRONIC COPIES.

#### WATER RELOCATION PLANS **ENGINEER OF RECORD:**

CHRISTOPHER K. MARTIN, P.E. P.E. LICENSE NUMBER 66598 AYRES ASSOCIATES 8875 HIDDEN RIVER PKWY, SUITE 200 TAMPA, FL 33637 (813) 978-8688 CERTIFICATE OF AUTHORIZATION 4356

FDOT PROJECT MANAGER: NINA MABILLEAU, E.I.

FISCAL	SHEET
YEAR	NO.
21	U-01

CITY OF TAMPA CIP NO.: 1001221 / FPID: 436639-1-58-01							
SUMMARY OF UTILITIES							
ITEM NUMBER	ITEM DESCRIPTION	UNIT	QUANTITY TOTAL				
1050- 51-202	UTILITY PIPE-DUCTILE IRON/CAST IRON, FURNISH & INSTALL, WATER/SEWER, 2"	LF	16				
1050- 51-206	UTILITY PIPE-DUCTILE IRON/CAST IRON, FURNISH & INSTALL, WATER/SEWER, 6"	LF	65				
1050- 51-212	UTILITY PIPE-DUCTILE IRON/CAST IRON,, FURNISH & INSTALL, WATER/SEWER, 12"	LF	20				
1055- 51-112	UTILITY FITTINGS, DUCTILE IRON/CAST IRON, FURNISH & INSTALL ELBOW, 12"	EA	4				
1055- 51-412	UTILITY FITTINGS, DUCTILE IRON/CAST IRON, FURNISH & INSTALL UNION, 12"	EA	2				
1080- 23-106	UTILITY FIXTURE-TAPPING SADDLE/SLEEVE, FURNISH & INSTALL, 6"	EA	1				
1080- 24-106	UTILITY FIXTURE, VALVE ASSEMBLY, FURNISH AND INSTALL, 6"	EA	2				
1080- 27-106	UTILITY FIXTURE-LINE STOP ASSEMBLY, FURNISH AND INSTALL, 6"	EA	1				
1080- 27-112	UTILITY FIXTURE-LINE STOP ASSEMBLY, FURNISH AND INSTALL, 12"	EA	2				
1080- 29-106	UTILITY FIXTURE-MECHANICAL JOINT RESTRAINT, FURNISH & INSTALL, 6"	EA	8				
1080- 29-112	UTILITY FIXTURE, MECHANICAL JOINT RESTRAINT, FURNISH & INSTALL, 12"	EA	10				
1644-113-08	FIRE HYDRANT , F&I, STANDARD, 2 HOSE, 1 PUMPER, 6"	EA	1				
1644-900	FIRE HYDRANT, REMOVE	EA	1				

	REVI	CHRISTOPHER K. MARTIN, P.E.		
DATE	DESCRIPTION	DATE	DESCRIPTION	P.E. LICENSE NUMBER 66598 AYRES ASSOCIATES 8875 HIDDEN RIVER PKWY, SUITE 200 TAMPA, FL 33637 CERTIFICATE OF AUTHORIZATION 4356

TE 200	CITY
ON 4356	

CITY OF TAMPA
TRANSPORTATION DEPARTMENT
CITY PROJECT NO. COUNTY FINANCIAL PROJECT ID
1001221 HILLSBOROUGH 436639-1-58-01

TABULATION OF QUANTITIES

SHEET NO. U-02

#### GENERAL

- WATER SERVICE SHALL BE PROVIDED BY THE CITY OF TAMPA.
  ALL WORK TO BE PERFORMED ON EXISTING OR ON FUTURE WATER FACILITIES TO BE OWNED AND MAINTAINED BY THE CITY OF TAMPA SHALL BE IN ACCORDANCE WITH THE LATEST EDITION OF CITY OF TAMPA WATER DEPARTMENT TECHNICAL MANUAL. ALL CONSTRUCTION DETAILS AND STANDARDS DESCRIBED THERE WITHIN SHALL BE CONSIDERED TO BE PART OF THE CONTRACT DOCUMENTS FOR THIS PROJECT.
- CONSTRUCTION OF ANY WATER INSTALLATIONS TO BE OWNED AND MAINTAINED BY THE CITY OF TAMPA SHALL BE COORDINATED WITH THE CITY OF TAMPA CONTRACT ADMINISTRATION DEPARTMENT PRIOR TO THE START OF CONSTRUCTION. THE ENGINEER OF RECORD AND / OR CONTRACTOR SHALL CONTACT THE ADMINISTRATION DEPARTMENT AT (813) 635-3400 TO SCHEDULE A PRE-CONSTRUCTION MEETING FOR THE REVIEW OF INSTALLATION TECHNIQUES AND PROCEDURES A MINIMUM OF TEN (10) WORKING DAYS PRIOR TO
- PRIOR TO THE PRE-CONSTRUCTION MEETING WITH THE CITY OF TAMPA REGARDING THE PUBLIC WATER FACILITIES, THE CONTRACTOR SHALL OBTAIN THE LATEST EDITION OF THE CITY OF TAMPA WATER FACILITIES, THE CONTRACTOR SHALL OBTAIN THE LATEST EDITION OF THE CITY OF TAMPA WATER DEPARTMENT TECHNICAL MANUAL. ALL PRIVATELY INSTALLED PUBLIC FACILITIES, INCLUDING CONSTRUCTION, MATERIALS, AND WORKMANSHIP, ARE TO CONFORM WITH THE SPECIFICATIONS OUTLINED IN THE DEPARTMENT'S TECHNICAL MANUAL. IN THE EVENT OF A DISCREPANCY, THE MOST STRINGENT CRITERIA
- BENDS SHALL BE INSTALLED ON ALL WATER MAINS AS NECESSARY TO MAINTAIN PROPER ALIGNMENT. JOINT DEFLECTIONS SHALL BE IN ACCORDANCE WITH AWWA C-600 (LATEST EDITION) EXCEPT DEFLECTIONS ALLOWED SHALL BE IN ACCORDANCE WITH AWWA C-600 (LATEST EDITION) EXCEPT DEFLECTIONS ALLOWED SHALL BE LESS 80% OF THE DEFLECTION VALUES GIVEN IN THE AWWA DEFLECTION TABLE. VALVES ON EXISTING CITY OF TAMPA WATER MAINS ARE TO BE OPERATED BY CITY PERSONNEL ONLY. FIRE HYDRANT ASSEMBLIES TO BE OWNED AND MAINTAINED BY THE CITY SHALL BE 5 ½ DNS. ALL FIRE HYDRANT ASSEMBLIES AND FIRE LINE DOUBLE DETECTOR CHECK VALVES WHICH ARE TO BE PRIVATELY OWNED AND MAINTAINED SHALL BE PAINTED RED. FOR ANY NEW, ADJUSTED, OR RELOCATED FIRE HYDRANT ASSEMBLY, HYDRANT EXTENSIONS ARE NOT

- PERMITTED. FIRE HYDRANT ASSEMBLY INSTALLATIONS MUST CONFIRM WITH THE WATER DEPARTMENT STANDARD. IF A NEW, ADJUSTED, OR RELOCATED FIRE HYDRANT ASSEMBLY IS NOT PROPERLY SIZED, A NEW
- THE PUBLIC WATER MAIN BY THE DEVELOPER.

  ON RELEASED, A NEW HYDRANT MUST BE ORDERED AT THE DEVELOPER'S EXPENSE.

  THE DEVELOPER SHALL BE RESPONSIBLE TO LOCATE ALL EXISTING PUBLIC WATER SERVICE LINES NO LONGER TO BE SERVING THE PARCEL. THESE SERVICE LINES ARE TO BE REMOVED, AND CUT & CAPPED AT THE PUBLIC WATER MAIN BY THE DEVELOPER.
- ALL PROPOSED PIPE AND AFFECTED EXISTING PIPE SHALL BE RESTRAINED IN ACCORDANCE WITH THE RESTRAINT JOINT DETAILS.
- THE MATERIAL QUANTITIES AND CALLOUT LENGTHS ARE APPROXIMATE. THE CONTRACTOR SHALL FIELD VERIFY QUANTITIES PRIOR TO ACQUISITION AND COMMENCEMENT OF CONSTRUCTION WORK.

#### PIPE CLEARANCES

- ALL WATER MAINS SHALL HAVE A MINIMUM COVER OF 36 INCHES AND SHALL MAINTAIN A MINIMUM OF THREE (3) FEET HORIZONTAL SEPARATION FROM OTHER UTILITIES, EXCEPT STORM, WASTEWATER, AND GAS WHICH SHALL MAINTAIN TEN (10) FEET HORIZONTAL SEPARATION, UNLESS OTHERWISE NOTED.
- WATER MAINS SHALL CROSS ABOVE OTHER PIPES. WHEN WATER MAINS CROSS ANOTHER UTILITY, 18" OF OUTSIDE-TO-OUTSIDE VERTICAL SEPARATIONS SHOULD BE PROVIDED. IN CASES WHERE THE PREFERRED SEPARATION MAY NOT BE MET, A MINIMUM OF 12" OF OUTSIDE-TO-OUTSIDE VERTICAL SEPARATION MUST BE PROVIDED
- ALL WATER MAIN CROSSINGS WILL OTHER UTILITIES SHALL BE ARRANGED SO THAT THE JOINTS OF THE CROSSING PIPES ARE EQUIDISTANT FROM THE POINT OF CROSSING (PIPES CENTERED ON THE CROSSING). CLEARANCE BETWEEN ALL TREES AND WATER MAINS SHALL MEET CITY OF TAMPA PARKS DEPARTMENT
- LATEST REQUIREMENTS. NO TREE SHALL BE PLANTED WITHIN 10 FEET OF INSTALLED OR EXISTING WATER
- ALL WATER MAINS SHALL MAINTAIN SEPARATION AS DESCRIBED IN F.A.C. 62-555.314.

#### MATERIAL

- ALL VALVES SHALL BE RIGHT HAND (CLOCKWISE) OPEN.
- ALL DUCTILE IRON PIPE (DIP) FITTINGS AND APPURTENANCES SHALL UTILIZE POLYWRAP.

- ALL DUCTILE IRON PIPE (DIP) FITTINGS AND APPURIENANCES SHALL UTILIZE POLYWRAP.
  ALL HARDWARE SHALL BE, AT MINIMUM, 304 STAINLESS STEEL, UNLESS OTHERWISE NOTED.
  ALL BELOW GROUND BENDS SHALL BE MECHANICAL JOINT.
  ALL VALVES AND FITTINGS SHALL BE RESTRAINED.
  CONCRETE THRUST BLOCKS SHALL NOT BE USED TO PROVIDE THRUST RESTRAINT. RESTRAINT OF PUSH-ON DIP (OTHER THAN FOR FITTINGS AND VALVES) SHALL BE WITH APPROVED PUSH-ON "GRIPPER-TYPE"
  RESTRAINTS. FITTINGS AND VALVES SHALL BE CONNECTED TO PIPE WITH MEGA LUGS, OR APPROVED EQUAL.
- ALL POTABLE WATER SERVICE LATERALS, AIR RELEASE VALVES, AND TEMPORARY SAMPLE POINTS SHALL BE CONSTRUCTED OF BLUE SDR-9 HIGH DENSITY POLYETHYLENE (HDPE) TUBING. ALL HDPE TUBING SHALL BE INSTALLED WITHIN A CASING AS DEFINED IN THE SPECIFICATIONS AND DETAILS OF THE CITY OF TAMPA WATER DEPARTMENT TECHNICAL MANUAL.

#### DIRECTIONAL DRILLING

- HORIZONTAL ALIGNMENT SHALL BE AS SHOWN ON THE DRAWINGS. THE PIPE SHALL HAVE A MINIMUM 48-INCH COVER. THE MAXIMUM DEPTH SHALL BE DETEM1INED BASED ON 36-INCH MINIMUM CLEARANCE UNDER WATER OR GAS LINES AND 24-INCH CLEARANCE UNDER ALL OTHER EXISTING OR PROPOSED UTILITIES TO BE CROSSED. COMPOUND CURVATURES MAY BE USED, BUT SHALL NOT EXCEED THE MAXIMUM DE?ECTIONS AS SET FORTH BY THE HDPE PIPE MANUFACTURE OR AWWA STANDARDS, WHICHEVER IS STRICTER. ENTRY ANGLE SHALL BE 12° - 14° IDEAL (NOT TO EXCEED 15°). EXIT ANGLE SHALL BE 6° - 12° TO FACILITATE
- ENTRY AND EXIST ANGLES ARE DE?NED AS ANGLES FROM THE HORIZONTAL
- A BORING LOG FOR THE VERTICAL AND HORIZONTAL ALIGNMENTS OF THE DIRECTIONAL DRILLED PIPES SHALL BE PROVIDED AND SUBMITTED ALONG WITH THE AS BUILT PACKAGE.

CITY OF TAMPA WATER DEPARTMENT NOTES (CONT'D.)

#### TESTING

- ALL COMPONENTS OF THE WATER SYSTEM, INCLUDING FITTINGS, HYDRANTS, CONNECTIONS, AND VALVES SHALL BE PROPERLY PRESSURE TESTED, WITNESSED, AND ACCEPTED BY THE CITY. PRESSURE TEST TO BE PERFORMED IN ACCORDANCE WITH CITY OF TAMPA WATER DEPARTMENT SPECIFICATIONS. CONTRACTOR TO NOTIFY THE ASSIGNED CITY INSPECTOR A MINIMUM OF THREE (3) WORKING DAYS IN ADVANCE OF PERFORMING TESTS. CONTRACTOR SHALL PRESSURE TEST WATER MAINS AT A MINIMUM OF 150 PSI FOR A PERIOD OF TWO (2) HOURS IN ACCORDANCE WITH AWWA C600-87 STANDARDS. THE CONTRACTOR SHALL MAKE ALL NECESSARY APPLICATIONS AND ARRANGEMENTS
- ALL SAMPLE, PRESSURE TEST, AND CHLORINATION POINT PIPING SHALL BE COMPLETELY REMOVED PRIOR TO FINAL ACCEPTANCE. THE CORPORATION STOP SHALL BE CLOSED AND PLUGGED AT THE MAIN. CONTRACTOR SHALL PERFORM DISINFECTION AND HIRE INDEPENDENT FIRMS TO CONDUCT BACTERIOLOGICAL
- TESTING AS DEFINED IN F.A.C. 62-55.340. CONTRACTOR SHALL SUPPLY THE CITY WITH AS-BUILTS AND SAMPLE RESULTS NECESSARY TO OBTAIN DEP CLEARANCES.

#### RESTORATION

- ROADWAY RESTORATION SHALL BE IN CONFORMANCE WITH CORRESPONDING JURISDICTIONS LATEST'S STANDARDS. 2. ALL ASPHALT OPEN CUTS WITHIN CITY RIGHT-OF-WAY SHALL BE FULLY MILLED AND OVERLAYED FROM EDGE OF PAVEMENT TO EDGE OF PAVEMENT PER THE WATER DEPARTMENT'S STANDARD
- DISTURBANCE TO ANY PROPERTY, PUBLIC OR PRIVATE, AS PART OF THE CONSTRUCTION OF PUBLIC WATER FACILITIES, SHALL BE RESTORED TO ORIGINAL OR BETTER CONDITION

#### CERTIFICATE OF OCCUPANCY

THE CITY OF TAMPA WATER DEPARTMENT'S HOLD ON THE CERTI?CATE OF OCCUPANCY WILL NOTBE RELEASED UNTIL ALL CLOSEOUT REQUIREMENTS SET FORTH BY CITY OF TAMPA WATER DEPARTMENT AND CONTRACT ADMINISTRATION HAVE BEEN SATISFIED. THESE REQUIREMENTS MAY INCLUDE BY NOT BE LIMITED TO.

- FINAL INSPECTION IN CONJUNCTION WITH THE CONTRACT ADMINISTRATION DEPARTMENT PERSONNEL COMPLETED AND APPROVED.
- AS-BUILTS, BOTH HARD COPIES AND PDF, HAVE BEEN RECEIVED AND ACCEPTED.
- ALL NECESSARY TESTING COMPLETED AND CERTIFIED.
- PAYMENT OF ALL CITY OF TAMPA WATER DEPARTMENT FEES.
- ISSUANCE OF FLORIDA DEPARTMENT OF ENVIRONMENTAL PROTECTION / HILLSBOROUGH COUNTY HEALTH DEPARTMENT CERTI?CATION OF COMPLETION APPROVAL (IF APPLICABLE).

  RECEIPT AND ACCEPTANCE OF ALL REQUIRED EASEMENT DEDICATION DOCUMENTS (IF APPLICABLE).

  RECEIPT AND ACCEPTANCE OF ALL REQUIRED TRANSFER OF OWNERSHIP DOCUMENTS (IF APPLICABLE).


	REV I.	CHRISTOPHER K. MARTIN, P.E.				
DATE	DESCRIPTION					
				AYRES ASSOCIATES		
				8875 HIDDEN RIVER PKWY, SUITE 200		
				TAMPA, FL 33637		
				CERTIFICATE OF AUTHORIZATION 4356		


CITY OF TAMPA TRANSPORTATION DEPARTMENT CITY PROJECT NO. COUNTY FINANCIAL PROJECT ID 1001221 HILLSBOROUGH 436639-1-58-01

GENERAL NOTES

SHEET NO.


U-03

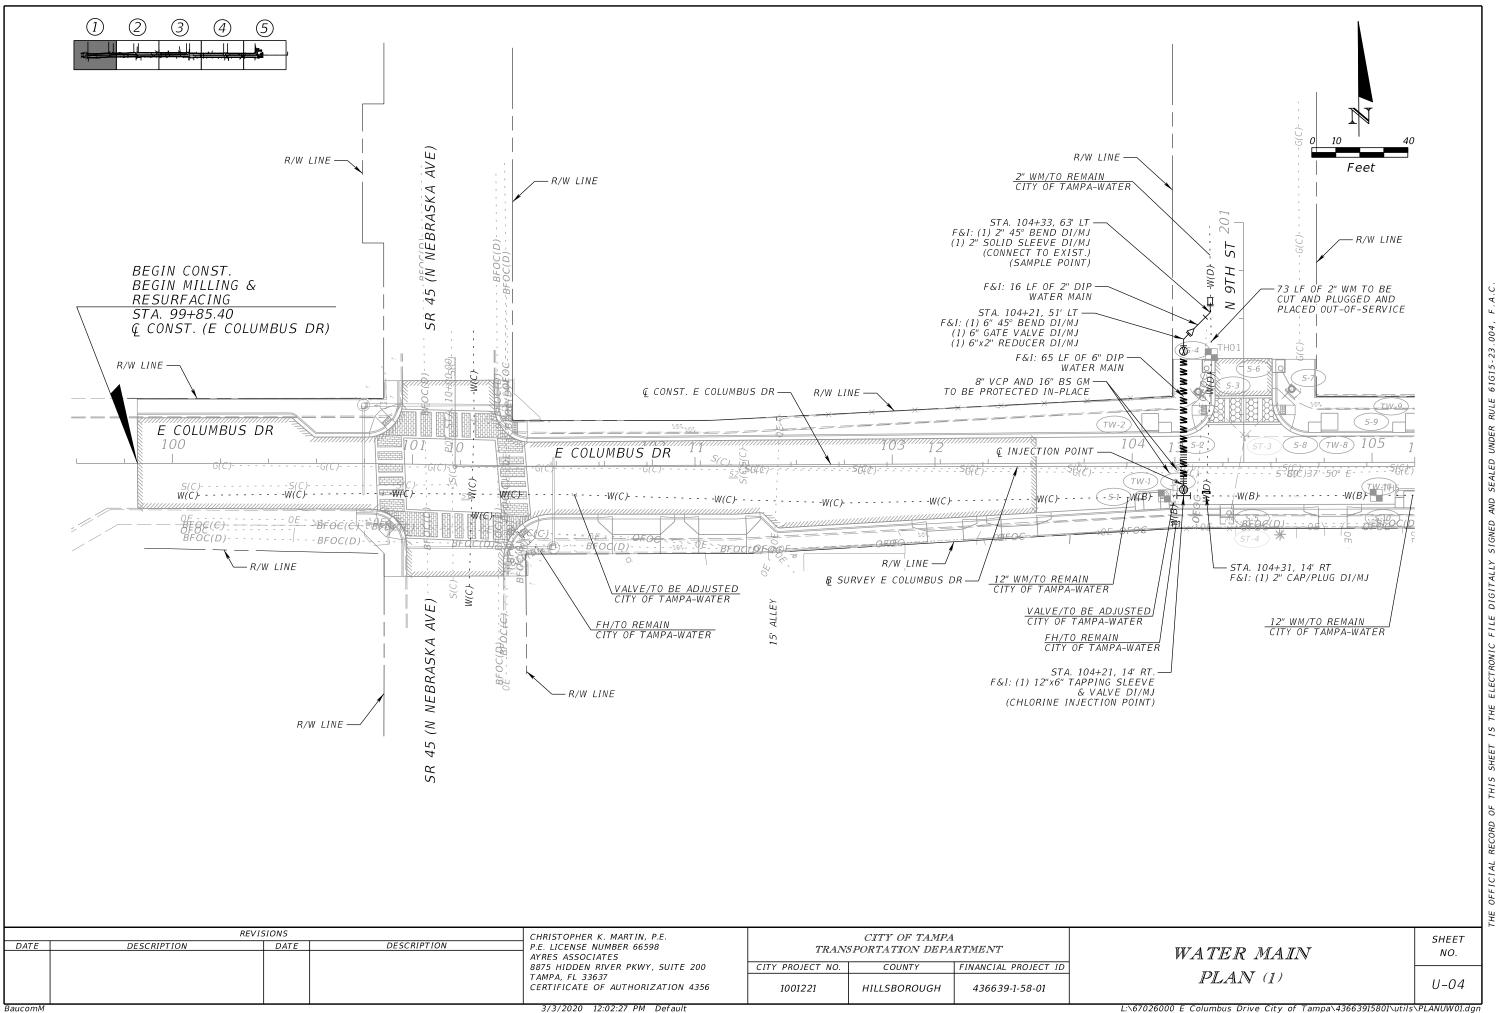

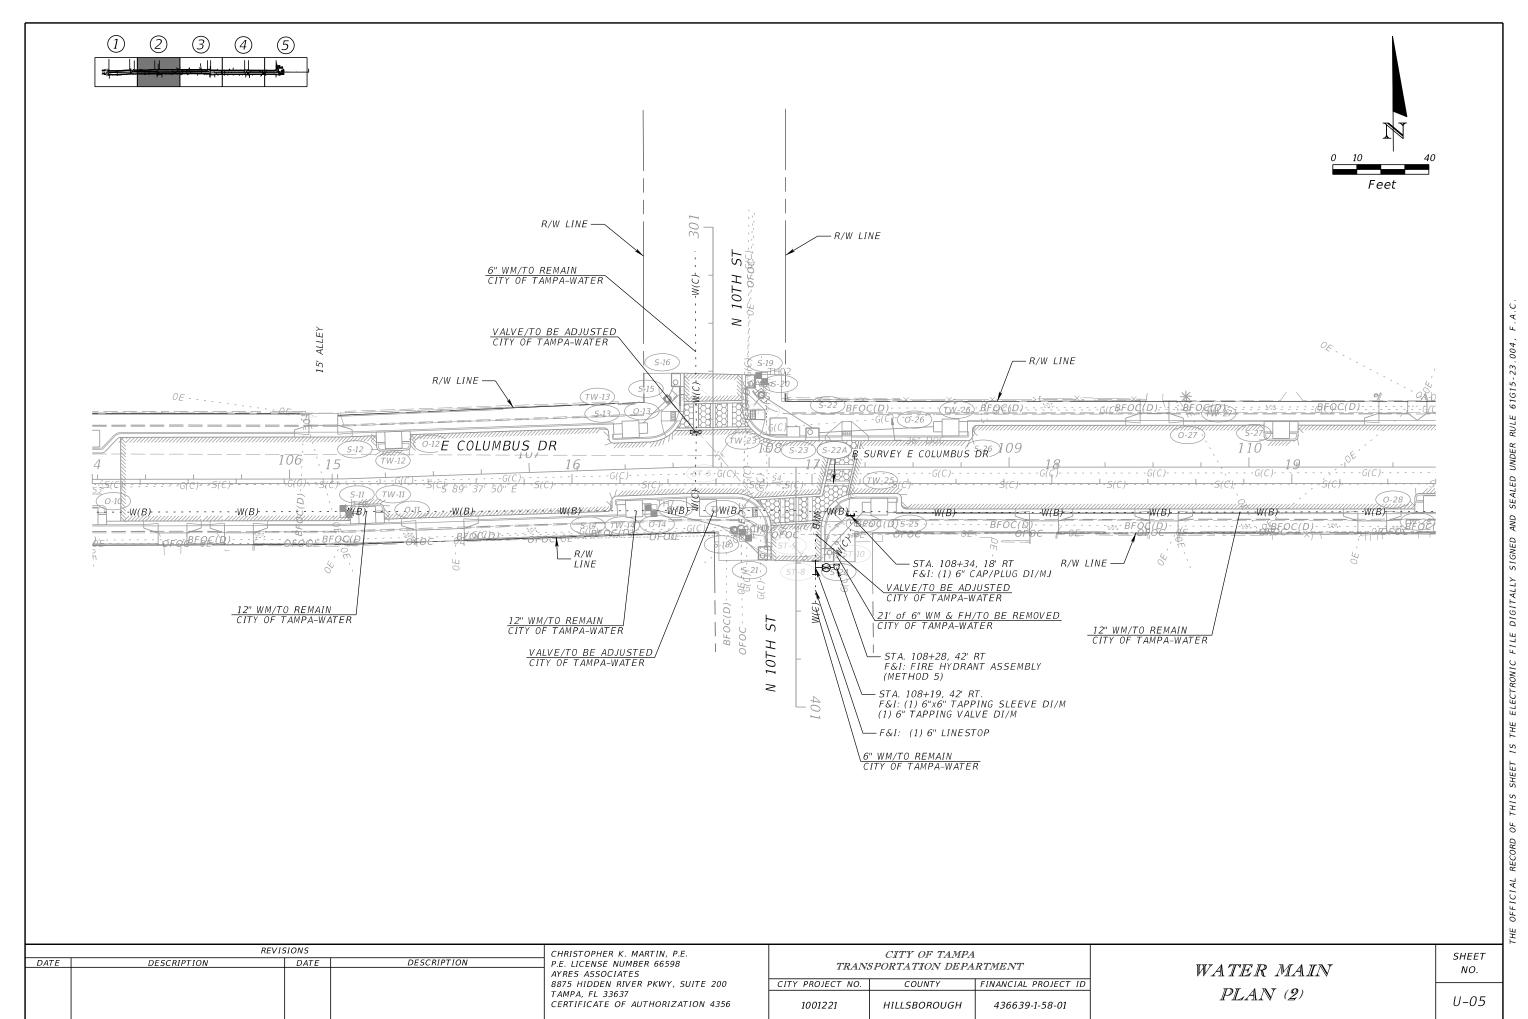

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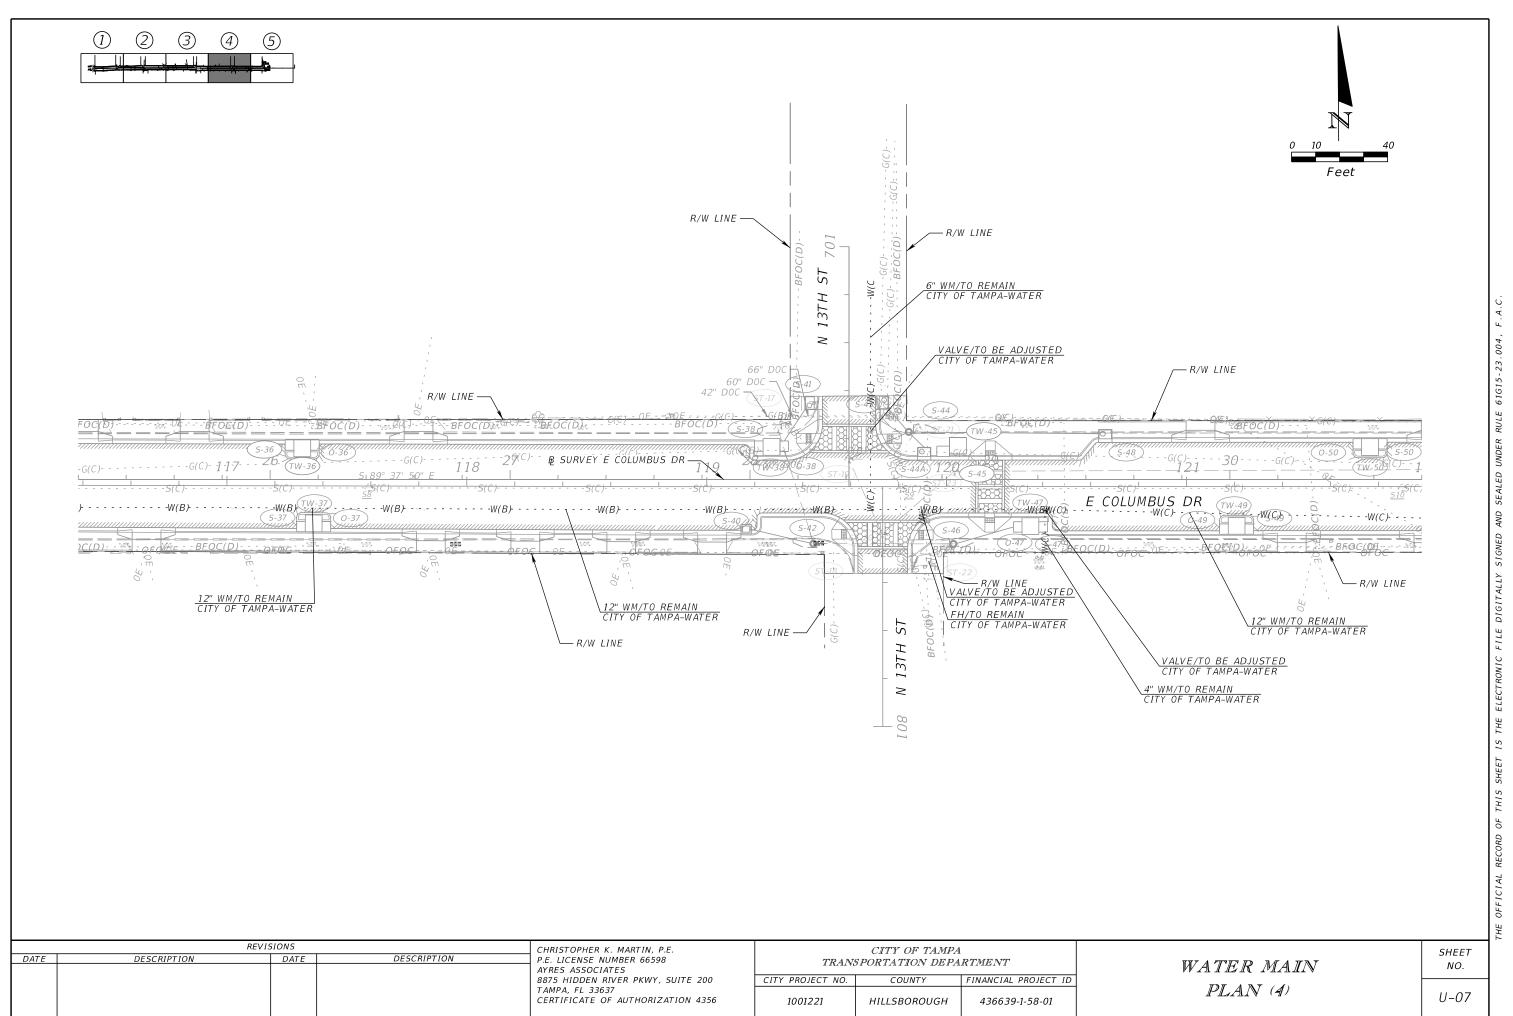
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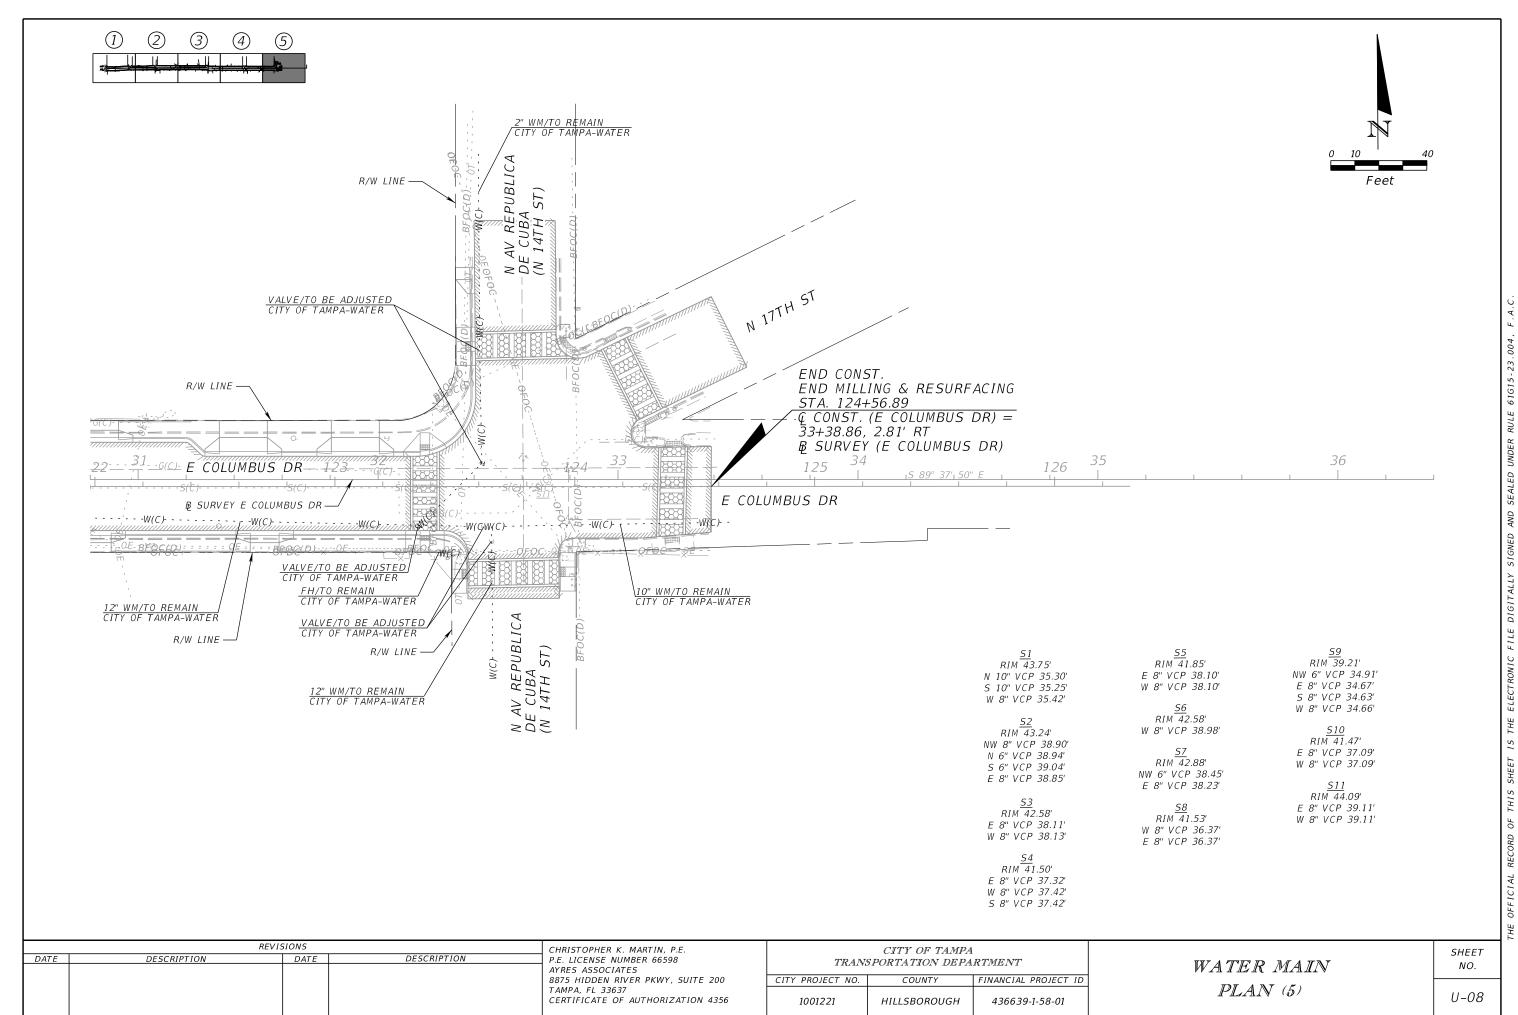


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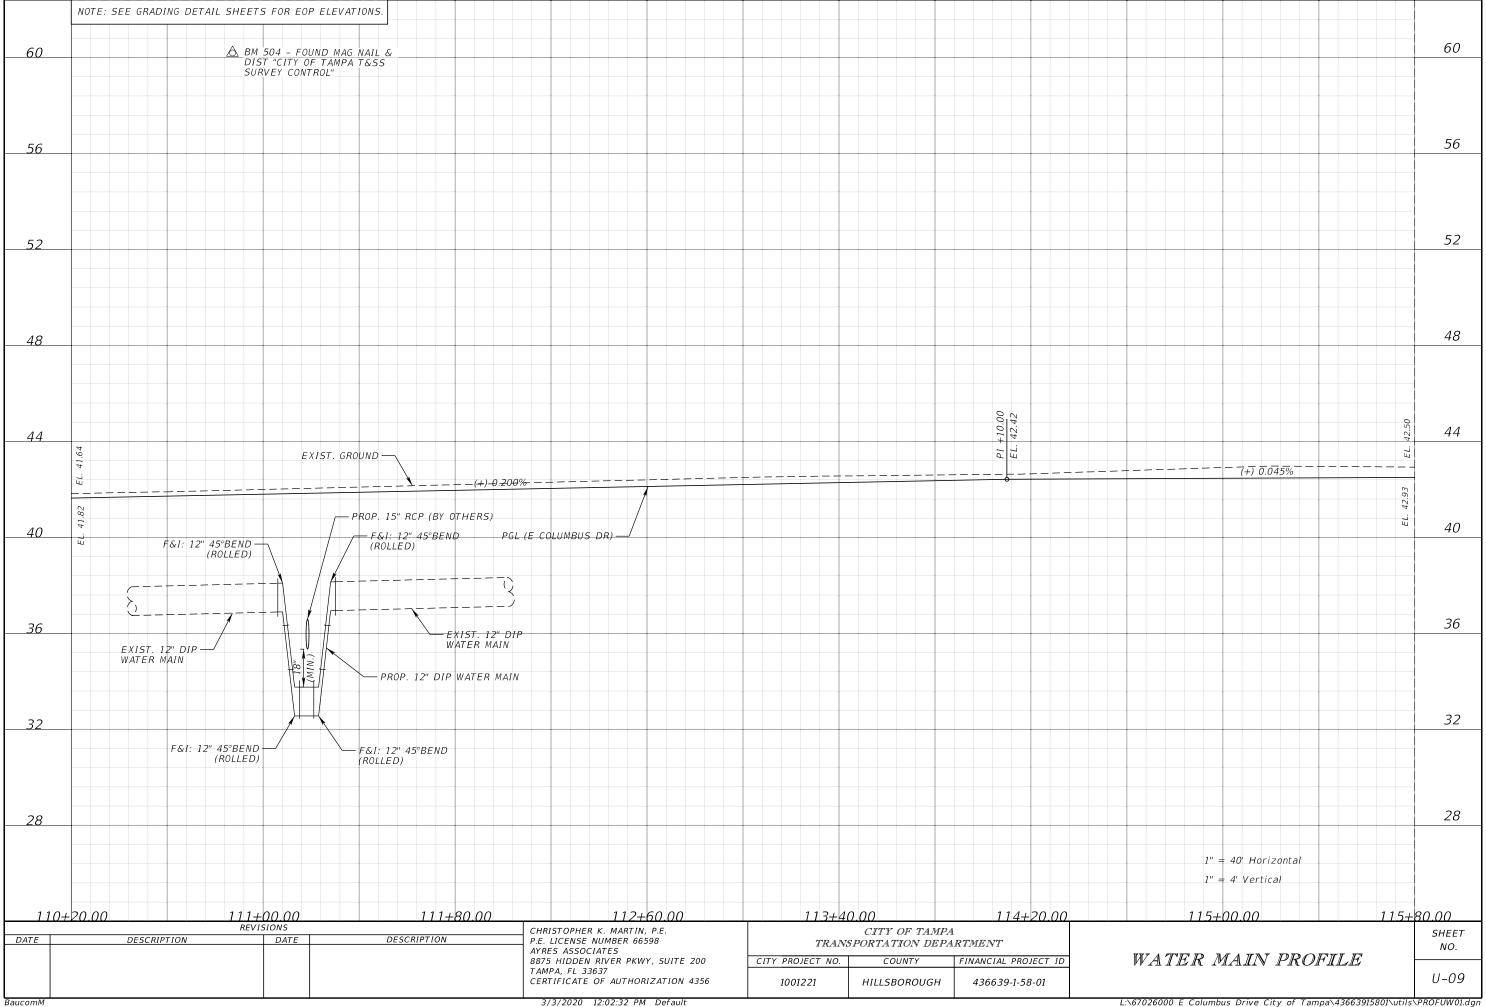
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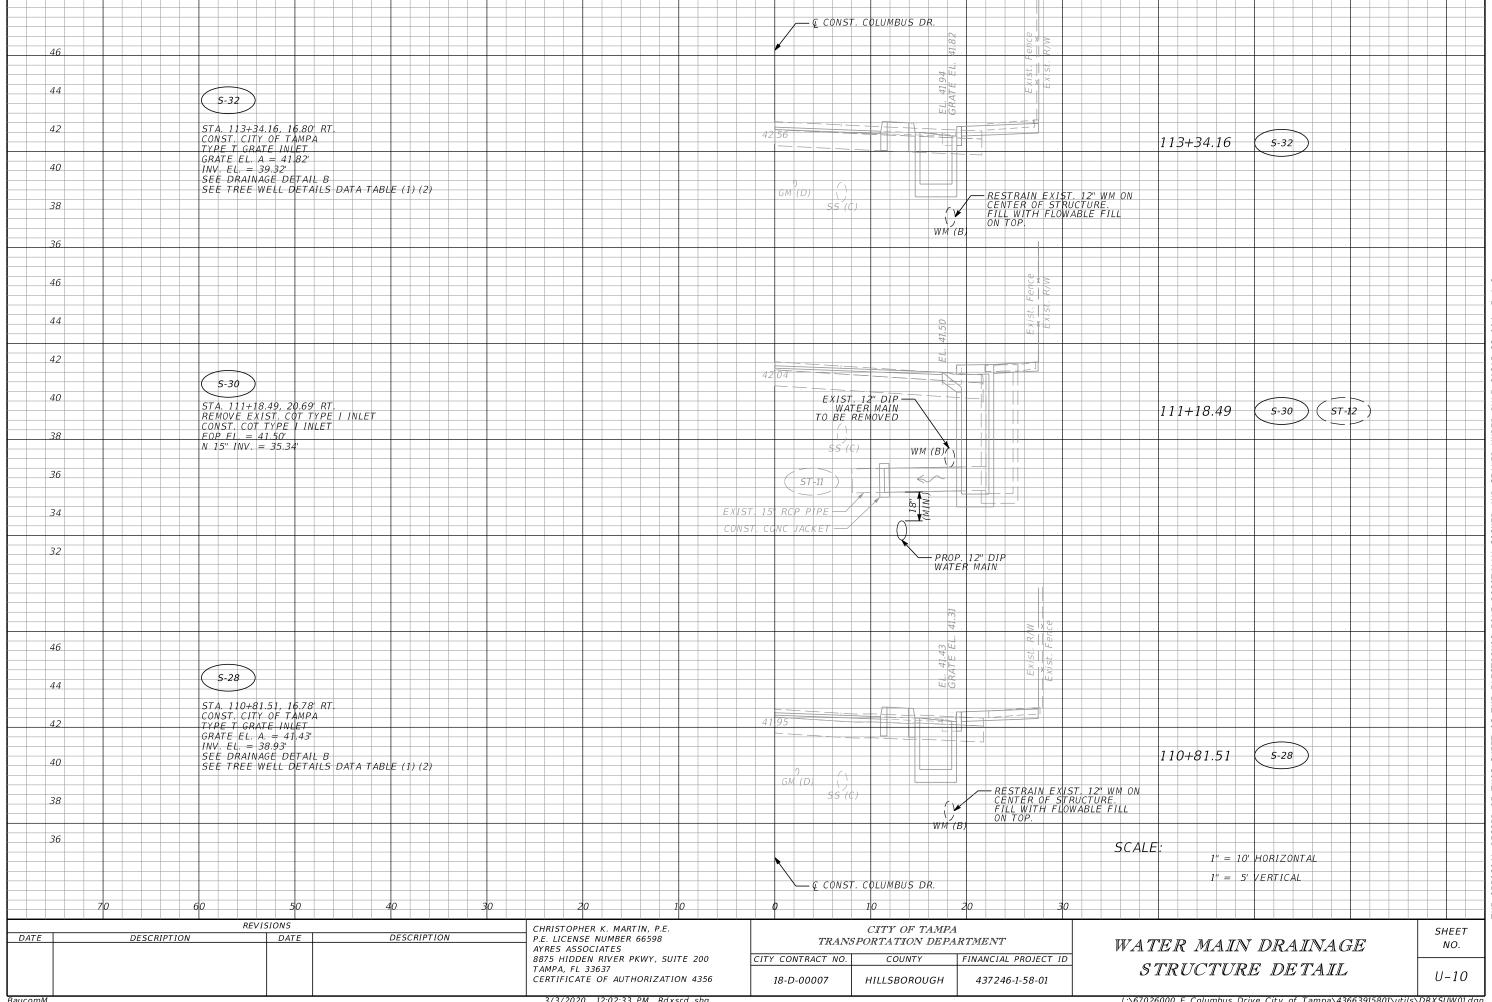
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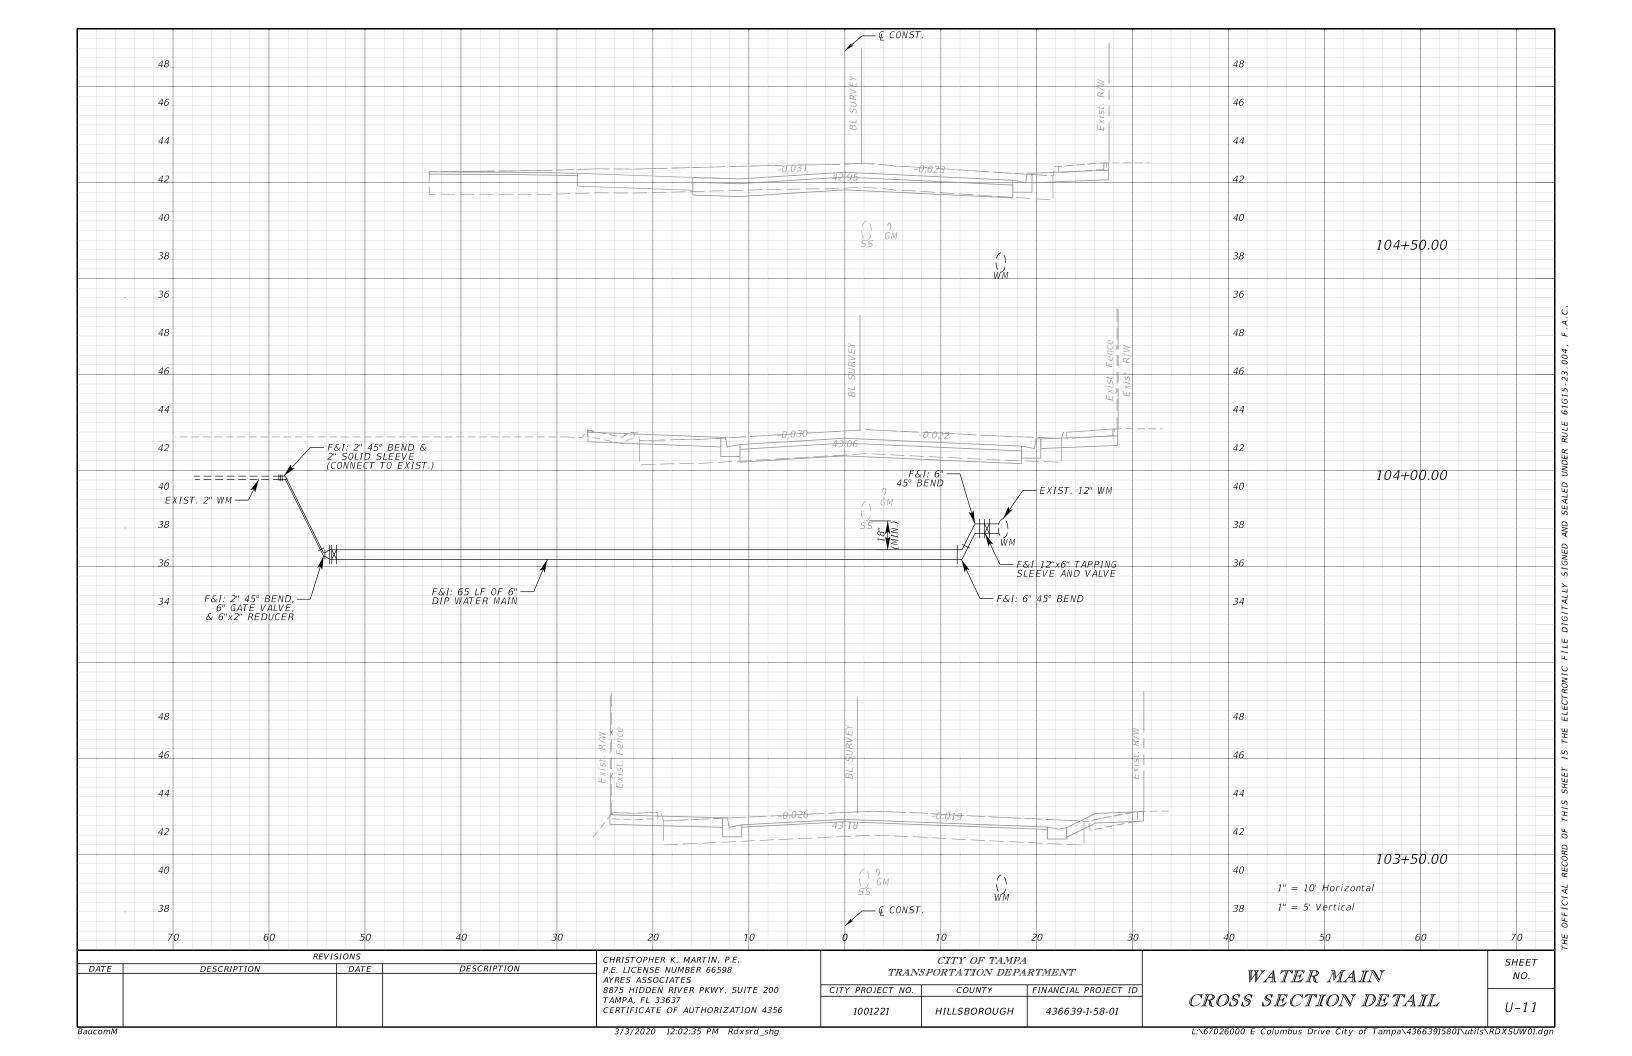


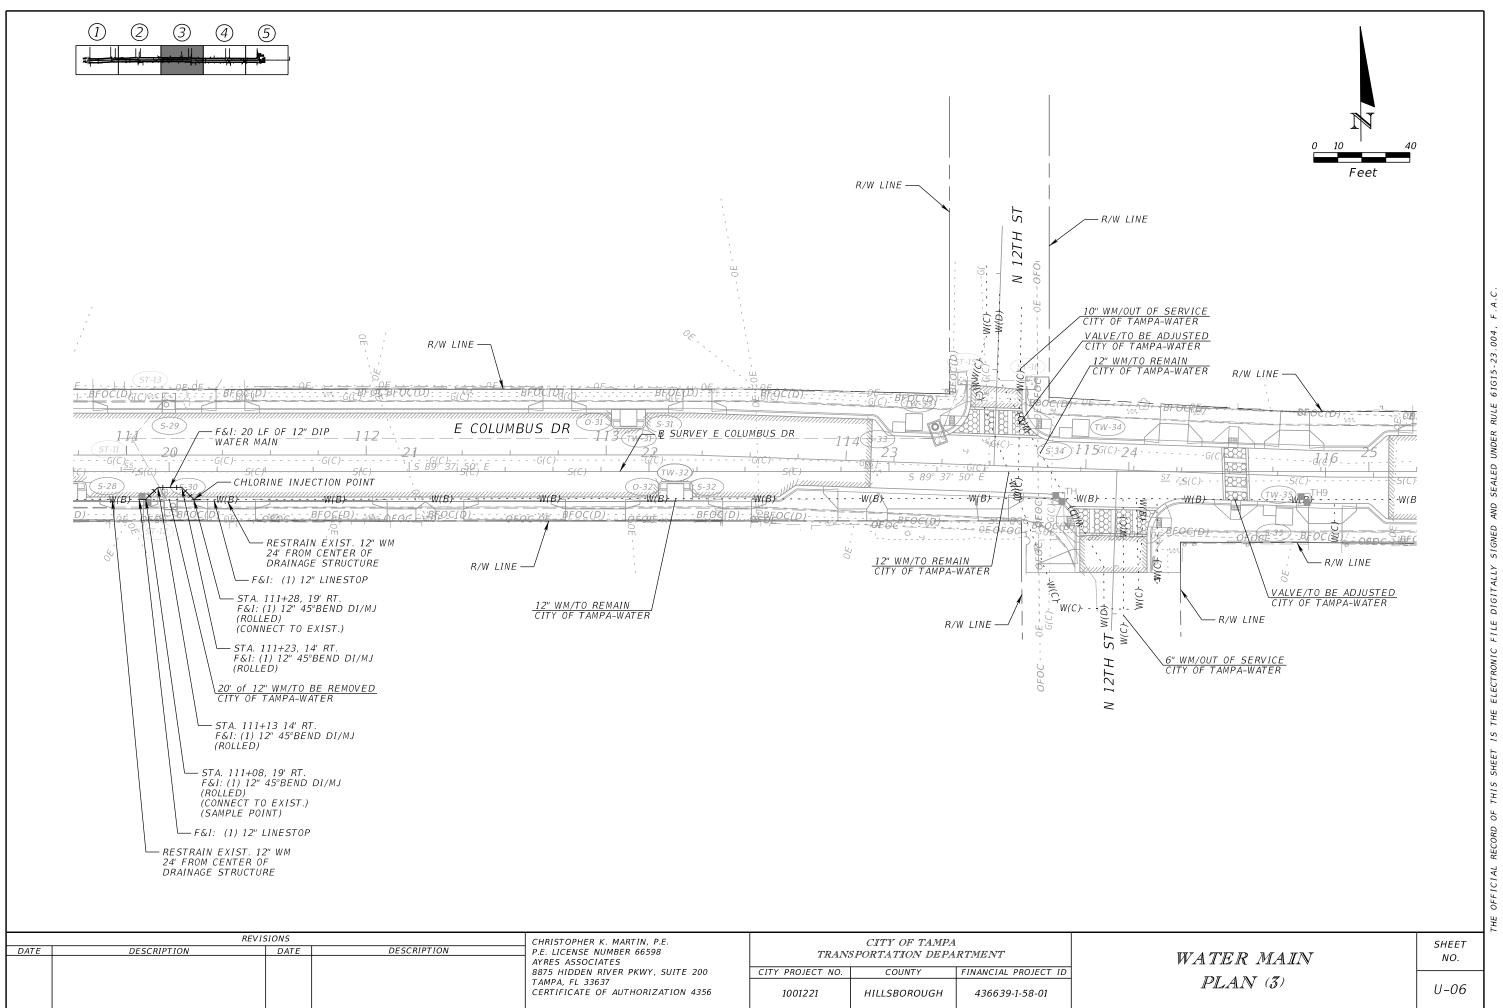


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#### NOTES:

- 1. TYPE 2 TRENCH IS DEFINED AS A FLAT-BOTTOM TRENCH. LIGHTLY CONSOLIDATE BACKFILL TO CENTERLINE OF PIPE.
- 2. THIS STANDARD SHALL BE UTILIZED IN THE ABSENCE OF SPECIFIC STANDARDS. THE STANDARD OF THE AGENCY CONTROLLING THE RIGHT-OF-WAY SHALL GOVERN UNLESS OTHERWISE DIRECTED BY CITY ENGINEER.
- 3. SUITABLE BACKFILL SHALL BE DEFINED AS MATERIAL FREE FROM CINDERS, ASHES, REFUSE, CLAY, ORGANIC MATTER, BOULDERS, ROCKS OR STONES, OR OTHER MATERIAL THAT IN THE OPINION OF THE CITY ENGINEER IS UNSUITABLE.
- 4. NON-PERVIOUS AREAS SHALL MEAN ANY CONCRETE OR ASPHALT CURB, SIDEWALK, TRAIL, DRIVEWAY, OR ROADWAY.


Nater Department

LAST REVISION

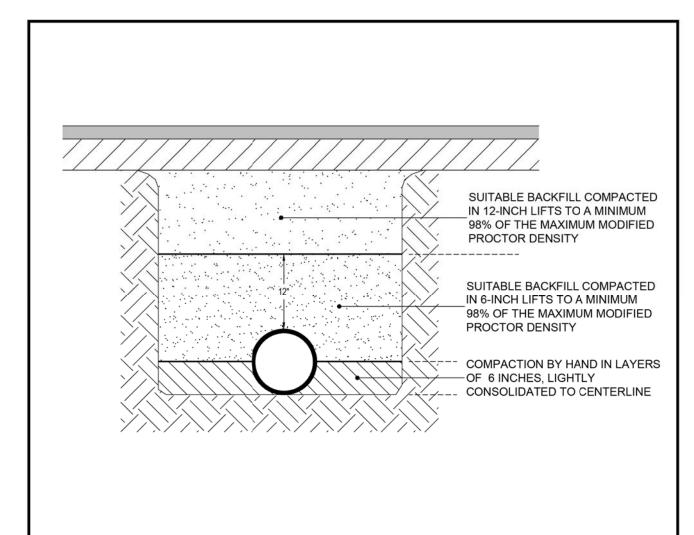JAN 2018

TRENCHING, BEDDING AND BACKFILL DETAIL FOR NON-PERVIOUS (PAVED) AREAS

2.01A

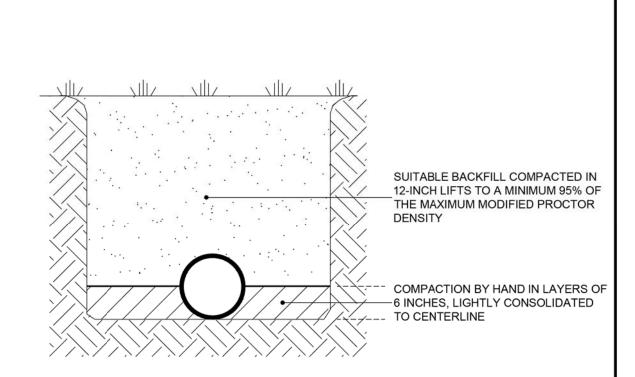

#### NOTES:

- 1. TYPE 2 TRENCH IS DEFINED AS A FLAT-BOTTOM TRENCH. LIGHTLY CONSOLIDATE BACKFILL TO CENTERLINE OF PIPE.
- 2. THIS STANDARD SHALL BE UTILIZED IN THE ABSENCE OF SPECIFIC STANDARDS. THE STANDARD OF THE AGENCY CONTROLLING THE RIGHT-OF-WAY SHALL GOVERN UNLESS OTHERWISE DIRECTED BY CITY ENGINEER.
- 3. SUITABLE BACKFILL SHALL BE DEFINED AS MATERIAL FREE FROM CINDERS, ASHES, REFUSE, CLAY, ORGANIC MATTER, BOULDERS, ROCKS OR STONES, OR OTHER MATERIAL THAT IN THE OPINION OF THE CITY ENGINEER IS UNSUITABLE.
- 4. NON-PAVED AREA IS A PERVIOUS AREA. IF ANY PART OF THE TRENCH IS WITHIN A CONCRETE OR ASPHALT CURB, SIDEWALK, DRIVEWAY, OR ROADWAY, THEN STANDARD DETAIL 2.01 APPLIES.

Water Department

LAST REVISION

JUL 2018

TRENCHING, BEDDING, AND BACKFILL DETAIL FOR PERVIOUS (NON-PAVED) AREAS

2.02


	REVIS	CHRISTOPHER K. MARTIN, P.E.		
DATE	E DESCRIPTION DATE DESCRIPTION			P.E. LICENSE NUMBER 66598 AYRES ASSOCIATES 8875 HIDDEN RIVER PKWY, SUITE 200 TAMPA, FL 33637 CERTIFICATE OF AUTHORIZATION 435
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CITY OF TAMPA TRANSPORTATION DEPARTMENT						
CITY PROJECT NO. COUNTY FINANCIAL PROJECT ID						
1001221	436639-1-58-01					


WATER MAIN STANDARD DETAILS (1) SHEET NO.

U-12

POLYETHYLENE TUBE IS CUT INTO LENGTHS APPROXIMATELY TWO FEET LONGER THAN THE PIPE SECTION AND PLACED AROUND IT. AFTER THE PIPE JOINT IS ASSEMBLED, THE POLYETHYLENE TUBE IS MADE TO OVERLAP THE JOINT AND THE OVERLAP SECURED IN PLACE. SINCE THE TUBE IS CONSIDERABLY LARGER THAN THE BARREL OF PIPE, IT IS MADE TO FIT SNUGLY BY FOLDING OVER AT THE TOP AND SECURING WITH TAPE EVERY 24" ALONG THE PIPE SECTION.

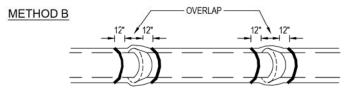

POLYETHYLENE TUBE IS CUT ONE FOOT SHORTER THAN THE LENGTH OF THE PIPE SECTION. AFTER PLACEMENT OF THE PIPE, IT IS FOLDED AND SECURED SNUGLY OVERALL. A THREE FOOT LENGTH OF POLYETHYLENE TUBE PLACED OVER THE END OF THE PRECEEDING SECTION IS THEN PULLED IN PLACE OVER THE JOINT AFTER ASSEMBLY AND SECURED.

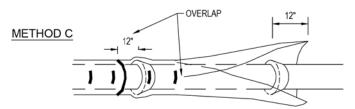

POLYETHYLENE SHEET IS CUT TO A LENGTH TWO FEET LONGER THAN THE PIPE SECTION. THE SHEET IS WRAPPED AROUND THE PIPE SO THAT IT OVERLAPS CIRCUMFERENTIALLY OVER THE TOP QUADRANT OF THE PIPE, THEN SECURED. AFTER JOINT ASSEMBLY, THE SURPLUS LENGTH OF POLYETHYLENE FILM IS SECURED AROUND THE JOINT, PROVIDING AN OVERLAP OF EACH JOINT. TAPE AT EACH JOINT AND AT 3' INTERVALS IN BETWEEN.

#### NOTES:


- 1. USE BLUE POLYETHYLENE FILM AND TAPE ONLY.
- 2. POLYETHYLENE FILM SHALL BE A MINIMUM OF 8 MIL. THICKNESS.
- SPIRAL WRAP NOT REQUIRED WITH POLYWRAP.



JUL 2018

POLYETHYLENE ENCASEMENT INSTALLATION DETAIL

2.05

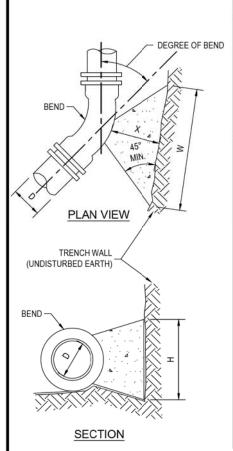

	SIZE (D)	4"	6"	8"	12"	16"	20"	24"
	THRUST (LBS.)	674	1,393	2,396	5,097	8,857	13,649	19,472
	BEARING AREA (FT. <sup>2</sup> )	0.51	1.05	1.80	3.83	6.65	10.25	14.63
11-1/4° BEND	CONCRETE (YDS.3)	0.005	0.015	0.033	# West   States   States	0.239	0.459	0.783
	H (FT.)	0.6	0.8	1.1	1.6	2.1	2.6	3.1
	W (FT.)	0.9	1.3	1.6	2.4	3.2	3.9	4.7
	X (FT.)	0.4 MIN.	0.6 MIN.	0.8 MIN.	1.2 MIN.	1.6 MIN.	2.0 MIN.	2.3 MIN.
	THRUST (LBS.)	1,342	2,772	4,769	10,145	17,628	27,166	38,757
	BEARING AREA (FT. <sup>2</sup> )	1.01	2.08	3.58	7.61	13.22	20.37	29.07
00 4100 DEND	CONCRETE (YDS.3)	0.012	0.035	0.080	0.252	0.580	1.113	1.792
22-1/2° BEND	H (FT.)	0.8	1.2	1.5	2.3	3.0	13,649 19,472 10.25 14.63 0.459 0.783 2.6 3.1 3.9 4.7 2.0 MIN. 2.3 MIN. 27,166 38,757 20.37 29.07 1.113 1.792 3.7 4.4 5.5 6.6 2.8 MIN. 3.0 MIN. 53,288 76,024 39.98 57.04 2.301 3.517 5.2 6.2 7.7 9.3 3.0 MIN. 3.0 MIN. 98,463 140,474 73.84 105.34 4.250 6.496 7.0 8.4 10.5 12.6	
	W (FT.)	1.2	1.8	2.3	3.4	4.5	5.5	6.6
	X (FT.)	0.6 MIN.	0.9 MIN.	1.2 MIN.	1.7 MIN.	2.2 MIN.	2.8 MIN.	3.0 MIN.
	THRUST (LBS.)	2,632	5,437	9,355	19,901	34,579	1.113 1.792 3.7 4.4 5.5 6.6 2.8 MIN. 3.0 MIN. 53,288 76,024 39.98 57.04 2.301 3.517	
	BEARING AREA (FT. <sup>2</sup> )	1.97	4.08	7.02	14.93	25.94	39.98	57.04
45° BEND	CONCRETE (YDS.3)	0.029	0.087	0.198	0.620	1.387	2.301	3.517
45° BEND	H (FT.)	1.2	1.7	2.2	3.2	4.2	5.2	6.2
	W (FT.)	1.7	2.5	3.2	4.7	6.2	20* 24* 13,649 19,472 10.25 14.63 0.459 0.783 2.6 3.1 3.9 4.7 2.0 MIN. 2.3 MIN. 27,166 38,757 20.37 29.07 1.113 1.792 3.7 4.4 5.5 6.6 2.8 MIN. 3.0 MIN. 53,288 76,024 39.98 57.04 2.301 3.517 5.2 6.2 7.7 9.3 3.0 MIN. 3.0 MIN. 98,463 140,474 73.84 105.34 4.250 6.496 7.0 8.4 10.5 12.6	
	X (FT.)	0.9 MIN.	1.2 MIN.	1.6 MIN.	2.4 MIN.	3.0 MIN.	3.0 MIN.	649 19,472 .25 14.63 .459 0.783 .6 3.1 .9 4.7 MIN. 2.3 MIN. 166 38,757 .37 29.07 .113 1.792 .7 4.4 .5 6.6 MIN. 3.0 MIN. 288 76,024 .98 57.04 .301 3.517 .2 6.2 .7 9.3 MIN. 3.0 MIN. 463 140,474 .84 105.34 .250 6.496 .0 8.4 .0.5 12.6
	THRUST (LBS.)	4,863	10,047	17,286	36,772	63,894	98,463	140,474
	BEARING AREA (FT. <sup>2</sup> )	3.65	7.53	12.96	27.58	47.91	20" 24" 13,649 19,472 10.25 14.63 0.459 0.783 2.6 3.1 3.9 4.7 2.0 MIN. 2.3 MIN 27,166 38,757 20.37 29.07 1.113 1.792 3.7 4.4 5.5 6.6 2.8 MIN. 3.0 MIN 53,288 76,024 39.98 57.04 2.301 3.517 5.2 6.2 7.7 9.3 3.0 MIN. 3.0 MIN 98,463 140,474 73.84 105.34 4.250 6.496 7.0 8.4 10.5 12.6	
90° BEND	CONCRETE (YDS.3)	0.068	0.203	0.459	1.360	2.561	4.250	6.496
90 BEND	H (FT.)	1.6	2.2	3.0	4.3	5.7	7.0	8.4
	W (FT.)	2.3	3.4	4.4	6.4	8.5	10.5	12.6
	X (FT.)	1.2 MIN.	1.7 MIN.	2.2 MIN.	3.0 MIN.	3.0 MIN.	3.0 MIN.	3.0 MIN.

#### NOTES:

- CONCRETE SHALL BE KEPT AT SUFFICIENT DISTANCE FROM JOINT FOR REMOVAL OF ALL JOINT ACCESSORIES INCLUDING BOLTS.
- 2. ALL BEARING SURFACES TO BE CARRIED TO UNDISTURBED SOIL.
- THIS TABLE SHOWS THE MINIMUM SIZE THRUST BLOCKS FOR SOIL BEARING PRESSURE OF 2000 PSF AND AN INTERNAL PRESSURE OF 190 PSI. COVER TO T.O.P. IS 3 FEET FOR 12" AND SMALLER MAINS; 4 FEET FOR 16" AND LARGER MAINS.
- 4. FITTINGS SHALL BE COMPLETELY POLYWRAPPED PRIOR TO POURING THRUST BLOCKS.

WARNING - POOR AND WET SOIL (SILTY SOILS, CLAY, MUCK AND PEAT) WILL REQUIRE LARGER THRUST BLOCKS.



JUL 2018

THRUST BLOCKS FOR BENDS

2.07

REVISIONS

DATE DESCRIPTION DATE DESCRIPTION

CHRISTOPHER K. MARTIN, P.E. P.E. LICENSE NUMBER 66598
AYRES ASSOCIATES
8875 HIDDEN RIVER PKWY, SUITE 200
TAMPA, FL 33637
CERTIFICATE OF AUTHORIZATION 4356

CITY OF TAMPA
TRANSPORTATION DEPARTMENT

CITY PROJECT NO. COUNTY FINANCIAL PROJECT ID


1001221 HILLSBOROUGH 436639-1-58-01


WATER MAIN STANDARD DETAILS (2) SHEET NO.

U-13

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- 1. SIZE (D), SHALL BE THE BRANCH SIZE OF TEES.
- CONCRETE SHALL BE KEPT AT SUFFICIENT DISTANCE FROM JOINT FOR REMOVAL OF ALL JOINT ACCESSORIES INCLUDING BOLTS.
- ALL BEARING SURFACES TO BE CARRIED TO UNDISTURBED SOIL.
- THIS TABLE SHOWS THE MINIMUM SIZE THRUST BLOCKS FOR SOIL BEARING PRESSURE OF 2000 PSF AND AN INTERNAL PRESSURE OF 190 PSI.
- 5. TEES SHALL BE COMPLETELY POLYWRAPPED PRIOR TO POURING THRUST BLOCKS.

WARNING - COVER TO T.O.P. IS 3 FEET FOR 12" AND SMALLER MAINS; 4 FEET FOR 16" AND LARGER MAINS. POOR AND WET SOIL (SILTY SOILS, CLAY, MUCK AND PEAT) WILL REQUIRE LARGER THRUST BLOCKS.

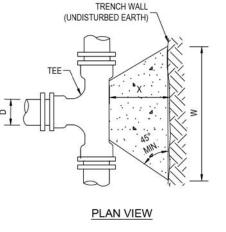

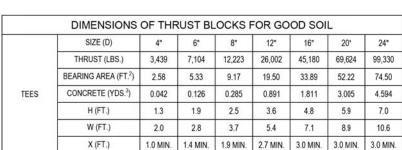LAST REVISION JUL 2018

THRUST BLOCKS FOR TEES

2.09

TRENCH WALL (UNDISTURBED EARTH)  PLUG  PLUG  A  A  A  A  A  A  A  A  A  A  A  A  A	TRENCH WALL (UNDISTURBED EARTH)  PLUG  PLUG
PLAN VIEW	SECTION

	DIMENSIONS	OF THE	RUST BL	OCKS F	OR GO	OD SOI	L	
	SIZE (D)	4"	6"	8"	12"	16"	20"	24"
	THRUST (LBS.)	3,439	7,104	12,223	26,002	45,180	69,624	99,330
	BEARING AREA (FT. <sup>2</sup> )	2.58	5.33	9.17	19.50	33.89	52.22	74.50
PLUG	CONCRETE (YDS.3)	0.042	0.126	0.285	0.891	1.811	3.005	4.594
	H (FT.)	1.3	1.9	2.5	3.6	4.8	5.9	7.0
	W (FT.)	2.0	2.8	3.7	5.4	7.1	8.9	10.6
	X (FT.)	1.0 MIN.	1.4 MIN.	1.9 MIN.	2.7 MIN.	3.0 MIN.	3.0 MIN.	3.0 MIN.

#### NOTES:

- 1. CONCRETE SHALL BE KEPT AT SUFFICIENT DISTANCE FROM JOINT FOR REMOVAL OF ALL JOINT ACCESSORIES INCLUDING BOLTS.
- ALL BEARING SURFACES TO BE CARRIED TO UNDISTURBED SOIL
- THIS TABLE SHOWS THE MINIMUM SIZE THRUST BLOCKS FOR SOIL BEARING PRESSURE OF 2000 PSF AND AN INTERNAL PRESSURE OF 190 PSI. COVER TO T.O.P. IS 3 FEET FOR 12" AND SMALLER MAINS; 4 FEET FOR 16" AND LARGER MAINS.
- 4. PLUGS SHALL BE COMPLETELY POLYWRAPPED PRIOR TO POURING THRUST BLOCKS.

WARNING - POOR AND WET SOIL (SILTY SOILS, CLAY, MUCK AND PEAT) WILL REQUIRE LARGER THRUST BLOCKS.



LAST REVISION JUL 2018

THRUST BLOCKS FOR PLUGS

2.08

	R	CHRISTOPHER K. MARTIN, P.E.		
DATE	DESCRIPTION	DATE	DESCRIPTION	P.E. LICENSE NUMBER 66598 AYRES ASSOCIATES 8875 HIDDEN RIVER PKWY, SUITE 200 TAMPA, FL 33637
				CERTIFICATE OF AUTHORIZATION 4356

CITY OF TAMPA TRANSPORTATION DEPARTMENT						
CITY PROJECT NO. COUNTY FINANCIAL PROJECT ID						
	1001221	1001221 HILLSBOROUGH				


WATER MAIN


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STANDARD DETAILS (3) 3/3/2020 12:02:50 PM Default





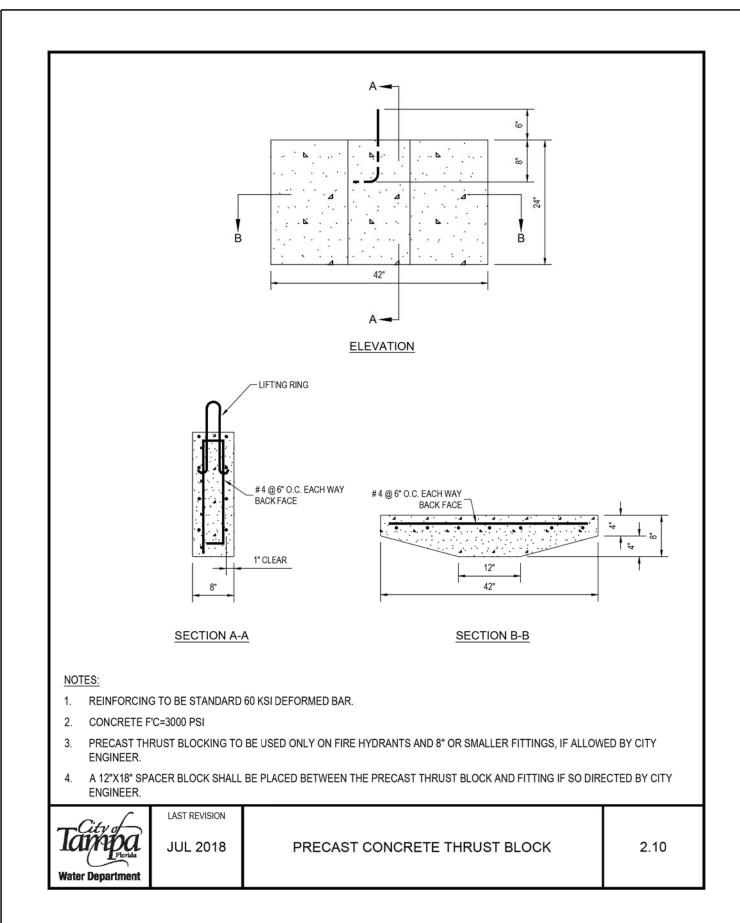

	R	CHRISTOPHER K. MARTIN, P.E.	
DATE	DESCRIPTION	P.E. LICENSE NUMBER 66598	
			AYRES ASSOCIATES
			8875 HIDDEN RIVER PKWY, SUITE 200
			TAMPA, FL 33637
			CERTIFICATE OF AUTHORIZATION 4356

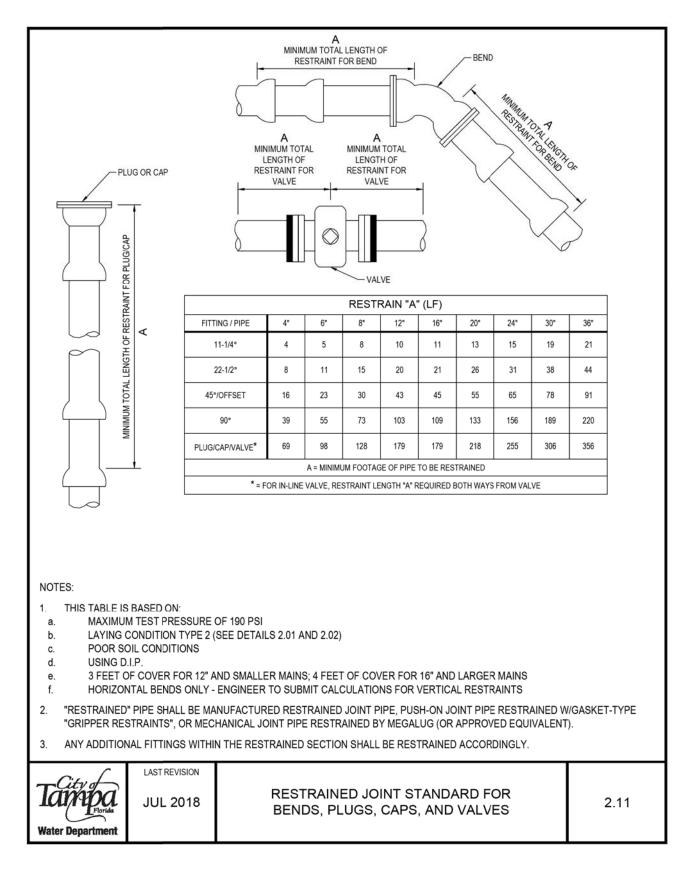CITY OF TAMPA
TRANSPORTATION DEPARTMENT


CITY PROJECT NO. COUNTY FINANCIAL PROJECT ID

1001221 HILLSBOROUGH 436639-1-58-01

WATER MAIN STANDARD DETAILS (4) NO. U-15

SHEET

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#### NOTES:

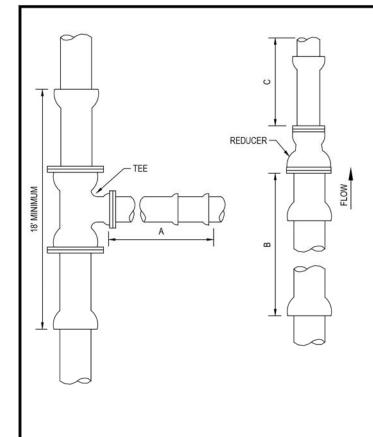- THIS TABLE IS BASED ON:
- MAXIMUM TEST PRESSURE OF 190 PSI
- LAYING CONDITION TYPE 2 (SEE DETAILS 2.01 AND 2.02) b.
- POOR SOIL CONDITIONS C.
- USING D.I.P. d.
- 3 FEET OF COVER FOR 12" AND SMALLER MAINS; 4 FEET OF e. **COVER FOR 16" AND LARGER MAINS**
- HORIZONTAL BENDS ONLY ENGINEER TO SUBMIT CALCULATIONS FOR VERTICAL RESTRAINTS
- 2. RESTRAINT FOR REDUCERS: IF "C" STRAIGHT RUN OF PIPE DOWNSTREAM OF REDUCER NOT AVAILABLE. THE RESTRAIN "B" UPSTREAM OF REDUCER.
- "RESTRAINED" PIPE SHALL BE MANUFACTURED RESTRAINED JOINT PIPE, PUSH-ON JOINT PIPE RESTRAINED W/GASKET-TYPE "GRIPPER RESTRAINTS", OR MECHANICAL JOINT PIPE RESTRAINED BY MEGALUG (OR APPROVED EQUIVALENT).
- ANY ADDITIONAL FITTINGS WITHIN THE RESTRAINED SECTION SHALL BE RESTRAINED ACCORDINGLY.


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Water Denartment	ı


LAST REVISION

JUL 2018

**RESTRAINED JOINT STANDARD** FOR TEES AND REDUCERS

2.12A

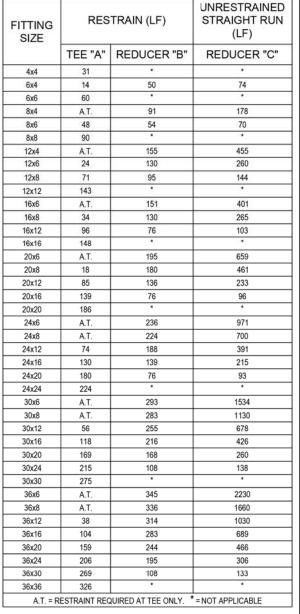

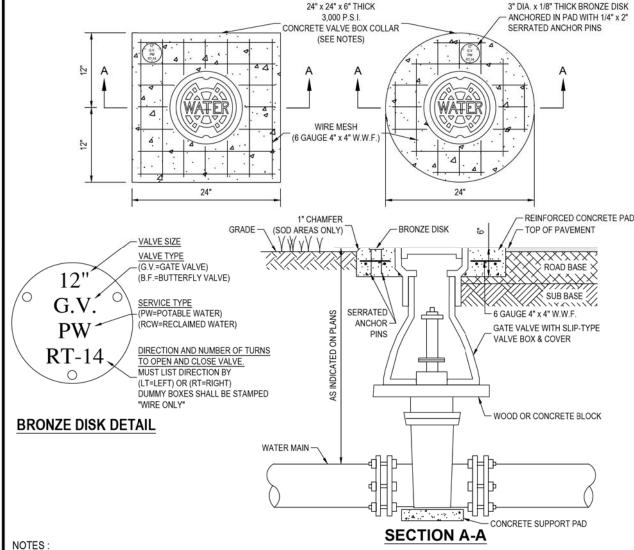

- CIRCULAR OR SQUARE CONCRETE PAD REQUIRED FOR ALL VALVE BOX INSTALLATIONS.
- CAST IRON VALVE BOXES SHALL BE FIRMLY SUPPORTED AND CENTERED AND PLUMB OVER THE OPERATING NUT OF THE VALVE. VALVE BOX COVER SHALL BE FLUSH WITH THE SURFACE OF THE FINISHED PAVEMENT, OR GRADE OR AT SUCH OTHER LEVEL AS MAY BE DIRECTED BY THE DEPARTMENT.
- "BLUE" WATER VALVE LOCATE MARKERS REQUIRED FOR ALL VALVE INSTALLATIONS.
- EMBED BRONZE VALVE INFO DISK INTO CONCRETE VALVE BOX COLLAR.
- ALL MATERIALS SHALL BE IN ACCORDANCE WITH THE LATEST T.W.D. APPROVED MATERIAL SPECIFICATIONS.
- IF VALVE IS LOCATED WITHIN A SIDEWALK CONCRETE COLLAR MAY BE ELIMINATED AND DISK SET FLUSH DIRECTLY IN SIDEWALK.
- BRONZE DISK REQUIRED FOR ALL VALVES AND DUMMY BOXES.



**JUL 2018** 

VALVE INSTALLATION W/VALVE BOX & PAD FOR DI OR CI PIPE


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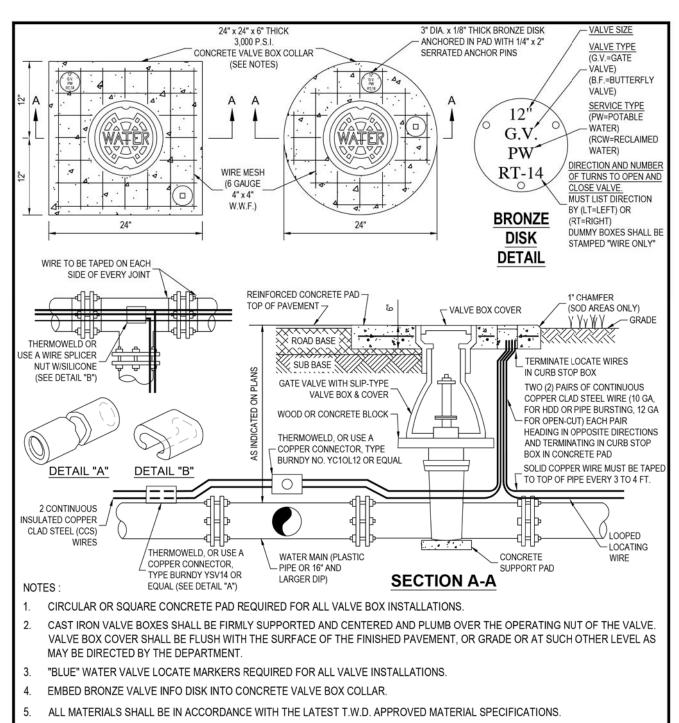
	REVIS	CHRISTOPHER K. MARTIN, P.E.		
DATE	DESCRIPTION	DATE	DESCRIPTION	P.E. LICENSE NUMBER 66598
				AYRES ASSOCIATES 8875 HIDDEN RIVER PKWY, SUITE 200 TAMPA, FL 33637 CERTIFICATE OF AUTHORIZATION 435

CITY OF TAMPA TRANSPORTATION DEPARTMENT				
CITY PROJECT NO. COUNTY		FINANCIAL PROJECT ID		
1001221	HILLSBOROUGH	436639-1-58-01		

WATER MAIN STANDARD DETAILS (5) SHEET NO. U-16

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- 6. IF VALVE IS LOCATED WITHIN A SIDEWALK CONCRETE COLLAR MAY BE ELIMINATED AND DISK SET FLUSH DIRECTLY IN SIDEWALK.
- BRONZE DISK REQUIRED FOR ALL VALVES AND DUMMY BOXES.
- 8. ALL CONNECTIONS SHALL BE SEALED WITH A BITUMINOUS COATING FOR CORROSION PROTECTION.

Tarripa Water Department

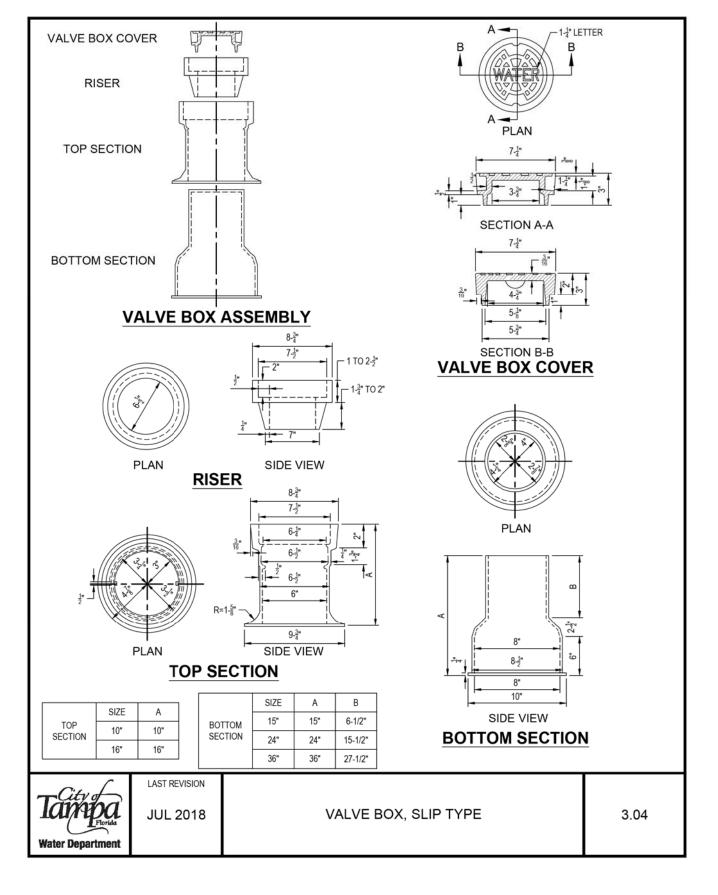JUL 2018

VALVE INSTALLATION W/VALVE BOX & PAD FOR PLASTIC PIPE WITH DOUBLE COPPER TRACER WIRE ON PIPE

3.02

REVISIONS

DATE DESCRIPTION DATE DESCRIPTION P.E. LICENSE NUMBER 66598

AYRES ASSOCIATES
8875 HIDDEN RIVER PKWY, SUITE 200
TAMPA, FL 33637
CERTIFICATE OF AUTHORIZATION 4356

CITY OF TAMPA TRANSPORTATION DEPARTMENT			
	CITY PROJECT NO.	COUNTY	FINANCIAL PROJECT ID
	1001221	HILLSBOROUGH	436639-1-58-01


WATER MAIN
STANDARD DETAILS (6)


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#### NOTES:

- 1. FIRE HYDRANT BARREL ABOVE THE GROUND LINE SHALL BE PAINTED WITH A HIGH-GRADE ENAMEL PAINT, FEDERAL SAFETY YELLOW (OSHA APPROVED), AND THE HYDRANT BONNET SHALL BE PAINTED OSHA GREEN.
- 2. CONCRETE SLAB MAY BE ELIMINATED IN AREAS WHERE HYDRANT IS SET IN SIDEWALK AND SIDEWALK HAS BEEN INSTALLED PRIOR TO FINAL ACCEPTANCE OF THE HYDRANT.
- THRUST RESTRAINT FOR HYDRANT:
- a) HYDRANT SHALL BE FIRMLY SUPPORTED UNDER ELBOW IN ALL METHODS BY SUPPORT BLOCK
- b) ALL BACKFILL SHALL BE THOROUGHLY COMPACTED UNDER SUPPORT BLOCK AND UNDER THRUST COLLAR
- c) ALL HYDRANT LEADS SHALL BE RESTRAINED BY MEGALUGS OR EQUIVALENT MECHANICAL RESTRAINTS
- PROTECTION POSTS ARE REQUIRED WHEN HYDRANT IS LESS THAN 6 FEET FROM EDGE OF PAVEMENT, OR AS DIRECTED BY THE ENGINEER.
- 5. FOR PVC MAINS, INSTALL CONCRETE SUPPORT BLOCK UNDER ALL HYDRANT TEES



JUL 2018

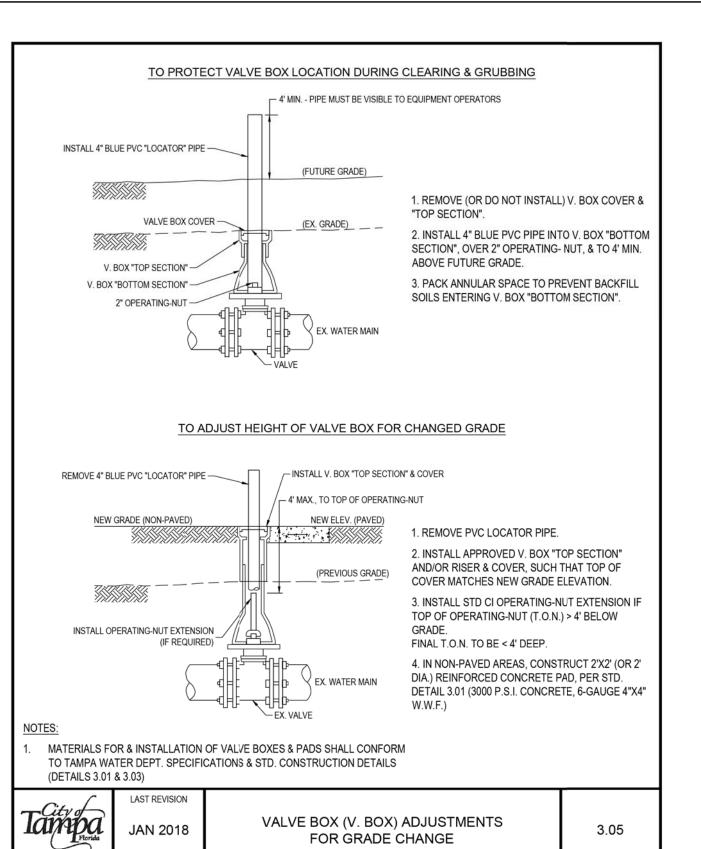LAST REVISION

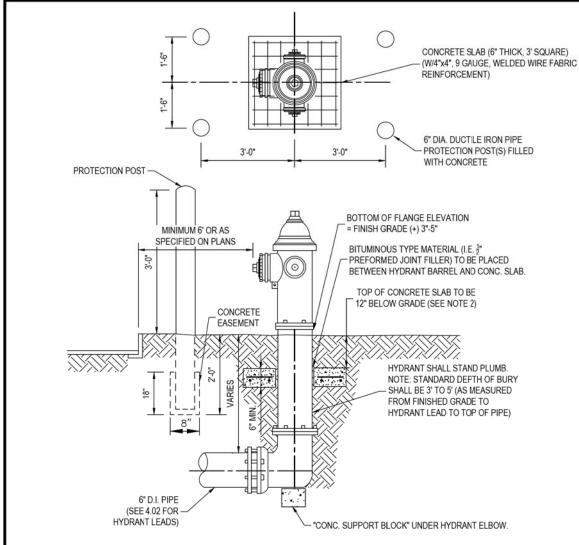FIRE HYDRANT INSTALLATION

4.01

REVISIONS			CHRISTOPHER K. MARTIN, P.E.	
DATE	DESCRIPTION	DATE	DESCRIPTION	P.E. LICENSE NUMBER 66598
				AYRES ASSOCIATES
				8875 HIDDEN RIVER PKWY, SUITE 200
				TAMPA, FL 33637
				CERTIFICATE OF AUTHORIZATION 435

CITY OF TAMPA TRANSPORTATION DEPARTMENT					
CITY PROJECT NO.	COUNTY	FINANCIAL PROJECT ID			
1001221	HILLSBOROUGH	436639-1-58-01			


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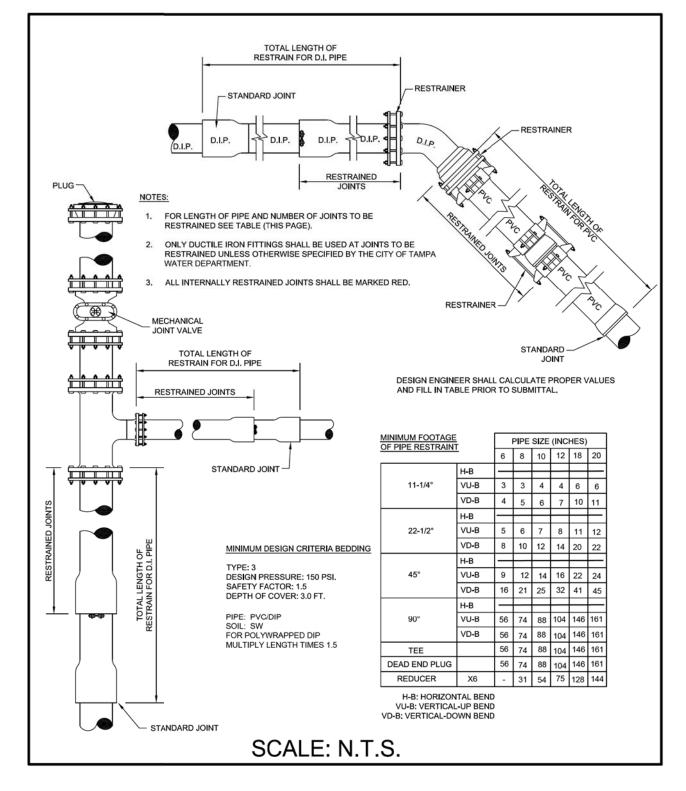
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Water Department







REVISIONS				CHRISTOPHER K. MARTIN, P.E.
DATE	DESCRIPTION	DATE	DESCRIPTION	P.E. LICENSE NUMBER 66598
				AYRES ASSOCIATES
				8875 HIDDEN RIVER PKWY, SUITE 200
				TAMPA, FL 33637
				CERTIFICATE OF AUTHORIZATION 4350
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CITY OF TAMPA
TRANSPORTATION DEPARTMENT

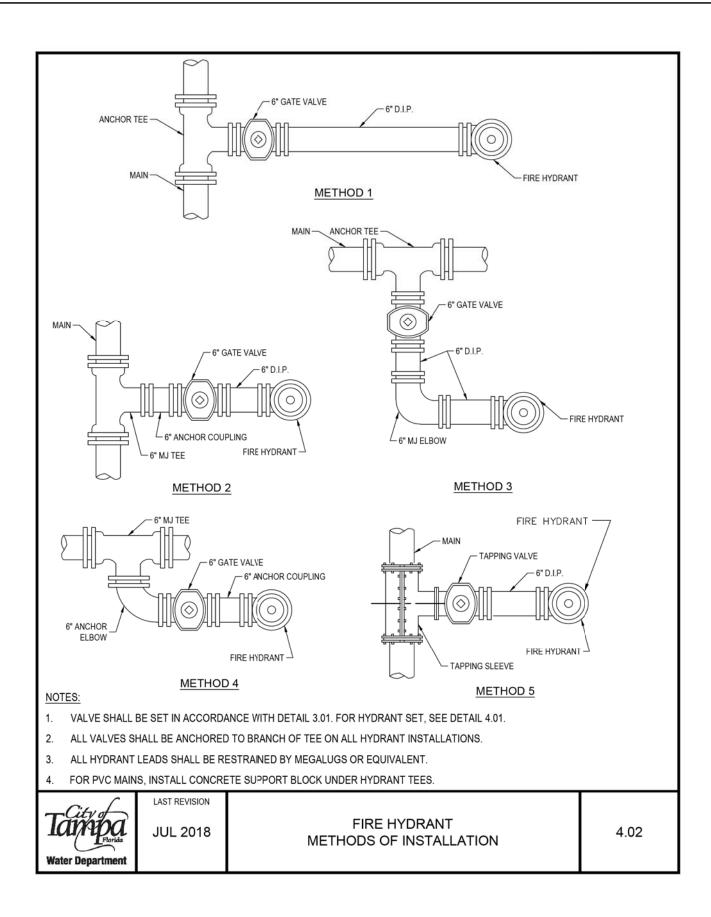CITY PROJECT NO. COUNTY FINANCIAL PROJECT ID

1001221 HILLSBOROUGH 436639-1-58-01

WATER MAIN STANDARD DETAILS (8) NO. U-19

SHEET

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#### CONTRACT PLANS COMPONENTS

INDEX OF ROADWAY PLANS

ROADWAY PLANS SIGNING AND PAVEMENT MARKING PLANS SIGNALIZATION PLANS LANDSCAPE ARCHITECTURE PLANS UTILITY WORK BY HIGHWAY CONTRACTOR AGREEMENT PLANS


## STATE OF FLORIDA CITY OF TAMPA

### WALK-BIKE LAP PROJECT

CITY PROJECT NO. 1001221 FINANCIAL PROJECT ID 436639-1-58-01 (FEDERAL FUNDS) HILLSBOROUGH COUNTY

E COLUMBUS DR FROM N NEBRASKA AVE (SR45) TO 14TH ST

#### SHEET NO. SHEET DESCRIPTION KEY SHEET SIGNATURE SHEET SUMMARY OF PAY ITEMS 4 - 5 TYPICAL SECTION 6 - 7 TYPICAL SECTION DETAILS 8 - 10 SUMMARY OF DRAINAGE STRUCTURES PROJECT CONTROL 12 GENERAL NOTES ROADWAY PLANS 13 - 17 ROADWAY PROFILES 18 - 22 23 - 43 DRAINAGE STRUCTURES 44 - 46 DRAINAGE DETAILS 47 - 49 TREE WELL DETAILS DATA TABLE 50 - 54 INTERSECTION LAYOUTS 55 - 63 GRADING DETAILS 64 - 83 CROSS SECTIONS 84 - 99 DRIVEWAY HALF-SECTIONS 100 - 101 TEMPORARY TRAFFIC CONTROL PLANS UTILITY ADJUSTMENTS 102 - 106 SUMMARY OF QUANTITIES 50-1 - 50-13

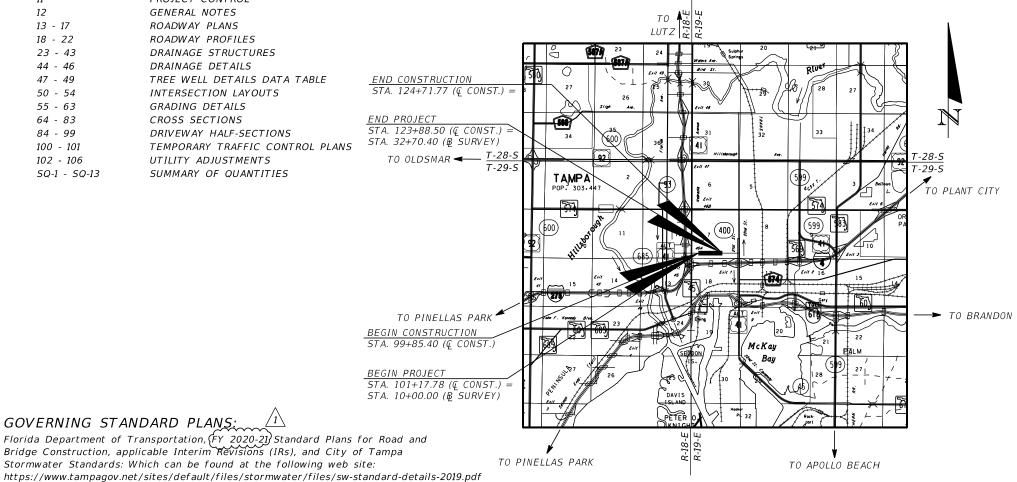

REVISION 1 PLANS 07/09/20

LOCATION OF PROJECT

#### ROADWAY PLANS ENGINEER OF RECORD:

JEFFREY SIEWERT, P.E. P.E. LICENSE NUMBER 39196 AYRES ASSOCIATES 8875 HIDDEN RIVER PKWY, SUITE 200 TAMPA, FL 33637 (813) 978-8688 CERTIFICATE OF AUTHORIZATION 4356

#### PROJECT MANAGER:

NINA MABILLEAU, E.I.

REVISIONS:

/1\ Roadway Sheets 1 & 2A

## GOVERNING STANDARD SPECIFICATIONS:

following website: http://www.fdot.gov/design/standardplans

Construction of Wastewater Facilities, go to the web page site:

GOVERNING STANDARD PLANS:

found at the following web site:

Florida Department of Transportation July 2020 Standard Specifications for Road and Bridge Construction at the following website: http://www.fdot.gov/programmanagement/Implemented/SpecBooks

For the City of Tampa Water Department Engineering Standard Details can be

Standard Plans for Road Construction and associated IRs are available at the

For the CIty of Tampa Wastewater Department Technical Standards Guideline for

 $https://www.tampagov.net/sites/default/files/water/files/technical\_standard\_details\_0.pdf$ 


https://www.tampagov.net/sites/default/files/wastewater/files/TECHNICAL STANDARDS GUIDELINE FOR CONSTRUCTION OF WASTEWATER FACILITIES JULY 2014 VERSION 6.PDF

KEY SHEET REVISIONS DESCRIPTION
Added Sheet Number 2A, Revised Standard
Specifications and Standard Plans Date

FISCAL SHEET YEAR NO. 21

7/8/2020 4:43:48 PM Revision 1 L:\67026000 E Columbus Drive City of Tampa\43663915801\roadway\KEYSRD01.dgi

AYTONA BEACH

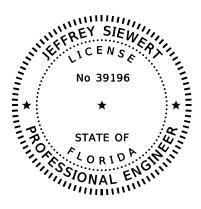

THIS ITEM HAS BEEN DIGITALLY SIGNED AND SEALED BY

ON THE DATE ADJACENT TO THE SEAL

PRINTED COPIES OF THIS DOCUMENT ARE NOT CONSIDERED SIGNED AND SEALED AND THE SIGNATURE MUST BE VERIFIED ON ANY ELECTRONIC COPIES.

AYRES ASSOCIATES INC 8875 HIDDEN RIVER PKWY, SUITE 200 TAMPA, FL 33637 CERTIFICATE OF AUTHORIZATION: 4356 JEFFREY SIEWERT, P.E. NO. 39196

THE ABOVE NAMED PROFESSIONAL ENGINEER SHALL BE RESPONSIBLE FOR THE FOLLOWING SHEETS IN ACCORDANCE WITH RULE 61G15-23.004, F.A.C.

SHEET NO. SHEET DESCRIPTION

1 KEY SHEET
2A SIGNATURE SHEET

		REVISIONS		Ji
DATE	DESCRIPTION	DATE	DESCRIPTION	P.
07-09-20	ADDED SHEET			A 8 7 C

JEFFREY SIEWERT, P.E.
P.E. LICENSE NUMBER 39196
AYRES ASSOCIATES
8875 HIDDEN RIVER PKWY, SUITE 200
TAMPA, FL 33637
CERTIFICATE OF AUTHORIZATION 4356

CITY OF TAMPA
TRANSPORTATION DEPARTMENT

CITY PROJECT NO. COUNTY FINANCIAL PROJECT ID

1001221 HILLSBOROUGH 436639-1-58-01

SIGNATURE SHEET

SHEET NO.

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## CONTAMINATION LOCATOR MAP

Search Criteria: Sites in tampa. Cleanup types: ▲ Brownfields ▲ Petroleum ▲ Superfund

For further information, please call the Waste Cleanup Hotline at (866)282-0787. If you wish to search again, please click here



# Phase I Environmental Assessment Report

Performed at:

Former Danny's Generators Site 1023 East Columbus Drive Tampa, FL 33605

**Report Prepared For:** 

Mr. Jeff Siewert, Senior Project Manager Ayres Associates 8875 Hidden River Parkway – Suite 200 Tampa, Florida 33637-1035

Report Prepared By:

OHC ENGINEERING

OHC Environmental Engineering, Inc. 101 South Hoover Blvd, Suite 101 Tampa, Florida 33609

OHC Project #190238-ES

November 24, 2019

November 24, 2019 Mr. Jeff Siewert – Ayres Associates 1023 East Columbus Drive Phase I Environmental Assessment OHC Project No. 190238-ES

November 17, 2019

Mr. Jeff Siewert Senior Project Manager Ayres Associates 8875 Hidden River Parkway – Suite 200 Tampa, FL 33637-1035

> RE: Phase I Environmental Site Assessment Report Danny's Generators Site 1023 East Columbus Drive Tampa, Hillsborough County, FL 33605

Dear Mr. Siewert,

OHC Environmental Engineering, Inc., (OHC), is pleased to submit this Phase I Environmental Site Assessment Report for the above referenced property. The following information summarizes our findings.

#### **Executive Summary**

OHC was retained by Mr. Jeff Siewert, Senior Project Manager of Ayres Associates, and acting project manager for the City of Tampa's future right of way construction to conduct a Phase I Environmental Assessment of one tax parcel totaling approximately one eighth of an acre located on the corner of East Columbus Drive and North 12<sup>th</sup> Street. The tax parcel PIN ID # is A-18-29-19-51A-000001-00001.0 OHC performed the Phase I Environmental Site Assessment of the property formerly operating as Danny's Generators, Inc. (DGI), herein known as the property, or site. The property is currently an active commercial office and apartment facility which consists of one building encompassing approximately 1950 square feet. The property is currently owned by Deborah Lisa Ramos.

The purpose of this Phase I Environmental Assessment (ESA) is to assess current site conditions and render an opinion as to the presence of exterior recognized environmental conditions (REC) at the property. The building's interior was not accessible, and therefore not inspected. OHC performed this Phase I in general conformance with the scope and limitations of the ASTM



November 24, 2019 Mr. Jeff Siewert – Ayres Associates 1023 East Columbus Drive Phase I Environmental Assessment OHC Project No. 190238-ES

Practice E1527-13 and 40 CFR part 312. The following findings which are potential REC's are listed below, along with supporting opinions and recommendations:

Finding 1) The site address is listed as a leaking underground storage tank (LUST) site, a DWM Contaminated site, a Historic Automobile Service site, a Florida UST site and a Cleanup site in the EDR Radius Map Report. The Florida DEP facility site ID # is 8508982 and the Florida DEP Cleanup Site Key # is 59734501. The site is listed as a closed site, therefore it is not an active retail site. The site is listed as having an open discharge cleanup status from a discharge reported on 3/29/1991. This means the cleanup is not completed. Therefore, this discharge represents a REC. There are monitoring wells located in the concrete slab and sidewalk at the site which may be in the proposed right of way construction. Therefore, these well locations should be properly surveyed for location and closed prior to the construction activities to prevent any accidental release of hazardous material contacting the wellhead locations. The well closure should be coordinated with the EPC case manager. The proposed construction involves sidewalk and road reconstruction which is expected to impact depths from grade to approximately three feet below grade. Therefore, if any soil or groundwater contamination exists (>3 feet below grade) in the vicinity of the future remediation area, it would not be expected to impact the proposed construction activities.

No other REC's were identified on the exterior of the site. The undersigned declares that he meets the definition of Environmental Professional as stated in 40 CFR part 312 and that he has conducted the assessment in accordance with same. OHC appreciates the opportunity to be of service to you on this project. If you have any further questions, please contact me.

Respectfully Submitted, OHC ENVIRONMENTAL ENGINEERING, INC.

Thomas Martinelli

Environmental Professional



### **PHASE I ASSESSMENT**

*OHC PROJECT #:* 190238-ES

**CLIENT NAME:** Mr. Jeff Siewert

**Ayres Associates** 

**PROJECT LOCATION:** Danny's Generators

1023 East Columbus Drive

**Tampa, FL 33605** 

*DATE OF SURVEY:* November 12, 2019

**CONSULTING FIRM:** OHC Environmental Engineering, Inc.

101 South Hoover Blvd, Suite101

Tampa, Florida 33609

**ENVIRONMENTAL** 

**PROFESSIONAL:** Thomas Martinelli

OHC PROJECT MANAGER: Christina Jones

**CONSULTANT:** 

James F. Rizk, CIH



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#### **EXECUTIVE SUMMARY**

OHC was retained by Mr. Jeff Siewert, Senior Project Manager Ayres Associates, and acting project manager for the City of Tampa's future right of way construction at the above referenced property, to conduct a Phase I Environmental Assessment of one tax parcel totaling approximately one eighth of an acre located on the corner of East Columbus Drive and North 12<sup>th</sup> Street. The tax parcel ID # is A-18-29-19-51A-000001-00001.0 OHC performed the Phase I Environmental Site Assessment of the property formerly operating as Danny's Generators, Inc. (DGI), herein known as the property, or site. The property is currently an active commercial office and apartment facility which consists of one building encompassing approximately 1950 square feet. The property is currently owned by Deborah Lisa Ramos.

The purpose of this Phase I Environmental Assessment (ESA) is to assess current site conditions and render an opinion as to the presence of exterior recognized environmental conditions (REC) at the property. The building's interior was not accessible, and therefore not inspected. OHC performed this Phase I in general conformance with the scope and limitations of the ASTM Practice E1527-13 and 40 CFR part 312. The following findings which are potential REC's are listed below, along with supporting opinions and recommendations:

Finding 1) The site address is listed as a leaking underground storage tank (LUST) site, a DWM Contaminated site, a Historic Automobile Service site, a Florida UST site and a Cleanup site in the EDR Radius Map Report. The Florida DEP facility site ID # is 8508982 and the Florida DEP Cleanup Site Key # is 59734501. The site is listed as a closed site, therefore it is not an active retail site. The site is listed as having an open discharge cleanup status from a discharge reported on 3/29/1991. This means the cleanup is not completed. Therefore, this discharge represents a REC. There are monitoring wells located in the concrete slab and sidewalk at the site which may be in the proposed right of way construction. Therefore, these well locations should be properly surveyed for location and closed prior to the construction activities to prevent any accidental release of hazardous material contacting the wellhead locations. The well closures should be coordinated with the EPC case manager. The proposed construction involves sidewalk and road reconstruction which is expected to impact depths from grade to approximately three feet below grade. Therefore, if any residual soil or groundwater contamination



exists (>3 feet below grade) in the vicinity of the future remediation area, it would not be expected to impact the proposed construction activities.

#### 1.0 INTRODUCTION

OHC Environmental Engineering, Inc. (OHC) was retained by Mr. Jeff Siewert, Senior Project Manager of Ayres Associates, and City of Tampa's construction project manager for the future right of way improvements at the site, ("user"), to prepare a Phase I Environmental Site Assessment of the subject property ("site") in general conformance with ASTM Standard E1527-13 and 40 CFR part 312. This report documents OHC's findings from our Phase I Investigation of the site. The site currently consists of one tax parcel which is zoned Commercial Class 4. The site is currently an active commercial office and apartment type structure. The site is located in a primarily commercial/light industrial setting with residential properties nearby.

#### 1.1 Purpose

The purpose of this Phase I Environmental Site Assessment (ESA) is to determine whether there are "recognized environmental conditions" (REC), historical REC's (HREC) or controlled REC's (CREC) on the property, which may have an impact on the future construction along the City of Tampa right of way at the site and liability of the user from a governmental or private party. The purpose of this assessment is to evaluate current exterior environmental conditions. Since the purpose of this assessment is to evaluate potential subsurface contamination issues present at the proposed right of way construction, access to the interior of the building on site was not granted by the owner. This ESA will therefore document current environmental conditions so either party, user or owner, will be able to establish their impact to the site, if any. Evidence for recognized environmental conditions were sought through environmental and historical records searches, interviews, and a site reconnaissance, etc.

#### 1.2 Project Scope

This ESA is designed to generally conform to the American Society for Testing and Materials (ASTM) Practice E 1527-13, Standard Practice for Environmental Site Assessments: Phase I Environmental Site Assessment Process in terms of levels of inquiry, standard regulatory record search distances and site reconnaissance



methodology. The All Appropriate Inquiry document outlined in 40 CFR 312 was also referenced in preparing this report.

The following issues were not evaluated within the scope of this Phase I ESA: 1) regulatory compliance or permitting of facility operations, 2) off-site waste disposal tracking, 3) integrity of on-site sewage disposal systems, 4) geotechnical/structural concerns with underlying soil or fill, 5) wetlands delineation, 6) the potential for naturally-occurring elements or their products that exceed applicable regulatory standards, 7) radon, 8) underground storage tank testing, 9) electromagnetic fields, 10) agricultural practices, 11) the potential for biological hazards and (12) building interior.

Phase I ESA's do not generally include field or laboratory analyses of building materials, air, soil or water samples, which may yield additional information unforeseen in a Phase I ESA. OHC completed this study under the regulatory framework known to be in effect as of the date of this report; and the investigation, findings and conclusions as set forth are predicated upon those laws and regulations.

#### 1.3 Project Limitations

According to ASTM Practice E 1527-13, a Phase I ESA is intended to reduce, not necessarily eliminate, uncertainty regarding the potential environmental conditions in connection with the subject property. The standard states that it recognizes "reasonable limits of time and cost" in this process. Consequently, assessments cannot be judged solely on whether they missed some existing contamination, but instead on "the reasonableness of the judgments made at the time and under the circumstances in which they were made."

This report is based upon the application of scientific principles and professional judgment to certain facts with resultant subjective interpretations. Professional judgments expressed herein are based on the facts currently available within the limit or scope of work, budget and schedule. The work described in this report was carried out in accordance with the Terms and Conditions in the proposal. An environmental lien and activity use limitation search was not performed or requested by the user.

In preparing this report, OHC may have relied on certain information provided by Environmental Data Resources (EDR), federal, state and local officials and other parties referenced therein, and on information contained in the files of state agencies, local agencies, or both, available to OHC at the time of this site assessment. Although there



may have been some degree of overlap in the information provided by these various sources, OHC did not attempt to independently verify the accuracy or completeness of all the information reviewed or received during the course of this site assessment.

Observations were made of the site and of the structure exterior on the site as indicated in this report. While access to interior portions of the site or to structures on the site was unavailable or limited, OHC renders no opinion as to the presence of indirect evidence relating to petroleum substance, hazardous substances, or both, in that portion of the site and structure. In addition, OHC renders no opinion as to the presence or indirect evidence relating to hazardous material storage or oil, where direct observation of the interior/exterior walls, ground surface, floors, ceiling or a structure is obstructed by objects or vegetation covering on or over these surfaces.

As part of this assessment, OHC has submitted a request for an informal file review with the Hillsborough County Environmental Protection Commission (EPC) and Fire Marshalls offices and the City of Tampa Fire Marshalls office. Information from these inquiries are found in Attachment V.

#### 1.4 Special Terms and Conditions

Terms as defined by ASTM E 1527 are used, as appropriate, in this report. ASTM defines recognized environmental conditions as: "the presence or likely presence of any hazardous substances or petroleum products in, on or at a property (1) due to a release to the environment, (2) under conditions indicative of a release to the environment or (3) under conditions that pose a material threat of a future release to the environment. The term includes hazardous substances or petroleum products even under conditions in compliance with laws. The term is not intended to include de-minimus conditions that generally do not present a material risk of harm to public health or the environment and that generally would not be the subject of an enforcement action if brought to the attention of appropriate governmental agencies. Conditions determined to be de-minimus are not recognized environmental conditions. Within the context of the ASTM standard, the "site" is the Danny's Generators property and the "user" of this report is Mr. Jeff Siewert. Ms. Deborah Lisa Ramos, owner of the site, declined to complete the User Questionnaire found in Attachment I. OHC would normally rely on information from the questionnaire to assist in determining if REC's were present on site.



#### 2.0 SITE DESCRIPTION

#### 2.1 Location and Legal Description

The subject property, consisting of the aforementioned tax parcel, is described as approximately one eighth of an acre of commercially developed property. The site is located at 1023 East Columbus Drive, Ybor City section of the City of Tampa, Hillsborough County, Florida, herein known as the property, or site. The property is currently owned by Deborah Lisa Ramos. Refer to the tax assessment/site maps in Attachment II and site photographs in Attachment III for visual reference.

#### 2.2 Environmental Setting

The site is located in a mixed light industrial/commercial/residential setting. According to the EDR FEMA Flood Hazard Area Map, the site is not located within a flood plain. According to the EDR provided wetland inventory map, no wetland areas are present. According to the EDR provided information from the 1994 United States Geological Survey, the rock stratigraphic unit at the site is of the Miocene Series of the Tertiary system which was formed in the Cenozoic era. Metamorphic rock formation consists of limestone. Native soil types of the area are primarily Tavares fine sands that are moderate to well drained. The site may consist of urban land. The survey does not identify any depressions or sinkholes on the site. The elevation of the site is approximately 40 feet above mean sea level. The natural topography of the site generally slopes slightly to the east.

#### 2.3 General Site and Vicinity Characteristics

Located within the Ybor City section of the City of Tampa, the surrounding area was initially developed in the early 1880's as primarily industrial or residential in nature. Commercial, light industrial, recreational and residences are located in the vicinity. Water in the vicinity is provided by municipal sources. The site is serviced by the city sanitary sewer system. Municipal waste disposal in the vicinity is contracted. Electric & telephone are available at the street. The site consists of one rectangular shaped parcel consisting of approximately one eighth of an acre.

The surrounding area was partially developed by at least the early 1850's. By 1895, surrounding properties to the west included residential structures. The immediate surrounding area is currently mixed light industrial, commercial and residential.



#### 2.4 On-site structures/Improvements

The one eighth acre site is approximately 30% used for exterior storage space including sidewalk/road/parking areas, 40% improved with the building and 30% is a vacant grass covered lot. The improved area consists of one building. The building is described as follows:

#### Commercial/Residential Building

The commercial building is a two-story structure constructed in 1924 on concrete slab at grade. The first level consists of office spaces and a garage. The second floor appears to be a residential apartment. There is a canopy on the north end of the building which has a number of parking spaces below. The building is of concrete block construction with a masonry finish. The structure is wood framed with a flat built-up roof on the canopy and a pitched metal roof on the apartment.

#### 2.5 Current Site Usage and Adjoining Properties

The site is currently an active commercial office and residential apartment facility. The adjoining properties to the south are residences. Further south are commercial areas. The adjoining property to the north is East Columbus Drive. Further north is a vacant lot and residences. The adjoining property to east is North 12<sup>th</sup> Street. Further east are commercial and residential properties. The adjoining property to the west is a residence. Further west are residences. Surrounding land use is primarily commercial, light industrial or residential.

#### 3.0 RECORDS REVIEW

#### 3.1 Site History & Ownership

Information obtained through the Hillsborough County Tax Assessment search indicates that the most recent deed activity for the site consists of a Deed issued to Deborah Lisa Ramos in 2019, (Deed Book 26846, page 1327).

#### 3.2 Federal and State Environmental Database Search (EDR)

A search of federal and state records was conducted according to ASTM standards by contracting a commercial database service, EDR, in order to identify any property within a designated proximity to the site that may pose a risk of contamination of the site.

Definitions for selected database sites were identified and are described along with each



identified site in the following sections. See Attachment IV for definitions and the Executive Summary of the EDR database report.

#### Pertinent Federal ASTM Records

The site was not listed as any type of site as described in the federal database descriptions. The following are designated by the ASTM Standard as search databases with the number of sites identified in the search area:

NPL US EPA National Priorities List - 0

CERCLIS/SEMS US EPA Comprehensive Environmental Response,

Compensation and Liability Act Information

System - 1

**RCRA CORRACTS** Facilities Subject to Corrective Action Under the

Resource Conservation and Recovery Act -0

**RCRA non-CORRACTS** Facilities Not Subject to Corrective Action Under

the Resource Conservation and Recovery Act - 0

RCRA generators Generators Under the Resources Conservation and

Recovery Act -0

**NRI/ERNS** National Response Incidents – 0

Based on proximity and a cursory drive by, none of the federal mapped or unmapped sites identified in the EDR report would be expected to impact the subject property or the proposed right of way construction. However, any contamination issues present on adjacent or nearby properties migrating to the site would be the responsibility of the adjacent site owner to rectify through the applicable regulatory guidelines.

#### Florida Records

No state hazardous waste sites, five solid waste facilities/historic landfill sites, fifteen LUST sites and three Brownfields sites were identified by EDR within a designated proximity to the site according to ASTM standards. The target property is listed as a leaking underground storage tank (LUST) site, a DWM Contaminated site, a Historic Automobile Service site named Latin American Service Station, a Florida UST site and a Cleanup site in the EDR Radius Map Report. The Florida DEP facility site ID # is 8508982 and the Florida DEP Cleanup Site Key # is 59734501. The site is listed as a



closed site, therefore it is not an active retail site. The site is listed as having an ongoing discharge cleanup status from a discharge reported on 3/29/1991. Based on proximity, a cursory drive by and the fact that the EDR reports do not identify non-reported leaking tanks, none of these types of state properties or unmapped properties would be expected to impact the site. Based on the involvement of the Hillsborough County EPC, if subsurface contamination has migrated to the target property, the current owner should have been notified.

#### 3.3 Local and State Environmental Record Search

As part of this assessment, OHC has submitted a request for an informal file review with the Hillsborough County EPC and Fire Marshalls offices and the City of Tampa Fire Marshalls Office. Information obtained from these requests is as follows:

- The Hillsborough County EPC office responded back stating that there were no air management, wetlands management or water management files associated with the subject property. The waste management division did locate files including Small Quantity Generator files, Tank and Cleanup files which were reviewed on 11/22/19. Information obtained from the file review is as follows:

#### Waste Generator File

This file identifies Danny's Generators as a conditionally exempt small quantity generator of hazardous waste which included used motor oil.

#### **Enforcement File**

No significant documents were located in this file.

#### Storage Tank File

There were at least nine UST's located on the site at one time. The tanks have been removed and the site does not have any registered tanks currently present. A gasoline and used motor oil discharge notification dated 3-29-1991 was reviewed. See the site map in Attachment II outlining the former tank locations, plume outline and the current remedial action plan location.

#### Cleanup File

- The cleanup file contained a storage tank closure assessment, a site characterization report and a partial remedial action plan. As part of the closure, soil samples were



collected and groundwater monitoring wells were installed. Groundwater samples were collected. Groundwater was encountered at 24 feet below grade surface (bgs). Soil sample results from the characterization indicate soil contamination above the ECP soil cleanup target levels at 2 to 8 feet bgs. Groundwater sample results were found to be above the ECP groundwater cleanup target levels (GCTL).

- The City of Tampa and Hillsborough County Fire Marshalls offices were contacted. Hillsborough stated the site was outside of their response jurisdiction. The Tampa request was not completed due to time constraints associated with this report.

File review requests and information is found in Attachment V.

#### 3.4 Other Environmental Record Sources

OHC conducted a review of geological maps, land use and zoning maps at the Hillsborough County Planning Commission office. The site is zoned commercial class 4 and the land use is currently 1217 mixed use office. The geology is as stated in section 2.2. A City Directory Search was performed which identifies business entities which have had phone numbers associated with the site address. The listings for 1023 East Columbus Drive are as follows:

1934 to 2010 Latin American Auto Service
 1949 Manuel Amiella Filling Station

See the pertinent City Directory Search information in Attachment V.

#### 3.5 Sanborn Maps

JMT conducted a Sanborn Fire Insurance Map search through EDR. The search conducted revealed that maps produced for the subject area in 1915, 1931, 1950, 1976 & 1979. The Sanborn search report and maps are found in Attachment VI. The information from the maps is as follows:

The 1915 map reveals the site is partially developed with a small residential structure located on the south side of the property. The 1931 and 1950 maps reveal the residence does not exist, and the site is developed with a gasoline filling station that has three UST's and an auto service facility. The 1976 and 1979 maps reveal a gasoline filling station, tire service and auto service facility. Surrounding land use is primarily residential with some commercial properties nearby.



#### 3.6 Topographic Maps

Historic topographic maps for the years 1944, 1947, 1956, 1969, 1979, 1981, 1995 and 2012 were obtained and reviewed for the subject area. The 1944 through 1995 maps reveal the site is located in a developed urban setting. The maps produced do not show building structures, only topographic features. No useful data depicting site usage can be derived from the maps searched. The map search data is found in Attachment VII.

#### 3.7 Aerial Photograph Review

Historic aerial photographs for the years 1938, 1950, 1957, 1965, 1973, 1976, 1980, 1987, 1991, 1995, 1998, 2007, 2010, and 2017 were obtained and reviewed of the subject area. The aerials were at varying scales which have varying levels of resolution. The 1938 through 1957 aerials reveal that the site is developed. Interstate 4 does not exist to the south. Less residential and commercial development as compared to today exists in all directions. The 1965 aerial reveals the site is developed and Interstate 4 exists to the south. The remaining aerials indicate the site is developed and significant residential, commercial and industrial development has taken place in surrounding areas. The 2017 aerial depicts the site as it is today. The photos obtained are found in Attachment VIII.

#### 4.0 SITE RECONNAISSANCE

On November 13, 2019 OHC Environmental Professional, Mr. Thomas Martinelli, performed site reconnaissance at the subject property. Remarkable observations as a result of the reconnaissance are discussed in the following sections of the report.

#### **4.1 General Site Observations**

The site was observed to have the characteristics outlined in Section 2.3 and 2.4. The site was an active office and apartment building at the time of the site reconnaissance. Specific items were observed:

#### 4.1.1 Storage Tanks

No evidence of aboveground or underground storage tanks, (i.e. vent/fill pipes), were observed.

#### 4.1.2 Polychlorinated Biphenyls ("PCBs")

The use of PCBs in newly manufactured electrical equipment and oils has been banned since 1979. Therefore, this type of equipment (pole mounted transformers, fluorescent



light ballasts) which were installed at the site near or prior to this date may contain parts which may be filled with PCB-contained dielectric fluid. No pole mounted transformers or ballasts were present on the exterior of the site.

#### **4.2 Exterior Observations**

Exterior areas of the site include exterior storage, a small concrete parking area under the canopy, concrete sidewalks and an empty grass covered lot to the south of the building. The roof stormwater is either conveyed directly to the concrete sidewalks or via sheet flow from the rooftops. Some stormwater percolates to site soils. A number of groundwater monitoring wells are located on the north, south and east sides of the building. These observation wells are associated with the ongoing subsurface contamination discharge monitoring from former LUST's on the site.

#### **Indicators Not Observed**

The following indicators of possible recognized environmental conditions under the ASTM standard were not observed at the site during the external site reconnaissance: stressed vegetation, material storage ponds or lagoons.

#### 4.3 Interior Observations

No access to the building interior was granted for this assessment.

#### **4.4 Non-Scope Observations**

#### 4.4.1 Lead-Based Paint

Lead-based paint was not physically evaluated as part of this ESA. Exterior painted areas were observed to be in good condition.

#### 4.4.2 Asbestos-Containing Material (ACM)

ACM was not physically evaluated as part of this ESA. Exterior suspect asbestos containing materials were observed which included roofing materials, masonry stucco, caulking, etc. All materials were observed to be in fair to good condition.

#### 4.4.3 Radon

Radon was not physically evaluated as part of this ESA. Since the site is zoned commercial class 4, radon would not be expected to be considered a concern.

#### **5.0 INTERVIEW INFORMATION**

Mr. Whit Council (Hillsborough County EPC Case Manager), was contacted and he stated that he was the current Case Manager for the site. He stated that the site does have soil and



groundwater contamination present. He reported that the site is in the cleanup stage as the site characterization study has been completed and a remedial action plan has been approved by the EPC. The construction of the air sparging soil vapor extraction remediation system will begin in the coming weeks. He did know the vertical and lateral extent of the contamination. He stated that no significant soil or groundwater contamination has migrated north of the site onto East Columbus Drive. The plume is migrating in a westerly direction. He did state that static groundwater was approximately 25 feet bgs.

Ms. Jeanette Figari (Hillsborough County EPC), was contacted and stated that she is the point of contact at the EPC to prepare right to know requests. She prepared the request to the air, waste, water and wetland management divisions. She stated that the only files found were in the waste division. A file review was scheduled for 11-22-19.

Ms. Gabrielle Williams, (City of Tampa Emergency Mgt.), stated that there is now a fifteen dollar charge to perform the right to know request. Due to time constraints associated with this project, this request was not performed. She did state that the Hillsborough County Fire Marshalls office be contacted as well.

Ms. Miguelina Rodriguez, (Hillsborough County Fire/Rescue), stated that she researched her files and found that the City of Tampa Fire Marshalls office responds to the site.

#### 6.0 FINDINGS, CONCLUSIONS & RECOMMENDATIONS

OHC Environmental Engineering, Inc. has performed a Phase I Environmental Site Assessment in general conformance with the scope and limitations of ASTM Practice E1527-13 and 40 CFR 312 of the former Danny's Generators site located in the Ybor City section of the City of Tampa, Hillsborough County, FL. Any exceptions to or deletions from this practice are described in Section 7.0, Exceptions/Data Gaps section of this report. This assessment has revealed evidence of the following potential recognized environmental conditions (REC) in connection with the property:

Finding 1) The site address is listed as a leaking underground storage tank (LUST) site, a DWM Contaminated site, a Historic Automobile Service site, a Florida UST site and a Cleanup site in the EDR Radius Map Report. The Florida DEP facility site ID # is 8508982 and the Florida DEP Cleanup Site Key # is 59734501. The site is listed as a closed site, therefore it is not an active retail site. The site is listed as having an open



discharge cleanup status from a discharge reported on 3/29/1991. This indicates that the cleanup is not completed. Therefore, this discharge represents a REC. There are monitoring wells located in the concrete slab and sidewalk at the site which may be in the proposed right of way construction. Therefore, these well locations should be properly surveyed for location and closed prior to the construction activities to prevent any accidental release of hazardous material contacting the wellhead locations. The well closure should be coordinated with the EPC case manager. The proposed construction involves sidewalk and road reconstruction which is expected to impact depths from grade to approximately three feet below grade. Therefore, if any residual soil or groundwater contamination exists (>3 feet below grade) in the vicinity of the future remediation area, it would not be expected to impact the proposed construction activities.

#### 7.0 EXCEPTIONS/DATA GAPS

#### **Section Reference 3.1: Explanation**

A complete, thorough 50 year chain of title was not obtained for the site due to the county deed records becoming too complex to trace back. Also, the microfilm viewing machine was not operating properly at the time of the records search. If a thorough chain of title is required, an abstract company should be retained. Also, data gaps are present which determine exact site usage of the site for every year dating back to when the site was undeveloped.

#### **Section Reference 4.3: Explanation**

This assessment is limited to exterior observations only as no access was granted to observe interior conditions.

#### 8.0 NON-SCOPE ISSUES

Radon

The EPA has established 4 picocuries per liter ("pCi/L") of radon gas in indoor air as a guidance level for residences. Accumulations above 4 pCi/L are considered to represent a health risk to occupants. Hillsborough County is known to lie within an area that has elevated radon levels. The EDR Report has identified 50% of the structures tested in the basements of Hillsborough County residences are above the guidance level. Only 14% of the structures tested within the 33605 zip code area were above the EPA level. Actual radon concentration can only be determined by actual



on-site measurement. Radon was not evaluated as part of this EA. The possible presence of naturally occurring radon is a non-scope issue, as it is not included in CERCLA's definition of hazardous substances and does not otherwise present potential CERCLA liability.

#### Asbestos

The issue of asbestos is outside the scope of the Phase I ESA standard practice. Effective October 11, 1994, the Occupational Safety and Health Administration ("OSHA") expanded the scope of its general industry standard for asbestos, 29 CFR 1910.1001. The standard requiring asbestos building surveys now applies to virtually all buildings constructed before 1980 and brings OSHA' enforcement power to an issue which was previously regulated by the EPA's National Emission Standards for Hazardous air Pollutants ("NESHAPS"). Since the building on site was constructed around 1929, suspect asbestos materials may be expected to be a business risk. Suspect materials may include but not be limited to drywall ceilings and walls, suspended ceiling tiles, thermal system insulation, roofing materials, etc. If renovation or demolition of the site building is planned, the areas or building involved should be inspected by an accredited building inspector prior to disturbance.

#### Lead Based Paint

Lead-based paint was not evaluated as part of this EA. Since the building on site was reportedly constructed before 1978, lead paint may be expected to be a business issue. The possible presence of lead-containing paint is a non-scope issue, as lead-containing paint is not included in CERCLA's definition of hazardous substances and does not otherwise present potential CERCLA liability. Due to the age of the building on site, suspect lead based paint may be located within the building. Lead based paint inspections relating to human exposure are not required in commercial or industrial settings. However, OSHA regulates lead as it relates to employee exposure if the material is disturbed. The condition of painted surfaces is in fair to good condition.



November 24, 2019 Mr. Jeff Siewert – Ayres Associates 1023 East Columbus Drive Phase I Environmental Assessment OHC Project No. 190238-ES

### **ATTACHMENT I**

**User Questionnaire** 





#### PHASE I ENVIRONMENTAL ASSESSMENT USER QUESTIONAIRRE

Pu	rchaser:
Pu	rchaser's Telephone No.:
O	vner's Name:
O	vner's Telephone No.:
Su	bject Property:
t.	Land use: Is the property or adjoining property currently used for manufacturing or industrial use? Adjoining properties include those that border the immediate site and include properties across the street from the property.  YES NO (If "YES", please describe)
	Subject Property:
	Adjoining property north: Adjoining property south:
	Adjoining property east:
	Adjoining property west:
2.	Has the property or adjoining property been used for manufacturing or industrial purposes in the past? YES NO (If "YES", please describe)
	Owner / Use / Date(s) Subject Property Previous use: Previous use (north):
	Previous use (south):
	Previous use (cast):
	Previous use (west):
3.	Are there any pesticides, automotive or industrial batteries, paints or other chemicals stored on the property of at the facility other than undamaged containers of consumer products under five gallons in total volume?  YES NO (If "YES", please describe)

OHC ENVIRONMENTAL ENGINEERING, INC. 101 SOUTH HOOVER BLVD, SUITE 101 • TAMPA, FLORIDA 33609 PHONE: (813) 626 – 8156 • FAX: (813) 623 – 6702 WEBSITE: WWW.OHCNET.COM

Page 1 of 4





- Are there any plastic or metal industrial drums (typically 55-gallon) located on the property or at the facility?
   YES NO (If "YES", please describe)
- Has fill dirt been brought onto the site that could be contaminated?
   YES NO (If "YES", please describe)
- 6. Have any construction debris, substances identified as hazardous, unidentified waste materials, tires, automotive or industrial batteries or any other waste materials been dumped above grade, buried and/or burned on the site?

YES NO (If "YES", please describe)

7. Are there any pits, ponds or lagoons located on the property in connection with waste treatment or waste disposal?

YES NO (If "YES", please describe)

Is there any soil on the property that has been obviously stained? YES NO (If "YES", please describe) Are storage tanks above or underground located on the property? YES NO (If "YES", please describe)

10. Are vent pipes protruding from the ground or buildings at the property or adjacent to any structure located on the property?

YES NO (If "YES", please describe)

11. Does the property discharge waste water, other than storm water, directly to a ditch or stream on or adjacent to the property?

YES NO (If "YES", please describe)

- 12. If the property is served by a private well or non-public water system has the well or water system been designated as contaminated by a governmental environmental or health agency? YES NO (If "YES", please describe)
- Asbestos: Does the property or any buildings located on the property contain any asbestos?
   YES NO (If "YES", please describe)
- 14. <u>Polychlorinated biphenyls (PCBs)</u>: Have polychlorinated biphenyls been used in electrical transformers, capacitors or other equipment at the property?

YES NO (If "YES", please describe)

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- 15. Is there a transformer that is not owned by a public or private utility or group and for which there are no records indicating the absence of PCBs?
  - YES NO (If "YES", please describe)
- 16. <u>Radon</u>: Has the property or any buildings located on the property been tested for radon? YES NO (If "YES", please describe)
- 17. <u>Urea-Formaldehyde</u>: Does the property or any buildings located on the property contain any urea-formaldehyde materials?
  YES NO (If "YES", please describe)
- 18. <u>Lead</u>: Does the property or any buildings located on the property contain any lead-based paint or lead plumbing?
  YES NO (If "YES", please describe)
- 19. <u>Miscellaneous</u>: Does the owner of the property or operator of the facility have any knowledge of environmental liens, activity/use limitations or governmental notification relating to violations of environmental laws on the property or any facility located on the property? YES NO (If "YES", please describe)
- 20. Has the owner of the property or operator of the facility been informed of the presence of hazardous substances or environmental violations in regards to the property or any facility located on the property? YES NO (If "YES", please describe)
- 21. Are you aware of any environmental assessment of the property that indicated the presence of hazardous substances on the site or recommended further assessment of the property?
  YES NO (If "YES", please describe)
- 22. Are there past, current or pending lawsuits or administrative proceedings for alleged environmental damages involving the property or any owner or tenant of the property? YES NO (If "YES", please describe)
- 23. Does the purchase and/or sales price of this property reflect the presence of hazardous substances on the property?
  YES NO (If "YES", please describe)

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-	ENVIRONMENTAL ENGINEERING
	<u>and</u> : Have pesticides, herbicides or other agricultural chemicals been stored oplied to the property? YES NO (If "YES", please describe)
This questionnaire	was completed by the property owner (required):
Owner's/Seller's Si	gnature:
	ame'
Owner's Printed N	aute.

OHC ENVIRONMENTAL ENGINEERING, INC. 101 SOUTH HOOVER BLVD, SUITE 101 • TAMPA, FLORIDA 33609 PHONE: (813) 626 - 8156 • FAX: (813) 623 - 6702 WEBSITE: WWW.OHCNET.COM


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### **ATTACHMENT II**

### **Site Maps/Tax Assessment Information**








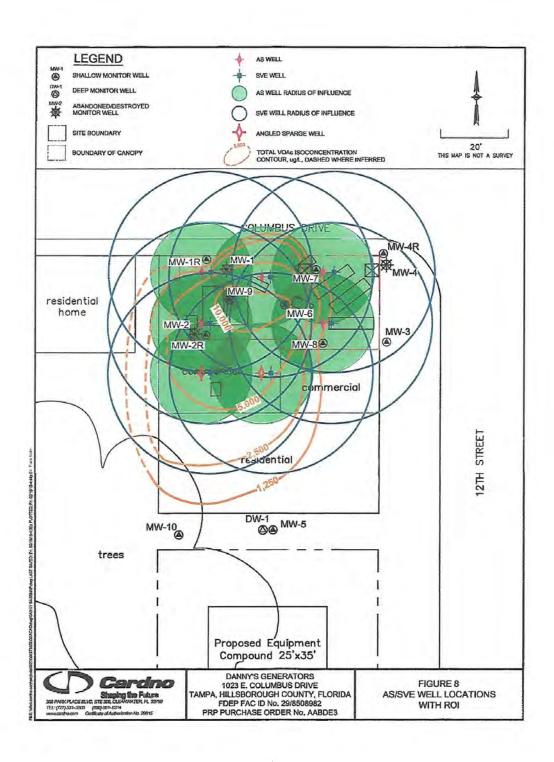

#### Bob Henriquez Hillsborough County Property Appraiser

https://www.hcpafl.org/ 15th Floor County Ctr. 601 E. Kennedy Blvd, Tampa, Florida 33602-4932 Ph: (813) 272-6100

#### Folio: 198262-0000

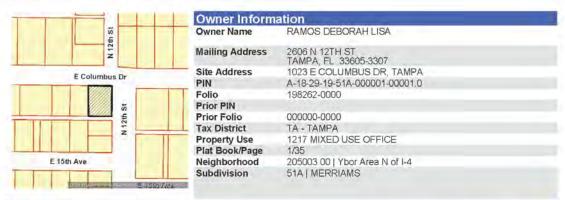

Value Summar	V			
Taxing District	Market Value	Assessed Value	Exemptions	Taxable Value
County	\$402,612	\$393,480	\$50,000	\$343,480
Public Schools	\$402,612	\$393,480	\$25,000	\$368,480
Municipal	\$402,612	\$393,480	\$50,000	\$343,480
Other Districts	\$402.612	\$393,480	\$50,000	\$343,480

Note: This section shows Market Value, Assessed Value, Exemptions, and Taxable Value for taxing districts. Because of changes in Florida Law, it is possible to have different assessed and taxable values on the same property. For example, the additional \$25,000 Homestead Exemption and the non-homestead CAP do not apply to public schools, and the Low Income Senior Exemption only applies to countywide and certain municipal millages.

Book	formation Page	Month	Year	Type Inst	Qualified or	Vacant or Improved	Price
BUUK	rage	Menti	Teal	Type mac	Unqualified	vacant or improved	File
26846	1327	08	2019	QC	Unqualified	Improved	\$358,500
20071	1884	09	2010	WD	Qualified	Improved	\$150,000
19644	1398	12	2009	CT	Unqualified	Improved	\$100
17771	0456	05	2007	WD	Unqualified	Improved	\$100
16899	0202	08	2006	WD	Unqualified	Improved.	\$100
16716	1318	07	2006	WD	Qualified	Improved	\$365,000
11377	0694	01	2002	WD	Unqualified	Improved	\$150,000
6537	1224	03	1992	QC	Unqualified	Improved	\$100
1316	0559	05	1945	WD	Unqualified	Vacant	\$100
0446	0103	08	1924		Qualified		\$0

Page 1 - 11/11/2019 9:54:49 AM



3.784.75		10 LOFFICE O
Туре		49   OFFICE <3 STORY
Year Built		1924
Building 1 Constructio	n Details	
Element	Code	Construction Detail
Class	С	Masonry or Concrete Frame
Exterior Wall	7	Masonry Frm: Stucco
Roof Structure	4	Truss (Wood/Metal)
Roof Cover	4	Blt.up Tar & Gravel
Roof Cover	9	Metal
Interior Walls	1	Masonry or Minimum
Interior Flooring	2	Concrete Finished
Heat/AC	2	Central
Plumbing	3	Typical
Condition	4	Good
Stories	2.0	
Units	2.0	
Wall Height	12.00	




Building 1 subarea	2000	land of the second	
Area Type	Gross Area	Heated Area	Depreciated Value
BAS	1,950	1,950	\$121,416
APT	1,950	1,950	\$133,557
BAS	551	551	\$34,308
CAN	1,562		\$29,202
BAS	72	72	\$4,483
BAS	870	870	\$54,170
Totals	6.955	5,393	\$377,136

Extra F	eatures						
OB/XF Code	Description	Building	Year On Roll	Length	VVidth	Units	Value
0060	CONCRETE PAVEMENT	1	1924	0	0	640.00	\$1,440

Land Information								
Use Code	Description	Zone	Front	Depth	Land Type	Total Land Units	Land Value	
COD1	Comm Class 4	YC-2	65.00	86.00	SF   SQUARE FEET	5,590.00	\$24,037	

Legal Description
MERRIAMS LOT 1 LESS R/W ON N BLOCK 1

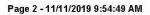



November 24, 2019 Mr. Jeff Siewert – Ayres Associates 1023 East Columbus Drive Phase I Environmental Assessment OHC Project No. 190238-ES

### **ATTACHMENT III**


**Site Photographs** 





North Side of Building



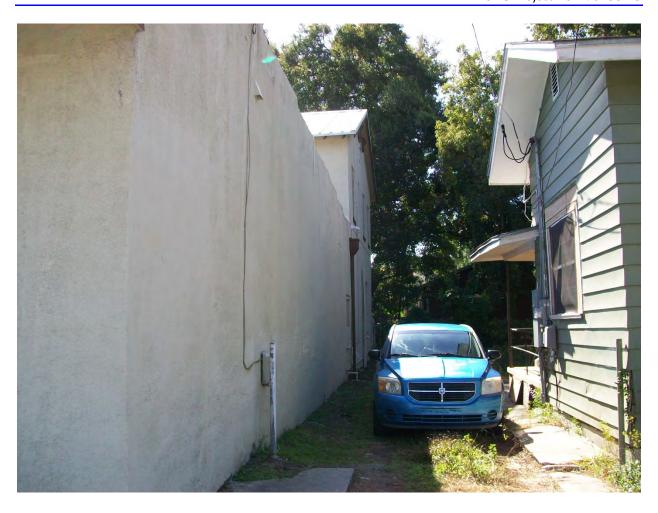

West Side of Building





East Side of Building





South Side of Building





Monitoring Wells in Sidewalk





Water Meter in Sidewalk



## **ATTACHMENT IV**

# **EDR Regulatory Database Report**



November 24, 2019 Mr. Jeff Siewert – Ayres Associates 1023 East Columbus Drive Phase I Environmental Assessment OHC Project No. 190238-ES

**Dannys Generators** 1023 East Columbus Drive Tampa, FL 33605

Inquiry Number: 5864603.2s November 11, 2019

# The EDR Radius Map™ Report with GeoCheck®



6 Armstrong Road, 4th floor Shelton, CT 06484 Toll Free: 800.352.0050 www.edrnet.com

FORM-LBC-DVV



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Thank you for your business.
Please contact EDR at 1-800-352-0050
with any questions or comments.

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A search of available environmental records was conducted by Environmental Data Resources, Inc (EDR). The report was designed to assist parties seeking to meet the search requirements of EPA's Standards and Practices for All Appropriate Inquiries (40 CFR Part 312), the ASTM Standard Practice for Environmental Site Assessments (E 1527-13), the ASTM Standard Practice for Environmental Site Assessments for Forestland or Rural Property (E 2247-16), the ASTM Standard Practice for Limited Environmental Due Diligence Transaction Screen Process (E 1528-14) or custom requirements developed for the evaluation of environmental risk associated with a parcel of real estate.

#### TARGET PROPERTY INFORMATION

#### ADDRESS

1023 EAST COLUMBUS DRIVE TAMPA, FL 33605

#### COORDINATES

27,9666640 = 27° 57° 59.99" 82,4471250 = 82° 26° 49.65" Latitude (North): Longitude (West): 82.4471: Universal Tranverse Mercator: Zone 17

357660.0 UTM X (Meters) UTM Y (Meters) 3094181.2

Elevation 40 ft, above sea level

#### USGS TOPOGRAPHIC MAP ASSOCIATED WITH TARGET PROPERTY

5655712 TAMPA, FL Target Property Map: 2012

Version Date:

## AERIAL PHOTOGRAPHY IN THIS REPORT

Portions of Photo from: 20150510 Source: USDA



#### MAPPED SITES SUMMARY

#### Target Property Address: 1023 EAST COLUMBUS DRIVE TAMPA, FL 33605

#### Click on Map ID to see full detail.

MAP	SITE NAME	ADDRESS	DATABASE ACRONYMS	RELATIVE ELEVATION	DIST (ft. & mi.) DIRECTION
A1	DANNY'S GENERATORS	1023 E COLUMBUS DR	RGÁ LUST		TP
A2	DANNY'S GENERATORS	1023 E COLUMBUS DR	LUST, UST, CLEANUP SITES, DWM CONTAM		TP
A3	LATIN AMERICAN SERVI	1023 E COLUMBUS DR	EDR Hist Auto		TP
Reg	CENTRO ASTURIANO PLA		BROWNFIELDS	Same	1488, 0.282, NNE
A4	DIEZ GARAGE	2606 12TH ST	EDR Hist Auto	Higher	74, 0.014, SSE
A5	TAMPA CITY-FIRE DEPT	2611 N 12TH ST	UST	Higher	136, 0.026, East
B6	LATIN AMERICAN SERVI	1032 E COLUMBUS DR	EDR Hist Auto	Higher	158, 0.030, NVV
B7	LATIN AMERICAN SERVI	1022 E COLUMBUS DRIV	EDR Hist Auto	Higher	166, 0.031, NW
B8	GENERAL GARAGE	1017 E COLUMBUS DR	EDR Hist Auto	Lower	175, 0.033, West
9	TRAILER SERVICE INC	1213 17TH AVE	SWF/LF	Higher	439, 0.083, NE
C10	PEOPLES GAS SYSTEM	1200 NORTH 13TH STRE	VCP, FI Sites, CLEANUP SITES, DWM CONTAM, RESP.,	Lower	736, 0.139, SSE
C11	PEOPLES GAS SYSTEM!	1200 N 13TH ST	UST	Lower	736, 0.139, SSE
12	COLUMBUS FOOD MART	1312 E COLUMBUS DR	LUST, UST, CLEANUP SITES, DWM CONTAM, Financial.	Lower	861, 0.163, East
13	TAMPA CITY-YBOR GRAM	1407 E COLUMBUS AVE	LUST, UST	Lower	1138, 0.216, East
14	R10 - FOLIO NO 1868	2813 NORTH 9TH STREE	US BROWNFIELDS, FINDS	Higher	1147, 0.217, NW
15		2812 N 9TH STREET	DEDB	Higher	1208, 0.229, WNW
D16	3 WAY CLEANERS	1420 E COLUMBUS DR	RCRA NonGen / NLR, FINDS, ECHO	Lower	1232, 0.233, East
D17	BAYPRO DRY CLEANERS	1420 E COLUMBUS DR	DRYCLEANERS	Lower	1232, 0.233, East
18	GOLDSTAR FOODS	2317 N NEBRASKA AVE	LUST, UST, CLEANUP SITES, DWM CONTAM, Financial.	Higher	1246, 0.236, West
19	COASTAL MART #643	2309 N NEBRASKA AVE	UST	Higher	1267, 0.240, West
20	TRINITY CAFE	2801 N NEBRAKSA AVE	LUST, UST, Financial Assurance	Higher	1287, 0.244, WNW
E21	SOUTHERN HYDRAULIC S	1502 E COLUMBUS DR	LUST, UST, CLEANUP SITES, DWM CONTAM	Lower	1419, 0.269, East
E22	COLUMBUS TIRES INC.	1502 E. COLUMBUS DR.	SWF/LF	Lower	1419, 0.269, East
23	EAST TAMPA AFFORDABL	906 EAST 19TH AVENUE	US BROWNFIELDS	Higher	1439, 0.273, NW
24	JOSUE BETANCOURT	1315 HOLMES AVENUE	SWF/LF	Higher	1486, 0.281, NE
25	CENTRO AUSTURIANO HO	1302 E 21ST AVE	VCP, RESP PARTY	Higher	1825, 0.346, NNE
F26	GIGLIO PROPERTY	2007 NEBRASKA AVE	LUST, UST	Higher	1937, 0.367, SW
27	CUSCADEN PARK STATIO	3002 N 15TH ST	LUST, UST, CLEANUP SITES, DWM CONTAM, Financial.	Higher	1947, 0.369, NE
28	TAMPA ELECTRIC CO-TE	1898 NUCCIO PKY	LUST, UST, CLEANUP SITES, DWM CONTAM, Financial.	Lower	1983, 0.376, South
29	TAMPA CITY-FIRE DEPT	2904 N MITCHELL AVE	LUST, UST, AST, CLEANUP SITES, DWM CONTAM,	Higher	2021, 0.383, NW
F30	TORRES TRANSMISSIONS	2002 N NEBRASKA AVE	LUST, UST	Higher	2057, 0.390, SW
31	EASTELL & CORNELL TH	909 E 23RD AVE	SWF/LF	Higher	2135, 0.404, NNW
32	EAST 23RD BATTERY	903 EAST 23RD AVENUE	SEMS, PRP, ICIS	Higher	2217, 0.420, NNW
33	VIMAL INVESTMENT LLC	3115 N NEBRASKA AVE	LUST, UST, CLEANUP SITES, DWM CONTAM, Financial		2471, 0.468, NNW
G34	EL ENCANTO CLEANERS	1818 N 15TH ST	DWM CONTAM	Lower	2488, 0.471, SSE
G35	EL ENCANTO CLEANERS	1818 N 15TH ST	RCRA-SQG, PRIORITYCLEANERS	Lower	2488, 0.471, SSE
36	7TH AVENUE YBOR CITY	1410, 1412, 1414, 14	US BROWNFIELDS	Lower	2503, 0.474, SSE
37	STAR #1229	1802 N NEBRASKA AVE	LUST, UST, CLEANUP SITES, DWM CONTAM	Lower	2562, 0.485, SSW
G38	TRACKS	1430 E 7TH AVE	LUST, UST	Lower	2585, 0.490, SSE

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#### MAPPED SITES SUMMARY

#### Target Property Address: 1023 EAST COLUMBUS DRIVE TAMPA, FL 33605

#### Click on Map ID to see full detail.

MAP	SITE NAME	ADDRESS	DATABASE ACRONYMS	RELATIVE ELEVATION	DIST (ft & mi.) DIRECTION
39	CHANDRA PATEL	3201 N NEBRASKA AVE	SWF/LF	Higher	2616, 0,495, NNW
40	KWIK STOP	934 E HENDERSON AVE	LUST, UST, CLEANUP SITES, DWM CONTAM, Financial	Lower	2617, 0,496, SSW
41	DEVOE & RAYNOLDS COM	1010-26 NORTH 19TH S	FI Sites	Higher	2830, 0.536, NNW
42	PEOPLES GAS SYSTEM	1200 NORTH 13TH STRE	EDR MGP	Lower	3719, 0.704, South
43	FORT BROOKE		FUDS:	Lower	4958, 0.939, South

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#### TARGET PROPERTY SEARCH RESULTS

The target property was identified in the following records. For more information on this property see page 8 of the attached EDR Radius Map report

Site	Database(s)	EPA ID
DANNY'S GENERATORS 1023 E COLUMBUS DR TAMPA, FL	RGA LUST Facility ID: 8508982	N/A
DANNY'S GENERATORS 1023 E COLUMBUS DR TAMPA, FL 33605	LUST UST Database: UST, Date of Government Version: 05/17/2019 Tank Status: B Facility-Site Id: 8508982 Facility Status: CLOSED	N/A
	CLEANUP SITES DEP Cleanup Site Key 59734501	
	DWM CONTAM Program Site Id: 8508982	
LATIN AMERICAN SERVI 1023 E COLUMBUS DR TAMPA, FL	EDR Hist Auto	N/A

#### DATABASES WITH NO MAPPED SITES

No mapped sites were found in EDR's search of available ("reasonably ascertainable ") government records either on the target property or within the search radius around the target property for the following databases:

#### STANDARD ENVIRONMENTAL RECORDS

#### Federal NPL site list

NPL National Priority List
Proposed NPL Proposed National Priority List Sites
NPL LIENS Federal Superfund Liens

#### Federal Delisted NPL site list

Delisted NPL...... National Priority List Deletions

## Federal CERCLIS list

FEDERAL FACILITY....... Federal Facility Site Information listing



Federal CERCLIS NFRAP site list

SEMS-ARCHIVE...... Superfund Enterprise Management System Archive

Federal RCRA CORRACTS facilities list

CORRACTS...... Corrective Action Report

Federal RCRA non-CORRACTS TSD facilities list

Federal RCRA generators list

RCRA-LQG RCRA - Large Quantity Generators
RCRA-SQG RCRA - Small Quantity Generators
RCRA-VSQG RCRA - Very Small Quantity Generators (Formerly Conditionally Exempt Small Quantity Generators)

Federal institutional controls / engineering controls registries

...... Land Use Control Information System US ENG CONTROLS Engineering Controls Sites List US INST CONTROL...... Sites with Institutional Controls

Federal ERNS list

ERNS..... Emergency Response Notification System

State- and tribal - equivalent CERCLIS

State and tribal leaking storage tank lists

Leaking Aboveground Storage Tank Listing INDIAN LUST...... Leaking Underground Storage Tanks on Indian Land

State and tribal registered storage tank lists

FF TANKS. Federal Facilities Listing
FEMA UST. Underground Storage Tank Listing
AST. Storage Tank Facility Information INDIAN UST...... Underground Storage Tanks on Indian Land

TANKS...... Storage Tank Facility List

State and tribal institutional control / engineering control registries

ENG CONTROLS....... Institutional Controls Registry INST CONTROL........ Institutional Controls Registry

State and tribal voluntary cleanup sites

INDIAN VCP...... Voluntary Cleanup Priority Listing



#### ADDITIONAL ENVIRONMENTAL RECORDS

#### Local Lists of Landfill / Solid Waste Disposal Sites

#### Local Lists of Hazardous waste / Contaminated Sites

US HIST CDL Delisted National Clandestine Laboratory Register
US CDL National Clandestine Laboratory Register
PFAS PFOS and PFOA stand for perfluorocotane sulfonate and perfluorocotanoic acid

#### Local Land Records

LIENS 2..... CERCLA Lien Information

#### Records of Emergency Release Reports

HMIRS\_ Hazardous Materials Information Reporting System SPILLS . Oil and Hazardous Materials Incidents SPILLS 90. SPILLS 90 data from FirstSearch SPILLS 80. SPILLS 80 data from FirstSearch

#### Other Ascertainable Records

DOD. Department of Defense Sites
SCRD DRYCLEANERS State Coalition for Remediation of Drycleaners Listing
US FIN ASSUR. Financial Assurance Information
EPA WATCH LIST. EPA WATCH LIST
2020 COR ACTION. 2020 Corrective Action Program List
TSCA. Toxic Substances Control Act
TRIS. Toxic Chemical Release Inventory System
SSTS. Section 7 Tracking Systems
ROD. Records Of Decision
RMP. Risk Management Plans
RAATS. RCRA Administrative Action Tracking System
PRP. Potentially Responsible Parties
PADS. PCB Activity Database System
ICIS. Integrated Compliance Information System
FTTS. FIFRA/ TSCA Tracking System - FIFRA (Federal Insecticide, Fungicide, & Rodenticide
Act)/TSCA (Toxic Substances Control Act)
MLTS. Material Licensing Tracking System
COAL ASH DOE. Steam-Electric Plant Operation Data
COAL ASH DOE. Steam-Electric Plant Operation Data
COAL ASH EPA. Coal Combustion Residues Surface Impoundments List
PCB TRANSFORMER PCB Transformer Registration Database
RADINFO. Radiation Information Database
HIST FTTS. FIFRA/TSCA Tracking System Administrative Case Listing
DOT OPS. Incident and Accident Data
CONSENT. Superfund (CERCLA) Consent Decrees



INDIAN RESERV...... Indian Reservations

FUSRAP Formerly Utilized Sites Remedial Action Program
UMTRA Uranium Mill Tailings Sites
LEAD SMELTERS Lead Smelter Sites US AIRS...... Aerometric Information Retrieval System Facility Subsystem

US MINES..... Mines Master Index File

ABANDONED MINES..... Abandoned Mines

UXO Unexploded Ordnance Sites
FUELS PROGRAM EPA Fuels Program Registered Listing

Financial Assurance...... Financial Assurance Information Listing

FL Cattle Dip. Vats....... Cattle Dipping Vats

SITE INV SITES...... Site Investigation Section Sites Listing

TIER 2 Tier 2 Facility Listing
UIC Underground Injection Wells Database Listing
NPDES Wastewater Facility Regulation Database
MINES MRDS Mineral Resources Data System

EDR HIGH RISK HISTORICAL RECORDS

EDR Exclusive Records

EDR Hist Cleaner..... EDR Exclusive Historical Cleaners

EDR RECOVERED GOVERNMENT ARCHIVES

Exclusive Recovered Govt. Archives

RGA LF...... Recovered Government Archive Solid Waste Facilities List

SURROUNDING SITES: SEARCH RESULTS

Surrounding sites were identified in the following databases.

Elevations have been determined from the USGS Digital Elevation Model and should be evaluated on a relative (not an absolute) basis. Relative elevation information between sites of close proximity should be field verified. Sites with an elevation equal to or higher than the target property have been differentiated below from sites with an elevation lower than the target property.

Page numbers and map identification numbers refer to the EDR Radius Map report where detailed data on individual sites can be reviewed

Sites listed in bold italics are in multiple databases.

Unmappable (orphan) sites are not considered in the foregoing analysis.



#### STANDARD ENVIRONMENTAL RECORDS

#### Federal CERCLIS list

SEMS: SEMS (Superfund Enterprise Management System) tracks hazardous waste sites, potentially hazardous waste sites, and remedial activities performed in support of EPA's Superfund Program across the United States. The list was formerly know as CERCLIS, renamed to SEMS by the EPA in 2015. The list contains data on potentially hazardous waste sites that have been reported to the USEPA by states, municipalities, private companies and private persons, pursuant to Section 103 of the Comprehensive Environmental Response, Compensation, and Liability Act (CERCLA). This dataset also contains sites which are either proposed to or on the National Priorities List (NPL) and the sites which are in the screening and assessment phase for possible inclusion on the NPI.

A review of the SEMS list, as provided by EDR, and dated 07/19/2019 has revealed that there is 1 SEMS site within approximately 0.5 miles of the target property.

Equal/Higher Elevation	Address	Direction / Distance	Map ID	Page
EAST 23RD BATTERY Site ID: 0409761	903 EAST 23RD AVENUE	NNW 1/4 - 1/2 (0.420 ml.)	32	107
EPA Id: FLN000409761				

#### State and tribal landfill and/or solid waste disposal site lists

SWF/LF: The Solid Waste Facilities/Landfill Sites records typically contain an inventory of solid waste disposal facilities or landfills in a particular state. The data come from the Department of Environmental Protection's Facility Directory (Solid Waste Facilities).

A review of the SWF/LF list, as provided by EDR, has revealed that there are 5 SWF/LF sites within approximately 0.5 miles of the target property.

Equal/Higher Elevation	Address	Direction / Distance	Map ID	Page
TRAILER SERVICE INC Database: SWF/LF, Date of Gover Facility-Site Id: 96603 Class Status: INACTIVE (I)	1213 17TH AVE nment Version: 07/16/2019	NE 0 - 1/8 (0.083 ml.)	9	19
JOSUE BETANCOURT Database: SWF/LF, Date of Gover Facility-Site Id: 103806 Class Status: INACTIVE (I)	1315 HOLMES AVENUE nment Version: 07/16/2019	NE 1/4 = 1/2 (0.281 mi.)	24	69
EASTELL & CORNELL TH Database: SWF/LF, Date of Gover Facility-Site Id: 97087 Class Status: INACTIVE (I)	909 E 23RD AVE nment Version: 07/16/2019	NNW 1/4 - 1/2 (0.404 mi.)	31	106
CHANDRA PATEL Database: SWF/LF, Date of Goven Facility-Site Id: 95720 Class Status: REGISTERED (R)	3201 N NEBRASKA AVE nment Version: 07/16/2019	NNW 1/4 - 1/2 (0.495 mi.)	39	140
Lower Elevation	Address	Direction / Distance	Map ID	Page
COLUMBUS TIRES INC. Database: SWF/LF, Date of Govern	1502 E. COLUMBUS DR.	E 1/4 - 1/2 (0.269 mi.)	E22	66



Facility-Site Id: 100206 Class Status: INACTIVE (I)

#### State and tribal leaking storage tank lists

LUST The Leaking Underground Storage Tank Incident Reports contain an inventory of reported leaking underground storage tank incidents. The data come from the Department of Environmental Protection's PCTO1--Petroleum Contamination Detail Report.

A review of the LUST list, as provided by EDR, and dated 07/30/2019 has revealed that there are 14 LUST sites within approximately 0.5 miles of the target property

Equal/Higher Elevation	Address	Direction / Distance	Map ID	Page
GOLDSTAR FOODS	2317 N NEBRASKA AVE	W 1/8 - 1/4 (0.236 ml.)	18	46
TRINITY CAFE	2801 N NEBRAKSA AVE	WNW 1/8 - 1/4 (0.244 ml.)	20	56
GIGLIO PROPERTY	2007 NEBRASKA AVE	SW 1/4 - 1/2 (0.367 ml.)	F26	71
CUSCADEN PARK STATIO	3002 N 15TH ST	NE 1/4 - 1/2 (0.369 ml.)	27	76
TAMPA CITY-FIRE DEPT	2904 N MITCHELL AVE	NW 1/4 - 1/2 (0.383 ml.)	29	94
TORRES TRANSMISSIONS	2002 N NEBRASKA AVE	SW 1/4 - 1/2 (0.390 mi.)	F30	101
VIMAL INVESTMENT LLC	3115 N NEBRASKA AVE	NNW 1/4 - 1/2 (0.468 ml.)	33	109
Lower Elevation	Address	Direction / Distance	Map ID	Page
COLUMBUS FOOD MART	1312 E COLUMBUS DR	E 1/8 - 1/4 (0.163 mi.)	12	23
TAMPA CITY-YBOR GRAM	1407 E COLUMBUS AVE	E 1/8 - 1/4 (0.216 mi.)	13	36
SOUTHERN HYDRAULIC S	1502 E COLUMBUS DR	E 1/4 - 1/2 (0,269 ml.)	E21	60
TAMPA ELECTRIC CO-TE	1898 NUCCIO PKY	\$ 1/4 - 1/2 (0.376 ml.)	28	81
STAR #1229	1802 N NEBRASKA AVE	SSW 1/4 - 1/2 (0.485 ml.)	37	132
TRACKS	1430 E 7TH AVE	SSE 1/4 - 1/2 (0.490 ml.)	G38	137
KWIK STOP	934 E HENDERSON AVE	SSW 1/4 - 1/2 (0.496 ml.)	40	141

#### State and tribal registered storage tank lists

UST: The Underground Storage Tank database contains registered USTs. Shortly after the September 11 event, the DEP was instructed to remove the detail about some of the storage tank facilities in the state from their reports. Federal-owned facilities and bulk storage facilities are included in that set.

A review of the UST list, as provided by EDR, has revealed that there are 7 UST sites within approximately 0.25 miles of the target property.

Equal/Higher Elevation	Address	Direction / Distance	Map ID	Page
TAMPA CITY-FIRE DEPT	2611 N 12TH ST	E 0 - 1/8 (0.026 mi.)	A5	18
Database: UST, Date of Government	ent Version: 05/17/2019	\$1.000 P. 1000		
Tank Status: B				
Facility-Site Id: 8842520				
Facility Status: CLOSED				
GOLDSTAR FOODS	2317 N NEBRASKA AVE	W 1/8 - 1/4 (0.236 ml.)	18	46
Database: UST, Date of Governme	ent Version: 05/17/2019	andres Auran can		
Tank Status: B				



Tank Status: U Facility-Site id: 8944840 Facility Status: OPEN				
COASTAL MART #643 Database: UST, Date of Governme Tank Status: B Facility-Site Id: 8508941 Facility Status: CLOSED	2309 N NEBRASKA AVE ant Version: 05/17/2019	W 1/8 - 1/4 (0.240 mi.)	19	54
TRINITY CAFE Database: UST, Date of Governme Tank Status: B. Facility-Site Id: 9813324 Facility Status: GLOSED	2801 N NEBRAKSA AVE ent Version: 05/17/2019	WNW 1/8 - 1/4 (0.244 mi.)	20	56
Lower Elevation	Address	Direction / Distance	Map ID	Page
PEOPLES GAS SYSTEM I Database: UST, Date of Governme Tank Status: B Tank Status: A Facility-Site Id: 8625257 Facility Status: CLOSED	1200 N 13TH ST ant Version: 05/17/2019	SSE 1/8 - 1/4 (0 139 ml.)	C11	22
COLUMBUS FOOD MART Database: UST, Date of Governme Tank Status: B Tank Status: U Facility-Site Id: 8624765 Facility Status: O'PEN	1312 E COLUMBUS DR ent Version: 05/17/2019	E 1/8 - 1/4 (0.163 mi.)	12	23
TAMPA CITY-YBOR GRAM Database: UST, Date of Governme Tank Status: B Facility-Site Id: 9805466 Facility Status: CLOSED	1407 E COLUMBUS AVE ant Version: 05/17/2019	E 1/8 - 1/4 (0.216 mi.)	13	36

## State and tribal voluntary cleanup sites

VCP: The Florida Voluntary Cleanup Program database.

A review of the VCP list, as provided by EDR, and dated 06/28/2019 has revealed that there are 2 VCP sites within approximately 0.5 miles of the target property.

Equal/Higher Elevation	Address	Direction / Distance	Map ID	Page
CENTRO AUSTURIANO HO Status: CLOSED Comet Site Id: 268895	1302 E 21ST AVE	NNE 1/4 - 1/2 (0.346 mi.)	25	70
Lower Elevation	Address	Direction / Distance	Map ID	Page
PEOPLES GAS SYSTEM	1200 NORTH 13TH STRE	SSE 1/8 - 1/4 (0.139 mi.)	C10	20



Comet Site Id: 65122

#### State and tribal Brownfields sites

BROWNFIELDS: Brownfields are defined by the Florida Department of Environmental Protection (FDEP) as abandoned, idled, or underused industrial and commercial facilities where expansion or redevelopment is complicated by real or perceived environmental contamination.

A review of the BROWNFIELDS list, as provided by EDR, has revealed that there is 1 BROWNFIELDS site within approximately 0,5 miles of the target property.

Equal/Higher Elevation	Address	Direction / Distance	Map ID	Page
CENTRO ASTURIANO PLA		NNE 1/4 - 1/2 (0 282 ml.)	0	17
Database BROWNFIELDS AREAS	Date of Government Version	05/06/2019		

#### ADDITIONAL ENVIRONMENTAL RECORDS

#### Local Brownfield lists

US BROWNFIELDS: The EPA's listing of Brownfields properties from the Cleanups in My Community program, which provides information on Brownfields properties for which information is reported back to EPA, as well as areas served by Brownfields grant programs.

A review of the US BROWNFIELDS list, as provided by EDR, and dated 06/03/2019 has revealed that there are 3 US BROWNFIELDS sites within approximately 0.5 miles of the target property.

Equal/Higher Elevation	Address	Direction / Distance	Map ID	Page
R10 - FOLIO NO. 1868 ACRES property ID: 106261	2813 NORTH 9TH STREE	NW 1/8 - 1/4 (0.217 mi.)	14	39
ACRES property ID: 60011	906 EAST 19TH AVENUE	NW 1/4 - 1/2 (0.273 mi.)	23	66
Lower Elevation	Address	Direction / Distance	Map ID	Page
7TH AVENUE YBOR CITY ACRES property ID: 185021	1410, 1412, 1414, 14	SSE 1/4 - 1/2 (0.474 ml.)	36	123

#### Local Lists of Hazardous waste / Contaminated Sites

Florida Priority Cleaners list comes from the Department of Environmental Protection.

A review of the PRIORITYCLEANERS list, as provided by EDR, and dated 07/15/2019 has revealed that there is 1 PRIORITYCLEANERS site within approximately 0.5 miles of the target property.

Lower Elevation	Address	Direction / Distance	Map ID	Page
EL ENCANTO CLEANERS	1818 N 15TH ST	SSE 1/4 - 1/2 (0.471 mi.)	G35	122



Facility-Site Id: 9500225

Fl Sites: This summary status report is a compilation and revision of other existing lists. It was developed from a number of lists including the Eckhardt list, the Moffit list, the EPA Hazardous Waste Sites list, EPA's Emergency and Remedial Response Information System list (RCRA Section 3012), and existing department lists such as the Obsolete Uncontrolled Hazardous Waste Sites list. The purpose of this list is to track the progress of activities within and outside the department as they relate to the listed sites. It is not a list of uncontrolled sites or sources causing environmental contamination. The Sites List comes from the Department of Environmental Protection.

A review of the FI Sites list, as provided by EDR, and dated 12/31/1989 has revealed that there are 2 FI Sites sites within approximately 1 mile of the target property.

Equal/Higher Elevation	Address	Direction / Distance	Map ID	Page
DEVOE & RAYNOLDS COM EPA ID: FLD130010176 Facility-Site Id: 000451	1010-26 NORTH 19TH S	NNW 1/2- 1 (0,536 ml.)	41	147
Lower Elevation	Address	Direction / Distance	Map ID	Page
PEOPLES GAS SYSTEM Facility-Site Id: 000480	1200 NORTH 13TH STRE	SSE 1/8 - 1/4 (0.139 ml.)	C10	20

#### Other Ascertainable Records

RCRA NonGen / NLR: RCRAInfo is EPA's comprehensive information system, providing access to data supporting the Resource Conservation and Recovery Act (RCRA) of 1976 and the Hazardous and Solid Waste Amendments (HSWA) of 1984. The database includes selective information on sites which generate, transport, store, treat and/or dispose of hazardous waste as defined by the Resource Conservation and Recovery Act (RCRA). Non-Generators do not presently generate hazardous waste

A review of the RCRA NonGen / NLR list, as provided by EDR, and dated 06/24/2019 has revealed that there is 1 RCRA NonGen / NLR site within approximately 0.25 miles of the target property

Lower Elevation	Address	Direction / Distance	Map ID	Page
3 WAY CLEANERS	1420 E COLUMBUS DR	E 1/8 - 1/4 (0.233 ml.)	D16	43
EPA ID:: FLD981921794				

FUDS The Listing includes locations of Formerly Used Defense Sites Properties where the US Army Corps Of Engineers is actively working or will take necessary cleanup actions.

A review of the FUDS list, as provided by EDR, and dated 05/15/2019 has revealed that there is 1 FUDS site within approximately 1 mile of the target property.

Lower Elevation Address		Direction / Distance	Map ID	Page	
FORT BROOKE		S 1/2 - 1 (0.939 mi.)	43	148	



DEDB: Ethylene dibromide (EDB), a soil furnigant, that has been detected in drinking water wells. The amount found exceeds the maximum contaminant level as stated in Chapter 62-550 or 520. It is a potential threat to public health when present in drinking water.

A review of the DEDB list, as provided by EDR, and dated 06/18/2019 has revealed that there is 1 DEDB site within approximately 0.25 miles of the target property

Equal/Higher Elevation	Address	Direction / Distance	Map ID	Page
Not reported	2812 N 9TH STREET	WNW 1/8 - 1/4 (0.229 mi.)	15	42

Florida Drycleaners list comes from the Department of Environmental Protection.

A review of the DRYCLEANERS list, as provided by EDR, and dated 07/22/2019 has revealed that there is 1 DRYCLEANERS site within approximately 0.25 miles of the target property.

Lower Elevation	Address	Direction / Distance	Map ID	Page	
BAYPRO DRY CLEANERS Facility Status: CLOSED Facility-Site Id: 9600543	1420 E COLUMBUS DR	E 1/8 - 1/4 (0.233 mi.)	D17	45	

DWM CONTAM: A listing of active or known sites. The listing includes sites that need cleanup but are not actively being working on because the agency currently does not have funding (primarily petroleum and drycleaning).

A review of the DWM CONTAM list, as provided by EDR, and dated 01/28/2019 has revealed that there are 11 DWM CONTAM sites within approximately 0.5 miles of the target property.

Equal/Higher Elevation	Address	Direction / Distance	Map ID	Page
GOLDSTAR FOODS Program Site Id: 8944840	2317 N NEBRASKA AVE	W 1/8 - 1/4 (0.236 ml.)	18	46
CUSCADEN PARK STATIO Program Site Id: 8627365	3002 N 15TH ST	NE 1/4 - 1/2 (0.369 mi.)	27	76
TAMPA CITY-FIRE DEPT Program Site Id: 8842212	2904 N MITCHELL AVE	NW 1/4 - 1/2 (0.383 ml.)	29	94
VIMAL INVESTMENT LLC Program Site Id: 8625232	3115 N NEBRASKA AVE	NNW 1/4 - 1/2 (0.468 ml.)	33	109
Lower Elevation	Address	Direction / Distance	Map ID	Page
PEOPLES GAS SYSTEM Program Site Id: 65122	1200 NORTH 13TH STRE	SSE 1/8 - 1/4 (0.139 ml.)	C10	20
COLUMBUS FOOD MART Program Site Id: 8624765	1312 E COLUMBUS DR	E 1/8 - 1/4 (0.163 mi.)	12	23
SOUTHERN HYDRAULIC S Program Site Id; 9100548	1502 E COLUMBUS DR	E 1/4 - 1/2 (0.269 ml.)	E21	60
TAMPA ELECTRIC CO-TE Program Site Id: 8839853	1898 NUCCIO PKY	S 1/4 - 1/2 (0.376 mi.)	28	81
EL ENCANTO CLEANERS STAR #1229	1818 N 15TH ST 1802 N NEBRASKA AVE	SSE 1/4 - 1/2 (0.471 mi.) SSW 1/4 - 1/2 (0.485 ml.)	G34 37	132



Program Site Id: 8625656

KWIK STOP 934 E HENDERSON AVE \$\$W 1/4 - 1/2 (0.496 ml.) 40 141
Program Site Id: 8625526

RESP PARTY: Open, inactive and closed responsible party sites

A review of the RESP PARTY list, as provided by EDR, and dated 06/30/2019 has revealed that there are 2 RESP PARTY sites within approximately 0.5 miles of the target property.

Equal/Higher Elevation	Address	Direction / Distance	Map ID	Page	
CENTRO AUSTURIANO HO Site Status; CLOSED	1302 E 21ST AVE	NNE 1/4 - 1/2 (0.346 mi.)	25	70	
Lower Elevation	Address	Direction / Distance	Map ID	Page	
PEOPLES GAS SYSTEM	1200 NORTH 13TH STRE	SSE 1/8 - 1/4 (0.139 mi.)	C10	20	

#### EDR HIGH RISK HISTORICAL RECORDS

#### EDR Exclusive Records

EDR MGP: The EDR Proprietary Manufactured Gas Plant Database includes records of coal gas plants (manufactured gas plants) compiled by EDR's researchers. Manufactured gas sites were used in the United States from the 1800's to 1950's to produce a gas that could be distributed and used as fuel. These plants used whale oil, rosin, coal, or a mixture of coal, oil, and water that also produced a significant amount of waste. Many of the byproducts of the gas production, such as coal tar (oily waste containing volatile and non-volatile chemicals), sludges, oils and other compounds are potentially hazardous to human health and the environment. The byproduct from this process was frequently disposed of directly at the plant site and can remain or spread slowly, serving as a continuous source of soil and groundwater contamination.

A review of the EDR MGP list, as provided by EDR, has revealed that there is 1 EDR MGP site within approximately 1 mile of the target property.

Lower Elevation	Address	Direction / Distance	Map ID	Page
PEOPLES GAS SYSTEM	1200 NORTH 13TH STRE	S 1/2 - 1 (0.704 mi.)	42	147

EDR Hist Auto: EDR has searched selected national collections of business directories and has collected listings of potential gas station/filling station/service station sites that were available to EDR researchers. EDR's review was limited to those categories of sources that might, in EDR's opinion, include gas station/filling station/service station establishments. The categories reviewed included, but were not limited to gas, gas station, gasoline station, filling station, auto, automobile repair, auto service station, service station, etc. This database falls within a category of information EDR classifies as "High Risk Historical Records", or HRHR. EDR's HRHR effort presents unique and sometimes proprietary data about past sites and operations that typically create environmental concerns, but may not show up in current government records searches.

A review of the EDR Hist Auto list, as provided by EDR, has revealed that there are 4 EDR Hist Auto



sites within approximately 0.125 miles of the target property.

Equal/Higher Elevation	Address	Direction / Distance	Map ID	Page
DIEZ GARAGE	2606 12TH ST	SSE 0 = 1/8 (0.014 mi.)	A4	17
LATIN AMERICAN SERVI	1032 E COLUMBUS DR	NW 0 - 1/8 (0.030 mi.)	86	18
LATIN AMERICAN SERVI	1022 E COLUMBUS DRIV	NW 0 - 1/8 (0.031 mi.)	B7	19
Lower Elevation	Address	Address Direction / Distance		Page
GENERAL GARAGE	1017 E COLUMBUS DR	W 0 - 1/8 (0.033 mi.)	B8	19



November 24, 2019 Mr. Jeff Siewert – Ayres Associates 1023 East Columbus Drive Phase I Environmental Assessment OHC Project No. 190238-ES

## **EXECUTIVE SUMMARY**

Due to poor or inadequate address information, the following sites were not mapped. Count: 1 records.


Site Name

Database(s)


HECTOR ALONSO

SWE/LF



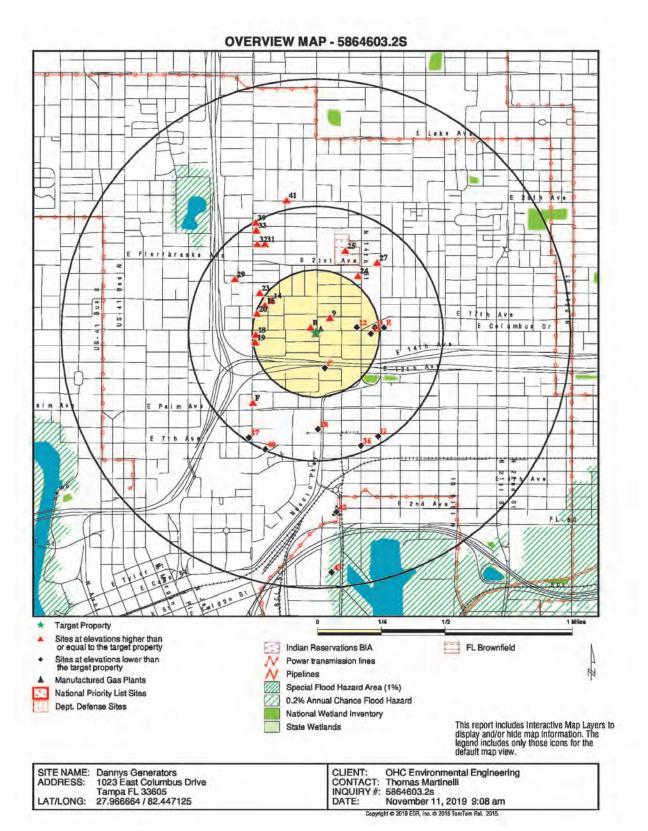



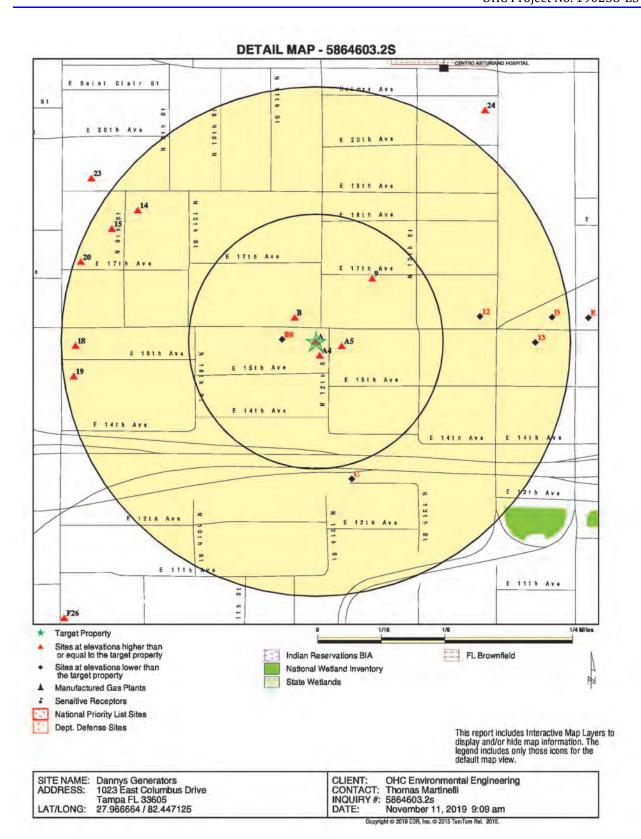



Database	Search Distance (Miles)	Target Property	< 1/8	1/8 - 1/4	1/4 - 1/2	1/2 - 1	<u>* 1</u>	Total Plotted
STANDARD ENVIRONMEN	NTAL RECORDS							
Federal NPL site list								
NPL Proposed NPL NPL LIENS	1.000 1.000 1.000		0	0	0 0	0	NR NR NR	0
Federal Delisted NPL s	ite list							
Delisted NPL	1.000		0	0	0	0	NR	0
Federal CERCLIS list								
FEDERAL FACILITY SEMS	0.500 0.500		0	0	0	NR NR	NR NR	0
Federal CERCLIS NFRA	AP site list							
SEMS-ARCHIVE	0.500		0	0	0	NR	NR	0
Federal RCRA CORRA	CTS facilities I	ist						
CORRACTS	1.000		0	0	0	O	NR	O
Federal RCRA non-COI	RRACTS TSD	facilities list						
RCRA-TSDF	0.500		0	0	0	NR	NR	O
Federal RCRA generate	ors list							
RCRA-LQG RCRA-SQG RCRA-VSQG	0.250 0.250 0.250		0	0	NR NR NR	NR NR NR	NR NR NR	0 0
Federal institutional co engineering controls re								
LUCIS US ENG CONTROLS US INST CONTROL	0.500 0.500 0.500		0	0	0	NR NR NR	NR NR NR	0
Federal ERNS list								
ERNS	TP		NR.	NR	NR	NR	NR	0
State- and tribal - equiv	alent CERCLIS	S						
SHWS	1.000		0	0	0	0	NR	0
State and tribal landfill solid waste disposal si								
SWF/LF	0.500		2	0	4	NR	NR	5
State and tribal leaking	storage tank	lists						
LUST LAST INDIAN LUST	0.500 0.500 0.500	ì	0 0	0 0	10 0 0	NR NR NR	NR NR NR	15 0 0
State and tribal register	red storage tai	nk lists						
FF TANKS	0.250		0	0	NR	NR	NR	0



Database	Search Distance (Miles)	Target Property	< 1/8	1/8 - 1/4	1/4 - 1/2	1/2 - 1	>1	Total Plotted
FEMA UST UST AST INDIAN UST TANKS	0.250 0.250 0.250 0.250 0.250	1	0 1 0 0	0 6 0 0	NR NR NR NR NR	NR NR NR NR NR	NR NR NR NR NR	0 8 0 0
State and tribal institution control / engineering co		es						
ENG CONTROLS INST CONTROL	0.500 0.500		0	0	0	NR NR	NR NR	0
State and tribal voluntar	y cleanup sit	es						
VCP INDIAN VCP	0.500 0.500		0	0	0	NR NR	NR NR	2
State and tribal Brownfi	elds sites							
BROWNFIELDS	0.500		0	O	1	NR	NR	1
ADDITIONAL ENVIRONMENT	NTAL RECORD	s						
Local Brownfield lists								
US BROWNFIELDS	0.500		O	1	2	NR	NR	3
Local Lists of Landfill / 3 Waste Disposal Sites	Solid							
SWRCY INDIAN ODI ODI DEBRIS REGION 9 IHS OPEN DUMPS	0.500 0.500 0.500 0.500 0.500		0 0 0	0 0 0 0	0 0 0 0	ZR ZR ZR ZR ZR	NR NR NR NR NR NR	0 0 0 0
Local Lists of Hazardou Contaminated Sites	s waste /							
US HIST CDL PRIORITYCLEANERS FI Sites US CDL PFAS	TP 0.500 1.000 TP 0.500		NR 0 0 NR 0	NR 0 1 NR 0	NR 1 0 NR 0	NR NR 1 NR NR	NR NR NR NR NR	0 1 2 0
Local Land Records								
LIENS 2	TP		NR	NR	NR	NR	NR	O
Records of Emergency	Release Repo	orts						
HMIRS SPILLS SPILLS 90 SPILLS 80	TP TP TP		NR NR NR NR	NR NR NR NR	NR NR NR NR	NR NR NR NR	NR NR NR NR	0
Other Ascertainable Red	cords							
RCRA NonGen / NLR	0.250		0	1	NR	NR	NR	3



Database	Search Distance (Miles)	Target Property	< 1/8	1/8 - 1/4	1/4 - 1/2	1/2 - 1	× 1	Total Plotted
FUDS	1.000		Ō	0	0	1	NR	1
DOD	1.000		O	ō	ō	Ö	NR	0
SCRD DRYCLEANERS	0.500		ō	0	Ō	NR	NR	ō
US FIN ASSUR	TP		NR	NR:	NR	NR	NR	0
EPA WATCH LIST	TP		NR	NR	NR	NR	NR	0
2020 COR ACTION	0.250		0	0	NR	NR	NR	O
TSCA	TP		NR	NR	NR	NR	NR	0
TRIS	TP		NR	NR	NR	NR	NR	o.
SSTS	TP		NR	NR.	NR	NR	NR	Ö
ROD	1,000		0	0	0	0	NR	0
RMP	TP		NR	NR:	NR	NR	NR	0
RAATS	TP		NR	NR	NR	NR	NR	ō
PRP	TP		NR	NR:	NR	NR	NR	0
PADS	TP		NR	NR	NR	NR	NR	0
icis	TP		NR	NR	NR	NR	NR	0
FTTS	TP		NR	NR	NR	NR	NR	0
MLTS	TP		NR	NR	NR	NR	NR	0
COAL ASH DOE	TP		NR	NR	NR	NR	NR	0
COAL ASH EPA	0.500		0	0	0	NR	NR	0
PCB TRANSFORMER	TP		NR	NR	NR	NR	NR	0
RADINFO	TP		NR	NR	NR	NR	NR	0
HIST FTTS	TP		NR	NR	NR	NR	NR	0
DOT OPS	TP		NR	NR	NR	NR	NR	0
CONSENT	1.000		0	0	0	0	NR	0
INDIAN RESERV	1.000		0	0	0	O	NR	0
FUSRAP	1.000		0	0	0	0	NR	0
UMTRA	0.500		0	Ō	0	NR	NR	0
LEAD SMELTERS	TP		NR	NR	NR	NR	NR	0
US AIRS	TP		NR	NR	NR	NR	NR	0
US MINES	0.250		0	0	NR	NR	NR	0
ABANDONED MINES	0,250		0	0	NR	NR	NR	0
FINDS	TP		NR	NR	NR	NR	NR	O
DOCKET HWC	TP		NR	NR	NR	NR	NR	0
ECHO	TP		NR	NR	NR	NR	NR	0
UXO	1.000		0	0	-0	0	NR	0
FUELS PROGRAM	0.250		0	0	NR	NR	NR	0
AIRS	TP		NR	NR	NR	NR	NR	0
ASBESTOS	TP		NR	NR	NR	NR	NR	0
CLEANUP SITES	TP	1.	NR.	NR	NR	NR	NR	7
DEDB	0.250		0	1	NR	NR	NR	1
DRYCLEANERS	0.250		0	1	NR	NR	NR	4
DWM CONTAM	0.500	1	0	3	8	NR	NR	12
Financial Assurance	TP		NR	NR	NR	NR	NR	0
FL Cattle Dip. Vats	0.250		0	0	NR	NR	NR	0
RESP PARTY	0.500		0	1	1	NR	NR	2
SITE INV SITES	0.500		0	0	0	NR	NR	0
TIER 2	TP		NR	NR	NR	NR	NR	.0
UIC	TP		NR	NR	NR	NR	NR	0
NPDES	TP		NR	NR:	NR	NR	NR	0
MINES MRDS	TP.		NR	NR	NR	NR	NR	0
EDR HIGH RISK HISTORICA	AL RECORDS							
EDR Exclusive Records								
EDR MGP	1.000		0	0	0	1	NR	1



Database	Search Distance (Miles)	Target Property	< 1/8	1/8 - 1/4	1/4 - 1/2	1/2 - 1	÷1_	Total Plotted
EDR Hist Auto EDR Hist Cleaner	0.125 0.125	1	4	NR NR	NR NR	NR NR	NR NR	5
Exclusive Recovered	S = 0 = 14 = 1	VES						
RGA HWS	TP		NR	NR	NR	NR	NR	0
RGA LUST	TP TP	1	NR NR	NR NR	NR	NR NR	NR NR	1
- Totals		.6	6	20	29	3	0	64

#### NOTES:

TP = Target Property

NR = Not Requested at this Search Distance

Sites may be listed in more than one database



Map ID MAP FINDINGS Direction EDR ID Number Distance Elevation Site Database(s) EPA ID Number DANNY'S GENERATORS A1 RGA LUST 3115171631 1023 E COLUMBUS DR Target N/A Property Site 1 of 5 in cluster A Actual: 40 ft. RGA LUST: DANNY'S GENERATORS 1023 E COLUMBUS DR 2011 DANNY'S GENERATORS 1023 E COLUMBUS DR 2010 DANNY'S GENERATORS 1023 E COLUMBUS DR 2009 DANNY'S GENERATORS 1023 E COLUMBUS DR 2008 DANNY'S GENERATORS 1023 E COLUMBUS DR DANNY'S GENERATORS 1023 E COLUMBUS DR 2007 DANNY'S GENERATORS 1023 E COLUMBUS DR 2006 DANNY'S GENERATORS 1023 E COLUMBUS DR 2005 2004 DANNY'S GENERATORS 1023 E COLUMBUS DR DANNY'S GENERATORS 1023 E COLUMBUS DR 2003 2002 DANNY'S GENERATORS 1023 E COLUMBUS DR 2001 DANNY'S GENERATORS 1023 E COLUMBUS DR 2000 DANNY'S GENERATORS 1023 E COLUMBUS DR 1999 DANNY'S GENERATORS 1023 E COLUMBUS DR 1998 DANNY'S GENERATORS 1023 E COLUMBUS DR AZ DANNY'S GENERATORS U001353917 LUST Target 1023 E COLUMBUS DR UST N/A Property **TAMPA, FL 33605** CLEANUP SITES DWM CONTAM Site 2 of 5 in cluster A Actual: 40 ft. LUST. Region: STATE Facility Id. 8508982 Facility Status: CLOSED A - Retail Station Facility Type: Facility Phone: (813)229-1059 Facility Cleanup Rank: 8533 Southwest District District: Lat/Long (dms): 27 58 0.03 / 82 26 49.34 Section: 18 298 Township: 19E Range: Feature: Not reported Method: UNVR Datum: 0 Score: 35 Score Effective Date: 2008-11-14 00:00:00 Score When Ranked 10 DANNY PEREZ Operator Name Update: Not reported Address Update: Not reported Petroleum Cleanup PCT Facility Score: Facility Cleanup Status: ONGO - ONGOING Contact. MANUEL ARNIELLA Contact Company: ARNIELLA, MANUEL Contact Address: 1918 W KENTUCKY AVE Contact City/State/Zip: TAMPA, FL 33607 Phone: (813)876-1029 Bad Address Ind: State: FL



Direction Distance EDR ID Number Elevation Site Database(s) EPA ID Number DANNY'S GENERATORS (Continued) U001353917 Zip: 33605, 3332 Score Score Effective Date: 2008-11-14 00:00:00 Related Party ID 1015 Primary RP Role: ACCOUNT OWNER RP Begin Date: 1991-05-01 RP Zip. Not reported RP Extension. Not reported Discharge Cleanup Summary: Discharge Date: 3/29/1991 PCT Discharge Combined: Not reported R - CLEANUP REQUIRED Cleanup Required: Discharge Cleanup Status: RA - RA ONGOING 11/6/2014 Disch Cleanup Status Date: INACTIVE Cleanup Work Status: A - ABANDONED TANK RESTORATION Information Source: Other Source Description: Not reported Eligibility Indicator E - ELIGIBLE Site Manager COUNCIL\_W Site Mgr End Date: Not reported PCLP29 - HILLSBOROUGH ENVIRONMENTAL PROTECTION COMMISSION Tank Office Discharge Date 7/15/1988

MAP FINDINGS

Petroleum Cleanup Program Eligibility:

PCT Discharge Combined:

Cleanup Required: Discharge Cleanup Status: Disch Cleanup Status Date:

Cleanup Work Status:

Other Source Description.

Information Source:

Eligibility Indicator.

Site Mgr End Date:

Site Manager.

Tank Office

Map ID

Facility ID: 8508982
Discharge Date: 3/29/1991
Pct Discharge Combined With: Not reported

Cleanup Required: R - CLEANUP REQUIRED
Discharge Cleanup Status: RA - RA ONGOING
Disch Cleanup Status Date: 11/6/2014
Cleanup Work Status: INACTIVE

Cleanup Work Status: INACTIVE Information Source: A - ABANDONED TANK RESTORATION

Other Source Description Not reported Application Received Date: 2/27/1991

Cleanup Program: A - ABANDONED TANK RESTORATION PROGRAM

Not reported

5/29/2001

E- EDI

COMPLETED

Not reported

9/20/2012

I - INELIGIBLE

YORK\_CLAIMS

N - NO CLEANUP REQUIRED

NREQ - CLEANUP NOT REQUIRED

 Eligibility Status
 10/1/1991

 Elig Status Date:
 10/1/1991

 Letter Of Intent Date:
 Not reported

 Redetermined:
 No

 Inspection Date:
 5/13/1991

 Site Manager:
 COUNCIL\_W

 Site Mgr End Date:
 Not reported

Tank Office: PCLP29 - HILLSBOROUGH ENVIRONMENTAL PROTECTION COMMISSION

Deductible Amount: 500 Deductible Paid To Date: 500



U001353917

Map ID MAP FINDINGS Direction Distance EDR ID Number Elevation Site Database(s) EPA ID Number

DANNY'S GENERATORS (Continued)

Co-Pay Amount: Co-Pay Paid To Date:

Not reported Cap Amount

Contaminated Media:

3/29/1991 Discharge Date: Pct Discharge Combined With;

Not reported R - CLEANUP REQUIRED Cleanup Required: Discharge Cleanup Status; RA - RA ONGOING Disch Cleanup Status Date: 11/6/2014

Cleanup Work Status: INACTIVE Information Source: A - ABANDONED TANK RESTORATION

Other Source Description: Not reported Elig Indicator: E- ELIGIBLE Site Manager: Site Mgr End Date: COUNCIL\_W

Not reported PCLP29 - HILLSBOROUGH ENVIRONM Tank Office:

Contaminated Drinking Wells: Not reported Contaminated Monitoring Well: Not reported Contaminated Soil Not reported Contaminated Surface Water: Not reported Contaminated Ground Water: Not reported Pollutant: L - Waste Oil Pollutant Other Description: Not reported Gallons Discharged Not reported Discharge Date 3/29/1991

Pcl Discharge Combined With Not reported R - CLEANUP REQUIRED Cleanup Required: RA - RA ONGOING Discharge Cleanup Status:

Disch Cleanup Status Date: 11/6/2014 Cleanup Work Status: INACTIVE

Information Source: A - ABANDONED TANK RESTORATION

Other Source Description: Not reported Elig Indicator: E - ELIGIBLE Site Manager COUNCIL W Site Mgr End Date: Not reported

PCLP29 - HILLSBOROUGH ENVIRONM Tank Office:

Not reported

Contaminated Drinking Wells: Not reported Contaminated Monitoring Well Not reported Contaminated Soil: Not reported Contaminated Surface Water: Not reported Contaminated Ground Water: Not reported Pollutant: P - Generic Gasoline Pollutant Other Description: Not reported

Gallons Discharged:

Task Information: District: SWD Facility ID: 8508982 Facility Status CLOSED A - Retail Station -Facility Type: HILLSBOROUGH County.

County ID 29 Cleanup Eligibility Status. E Source Effective Date: Not reported Discharge Date: 03-29-1991

Cleanup Required: R - CLEANUP REQUIRED Discharge Cleanup Status: RA - RA ONGOING



Map ID MAP FINDINGS Direction Distance EDR ID Number Elevation Site Database(s) EPA ID Number DANNY'S GENERATORS (Continued) U001353917 11-06-2014 Disch Cleanup Status Date: SRC Action Type: SRC Submit Date Not reported SRC Review Date: Not reported SRC Completion Status: SRC Issue Date: Not reported SRC Comment: Not reported Cleanup Work Status. INACTIVE COUNCIL\_W Site Mgr. Site Mgr End Date: Not reported PCLP29 - Hillsborough County Tank Office SR Task ID: Not reported SR Cleanup Responsible: SR Funding Eligibility Type: SR Actual Cost: Not reported SR Completion Date: Not reported SR Payment Date: Not reported SR Oral Date: Not reported SR Written Date: Not reported SR Soil Removal: Not reported SR Free Product Removal: Not reported SR Soil Tonnage Removed: Not reported SR Soil Treatment: Not reported SR Other Treatment Not reported SR Alternate Proc Received Date: Not reported SR Alternate Procedure Status: Not reported SR Alternate Procedure Status Date: Not reported SR Alternale Procedure Comments: Not reported SA Task ID: 89642 SA Cleanup Responsible: SA Funding Eligibility Type: SA Actual Cost: Not reported SA Completion Date: Not reported SA Payment Date: Not reported RAP Task ID: 91433 RAP Cleanup Responsible ID: RAP Funding Eligibility Type: RAP Actual Cost: Not reported RAP Completion Date: Not reported RAP Payment Date: Not reported RAP Last Order Approved: Not reported RA Task ID: 91432 RA Cleanup Responsible: RA Funding Eligibility Type RA Years to Complete: Not reported RA Actual Cost: Not reported District: SWD Facility ID: 8508982 Facility Status CLOSED Facility Type: A - Refail Station -HILLSBOROUGH County: County ID 29 Cleanup Eligibility Status. Source Effective Date: Not reported Discharge Date: 07-15-1988 Cleanup Required: N - NO CLEANUP REQUIRED Discharge Cleanup Status: NREO - CLEANUP NOT REQUIRED



Map ID MAP FINDINGS Direction Distance EDR ID Number Elevation Site Database(s) EPA ID Number DANNY'S GENERATORS (Continued) U001353917 Disch Cleanup Status Date: 05-29-2001 SRC Action Type: SRC Submit Date Not reported SRC Review Date: Not reported SRC Completion Status: SRC Issue Date: Not reported SRC Comment: Not reported Cleanup Work Status. COMPLETED Site Mgr. YORK\_CLAIMS Site Mgr End Date: 09-20-2012 Tank Office SR Task ID: 50137 SR Cleanup Responsible: ST-STATE SR Funding Eligibility Type: SR Actual Cost: Not reported SR Completion Date: Not reported SR Payment Date: Not reported SR Oral Date: Not reported SR Written Date: Not reported SR Soil Removal: Not reported SR Free Product Removal: Not reported SR Soil Tonnage Removed: Not reported SR Soil Treatment: Not reported SR Other Treatment Not reported SR Alternate Proc Received Date: Not reported SR Alternate Procedure Status: Not reported SR Alternate Procedure Status Date: Not reported SR Alternale Procedure Comments: Not reported SA Task ID: 50138 SA Cleanup Responsible: ST-STATE SA Funding Eligibility Type: SA Actual Cost: Not reported SA Completion Date: Not reported SA Payment Date: Not reported RAP Task ID: 50139 RAP Cleanup Responsible ID: ST-STATE RAP Funding Eligibility Type: RAP Actual Cost: Not reported RAP Completion Date: Not reported RAP Payment Date: Not reported RAP Last Order Approved: Not reported RA Task ID: 50140 RA Cleanup Responsible: ST-STATE RA Funding Eligibility Type RA Years to Complete: Not reported RA Actual Cost: Not reported Click here for Florida Oculus: 8508982 Facility Id. Facility Status: CLOSED Type Description: Retail Station 8132291059 Facility Phone: Region: STATE Positioning Method: UNVR

TC5864603.2s Page 12



27 58 0 / 82 26 49

Lat/Long (dms):

Direction Distance EDR ID Number Elevation Site Database(s) EPA ID Number DANNY'S GENERATORS (Continued) U001353917 Owner: Owner ld: ARNIELLA, MANUEL 1918 W KENTUCKY AVE Owner Name. Owner Address: Owner Address 2: Owner City,St,Zip; Not reported TAMPA, FL 33607 MANUEL ARNIELLA Owner Contact: Owner Phone: 8138761029 Tank Info: DANNY'S GENERATORS Name: Address: 1023 E COLUMBUS DR Tank Id: Status: Removed Status Date: 2/28/1991 Install Date: 7/1/1975 Substance: Unleaded gas Content Description: Unleaded Gas Gallons 1000 TANK Vessel Indicator UNDERGROUND Tank Location: DEP Contractor Name. DANNY'S GENERATORS Address 1023 E COLUMBUS DR Tank Id: 10 Removed 2/28/1991 Status: Status Date. Install Date: Not reported Substance: Unleaded gas Content Description: Unleaded Gas Gallons: 200 Vessel Indicator: TANK Tank Location: UNDERGROUND

MAP FINDINGS

 Name:
 DANNY'S GENERATORS

 Address:
 1023 E COLUMBUS DR

 Tank Id:
 2

Status: Removed
Status Date: 2/28/1991
Install Date: 7/1/1975
Substance: Unleaded gas
Content Description: Unleaded Gas
Gallons: 1000
Vessel Indicator TANK

Tank Location: UNDERGROUND

DEP Contractor

DEP Contractor:

Map ID

Name: DANNY'S GENERATORS.
Address: 1023 E COLUMBUS DR

 Tank Id:
 3

 Status:
 Removed

 Status Date:
 2/28/1991

 Install Date:
 7/1/1975

 Substance:
 Unleaded gas



Map ID MAP FINDINGS Direction Distance EDR ID Number Elevation Site Database(s) EPA ID Number

DANNY'S GENERATORS (Continued)

U001353917

Content Description: Unleaded Gas 1000 Gallons Vessel Indicator. TANK Tank Location: UNDERGROUND DEP Contractor

Name: DANNY'S GENERATORS Address: 1023 E COLUMBUS DR Tank ld:

Status: Status Date: Removed 2/28/1991 7/1/1975 Install Date: Unleaded gas Substance: Content Description: Unleaded Gas Gallons: 560 Vessel Indicator: TANK

Tank Location: UNDERGROUND

DEP Contractor:

DANNY'S GENERATORS Name: 1023 E COLUMBUS DR Address:

Tank Id: Removed Status: Status Date: 2/28/1991 Install Date: Not reported Substance: Unleaded gas Content Description: Unleaded Gas Gallons 560 TANK Vessel Indicator.

Tank Location: DEP Contractor UNDERGROUND

Name: DANNY'S GENERATORS Address: 1023 E COLUMBUS DR

Tenk Id: Status: Removed Status Date: 2/28/1991 Install Date: 7/1/1975 Substance: Waste oil Content Description: Waste Oil Gallons: 200 TANK Vessel Indicator:

UNDERGROUND Tank Location:

DEP Contractor:

Name: DANNY'S GENERATORS Address: 1023 E COLUMBUS DR

Tank ld: Status: Removed Status Date: 2/28/1991 Not reported Unleaded gas Substance Unleaded Gas Content Description: Gallons: 560

Vessel Indicator, TANK Tank Location: UNDERGROUND

DEP Contractor



Map ID
Direction
Distance
Elevation Site

MAP FINDINGS

EDR ID Number

EDR ID Number

EPA ID Number

#### DANNY'S GENERATORS (Continued)

U001353917

 Name:
 DANNY'S GENERATORS

 Address:
 1023 E COLUMBUS DR

 Tank Id:
 8

Status: Removed
Status Date: 2/28/1991
Install Date: Not reported
Substance: Unleaded gas
Content Description: Unleaded Gas
Gallons: 1000
Vessel Indicator: TANK

Tank Location: UNDERGROUND

DEP Contractor:

Name: DANNY'S GENERATORS
Address: 1023 E COLUMBUS DR

Tank Id: 9
Status: Removed
Status Date: 2/28/1991
Install Date: Not reported
Substance: Unleaded gas
Content Description: Unleaded Gas
Gallons: 1000
Vessel Indicator: TANK

Tank Location! UNDERGROUND

DEP Contractor

#### Click here for Florida Oculus:

#### CLEANUP SITES:

 Name:
 DANNY'S GENERATORS

 Address:
 1023 E COLUMBUS DR

 City, State, Zip:
 TAMPA, FL 33605

DEP Cleanup Site Key 59734501

Source Database Name: Storage Tank Contamination Monitoring Source Database id: 8508982

Source Database Id: CPAC Program Area Id: TK CLLC Cleanup Category Key: PETRO RSC2 Remediation Status Key: ACTIVE Data Load Date: 08/26/2019 OC3 Office Id: SWD Physical Address Line 2: Not reported OIC Object Of Interest Id: FACIL CENTR PC2 Proximity Id:

Calc Coordinates Accuracy Level Id: 4
CMC2 Coordinate Method Id: Digital Aerial Photography With Ground Control

DC4 Datum Id: High Accuracy Reference Network VSC1 Verification Status: REVIEWED

VSC1 Verification Status: REVIEWED
Collect Username: DAVIS\_B
Collect Date: 07/14/2005

Collect Affiliation: DEPARTMENT OF ENVIRONMENTAL PR

 Map Source;
 1999 dogs

 Map Source Scale;
 4053

 Interpolation Scale,
 Not reported

 Verifler Username;
 DAVIS\_B

Verifier Affiliation: DEPARTMENT OF ENVIRONMENTAL PR

Verification Date: 07/14/2005



Map ID MAP FINDINGS Direction Distance EDR ID Number Elevation Site Database(s) EPA ID Number DANNY'S GENERATORS (Continued) U001353917 Verified Coordinate Method Id: Digital Aerial Photography With Ground Control Source Database Name Code STCM CMC2 Coordinate Method ID Code: DPHO DC4 Datum ID Code: HARN Verified Coordinate Method ID Code DPHO Not reported Latitude/Longitude (deg/min/sec); 27 58 0.03 / 82 26 49.34 DWM CONTAM Program Site Id: 8508982 Lat DD: Lat MM: 58 Lat SS: 0.03 Long DD: 82 Long MM: 26 Long SS: 49.34 Office/ District: SWD Program Area: Storage Tanks Offsite Contamination Not reported Project Manager: Not reported Priority Score: 35 Datum: Method: UNVR Facility Status. CLOSED Feature Not reported Section 18 Township: 298 Range: 19E Staff Assigned: Not reported Priority (Y/N): Not reported LATIN AMERICAN SERVICE STATION EDR Hist Auto 1009103278 A3 1023 E COLUMBUS DR Target N/A TAMPA, FL Property Site 3 of 5 in cluster A Actual: **EDR Hist Auto** 40 ft. Year: LATIN AMERICAN SERVICE STATION GASOLINE AND OIL SERVICE STATIONS 1939 LATIN AMERICAN SERVICE STATION GASOLINE AND OIL SERVICE STATION 1944 AMRNELLA MANUEL GASOLINE AND OIL SERVICE STATIONS 1949 LATIN AMERICAN SERVICE STATION GASOLINE SERVICE STATIONS 1959 LATIN AMIERICAN SERVICE STATION GASOLINE STATIONS 1962 LATIN AMERICAN SERVICE STATION GASOLINE STATIONS 1969 LATIN AMERICAN SERVICE STATION GASOLINE STATIONS 1969 LATIN AMERICAN SERVICE Gasoline Service Stations Gasoline Service Stations LATIN AMERICAN SERVICE 1970 LATIN AMERICAN SERVICE 1971 Gasoline Service Stations LATIN AMERICAN SERVICE 1972 Gasoline Service Stations 1973 LATIN AMERICAN SERVICE Gasoline Service Stations 1974 LATIN AMERICAN SERVICE STATION GASOLINE STATIONS 1976 LATIN AMERICAN SERVICE Gasoline Service Stations 1978 LATIN AMERICAN SERVICE STATION GASOLINE STATION 1979 LATIN AMERICAN SERVICE Gasoline Service Stations 1980 LATIN AMERICAN SERVICE Gasoline Service Stations



Map ID		MAP FINDINGS		
Direction Distance Elevation	Site	Database(s)	EDR ID Number	
A1 Target Property	DANNY'S GENERATORS 1023 E COLUMBUS DR TAMPA, FL		RGA LUST	S115171631 N/A
	Site 1 of 5 in cluster A			
Actual:	2011 DAI 2010 DAI 2009 DAI 2008 DAI 2007 DAI 2006 DAI 2005 DAI 2004 DAI 2003 DAI 2002 DAI 2001 DAI 2001 DAI 2000 DAI	INY'S GENERATORS 1023 E COLUMBI INY'S GENERATORS 1023 E COLUMBI	US DR	
AZ Target Property	DANNY'S GENERATORS 1023 E COLUMBUS DR TAMPA, FL 33605		LUST UST CLEANUP SITES DWM CONTAM	U001353917 N/A
Actual: 40 ft.	Site 2 of 5 in cluster A  LUST: Region: Facility Id: Facility Status: Facility Type: Facility Phone: Facility Cleanup Rank: District: Lat/Long (dms): Section: Township: Range: Feature: Method: Datum: Score: Score Effective Date: Score When Ranked: Operator: Name Update: Address Update:	STATE 8508982 CLOSED A - Retail Station (813)229-1059 8533 Southwest District 27 58 0.03 / 82 26 49.34 18 29S 19E Not reported UNVR 0 35 2008-11-14 00:00:00 10 DANNY PEREZ Not reported Not reported		
	Petroleum Cleanup PCT Facility Facility Cleanup Status: Contact; Contact Company; Contact Address; Contact City/State/Zip; Phone: Bad Address Ind; State:			



# ATTACHMENT V

# **Local/State Search Information**



From: Figari, leannette
To: Tom Martinelli

RE: PRR - 2317 N. Nebraska Ave, 1023 E. Columbus Drive, 1312 E. Columbus Drive

Date: Friday, November 15, 2019 1:43:07 PM

Good afternoon Mr. Marinelli,

In follow up to the response I sent yesterday, I just wanted to confirm that the Air, Water and Wetlands Divisions did not locate any records for the three properties in question.

Sincerely,

Subject:

#### Jeannette Figari

Legal Administrative Assistant Legal Department (813) 627-2600 ext. 1054 | www.enchc.org

Variation and Principles of the Control of the Cont

#### **Environmental Protection Commission**

3629 Queen Palm Drive, Tampa, FL 33619

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From: Figari, Jeannette

**Sent:** Thursday, November 14, 2019 2:29 PM **To:** Tom Martinelli < tmartinelli@ohcnet.com>

Subject: FW: PRR - 2317 N. Nebraska Ave, 1023 E. Columbus Drive, 1312 E. Columbus Drive

Good afternoon Mr. Martinelli,

As we discussed, included below is the response from our Waste Division. Please contact Pat Pons at  $813-627-2600 \times 1204$  and she will be able to let you know if the records are paper records or electronic records.

Sincerely,

#### Jeannette Figari

Legal Administrative Assistant
Legal and Administrative Services Division
(813) 627-2600 ext. 1054 | www.epchc.org



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From: Pons, Pat < Pons@epchc.org>

Sent: Wednesday, November 13, 2019 1:10 PM To: Figari, Jeannette < Figari, @epchc.org >

Subject: RE: PRR - 2317 N. Nebraska Ave, 1023 E. Columbus Drive, 1312 E. Columbus Drive

Hi Jeannette,

The Waste Division has the following records for these locations:

2317 North Nebraska:
Enforcement Case — 14-44840
Warning Notices - #31073, #31074, #15834, #2005-2554H, #12160 and #2011-0158H
Tanks — Facility ID — 298944840
Cleanup- 298944840

1023 East Columbus Drive SQG -Yes Tanks — Facility ID — 298508982 Cleanup — 298508982

1312 East Columbus Drive
Enforcement Case – 01-24765 and 99-18467
Warning Notices - #18467, #21316, #2016-0085H, #2016-0086H and #2015-278H
Tanks – Facility ID – 298624765
Cleanup – 298624765

Pat

Patricia Pons

Environmental Specialist III Waste Management Division (813) 627-2600 ext. 1204/www.epchc.org

**Environmental Protection Commission** 



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From: Figari, Jeannette < FigariJ@epchc.org>

Sent: Tuesday, November 12, 2019 11:16 AM

To: Castillo, Laura < castillol@epchc.org>; Hager, Margaret < Hager@epchc.org>; Merchant, Sabatia

<merchants@epchc.org>; Mishriki, Madlein < Mishriki@epchc.org>; Myrick, Joyce

<mvricki@epchc.org>; Noblitt, Paula <NoblittP@epchc.org>; Pons, Pat <Pons@epchc.org>; Reese,

 ${\sf Marsha} < \!\! \underbrace{{\sf Reese@epchc.org}}; {\sf Sanchez, Silvia} < \!\! \underbrace{{\sf sanchezs@epchc.org}}; {\sf Torres, Gladys}$ 

<torresg@epchc.org>

Cc: Barthle, Beth < barthler@epchc.org>; Blount, Marvin < Blount@epchc.org>; Boostani, Hooshang

<Boostani@epchc.org>; Elrabi, Sam <<u>Elrabi@epchc.org</u>>; Schipfer, Andy <<u>Schipfer@epchc.org</u>>;

Sims, Jeff < Sims 1@epchc.org >; Woodard, Sterlin < Woodard@epchc.org >

Subject: PRR - 2317 N. Nebraska Ave, 1023 E. Columbus Drive, 1312 E. Columbus Drive

The Legal Dept. received a request for records pertaining to the following properties:

2317 N. Nebraska Ave, Tampa - folio #198390-0000

1023 E. Columbus Drive, Tampa - folio #198262-0000

1312 E. Columbus Drive, Tampa - folio #186699-0000.

Please let me know by Monday, November 18, 2019 if your Division does or does not have any records.

Thank you,

# Jeannette Figari

Legal Administrative Assistant
Legal and Administrative Services Division
(813) 627-2600 ext. 1054 | www.epchc.org

#### **Environmental Protection Commission**

3629 Queen Palm Drive, Tampa, FL 33619

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 From:
 Figari, Jeannette

 To:
 Tom Martinelli

 Subject:
 RE: Right to Know Request

Date: Tuesday, November 12, 2019 9:48:47 AM

Good morning Mr. Martinelli,

The Environmental Protection Commission of Hillsborough County received your records request and will initiate an Agency-wide records search in accordance with Chapter 119, F.S. We are glad to assist in locating any responsive records and will contact you regarding the outcome of the search as soon as possible.

If you have any questions, please feel free to contact me.

Sincerely,

### Jeannette Figari

Legal Administrative Assistant Legal and Administrative Services Division (813) 627-2600 ext. 1054 | www.epchc.org

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From: Tom Martinelli <tmartinelli@ohcnet.com>
Sent: Monday, November 11, 2019 9:00 AM
To: Figari, Jeannette <FigariJ@epchc.org>

Subject: Right to Know Request

Please search your records for any spills, discharges, hazardous materials releases, underground/aboveground storage tanks, environmental remediation activities, etc. for the sites listed below. Thanks.

O-Henry's Foods Inc.



Parcel #A-18-29-19-51D-000000-00001.0 2317 N NEBRASKA AVE, TAMPA 33602

Danny's Generators-Ramos, Deborah Lisa Parcel #A-18-29-19-51A-000000-1-00001.0 1023 E COLUMBUS DR, TAMPA 33605

Columbus Foods-Pearl Managementco Inc. Parcel #A-07-29-19-4UV-000000-00048.0 1312 E COLUMBUS DR, TAMPA 33605



 From:
 FireMarshall

 To:
 Tom Martinelli

Subject: RE: Right to Know Request

Date: Tuesday, November 12, 2019 9:07:18 AM

Attachments: jmage003.png jmage004.png

Good morning Mr. Martinelli,

Those properties are in the City of Tampa jurisdiction, please contact the City of Tampa Fire Marshal's office at 813-274-7000 to request those records.

# Thank you, have a blessed day.

### Miguelina (Betty) Rodriguez

Administrative Assistant Hillsborough County Fire Rescue

P: (813) 744-5541 F: (813) 744-5794

E: RodriguezMB@HCFLGov.Net

W HCFLGov.net

# Hillsborough County Fire Rescue

9450 E. Columbus Drive, Tampa, FL 33619

Facebook | Twitter | YouTube | LinkedIn

Please note: All correspondence to or from this office is subject to Florida's Public Records law,



From: Tom Martinelli [mailto:tmartinelli@ohcnet.com]

Sent: Monday, November 11, 2019 9:18 AM

To: FireMarshall <FireMarshal@HillsboroughCounty.ORG>

Subject: Right to Know Request

### [External]

Please provide any emergency response incident records at the properties listed below. Thanks

O-Henry's Foods Inc. Parcel #A-18-29-19-51D-000000-00001.0 2317 N NEBRASKA AVE, TAMPA 33605

Danny's Generators-



Ramos, Deborah Lisa Parcel #A-18-29-19-51A-000000-1-00001.0 1023 E COLUMBUS DR, TAMPA 33602

Columbus Foods-Pearl Managementco Inc. Parcel #A-07-29-19-4UV-000000-00048.0 1312 E COLUMBUS DR, TAMPA 33602

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# Dannys Generators

1023 East Columbus Drive Tampa, FL 33605

Inquiry Number: 5864603.5 November 11, 2019

# The EDR-City Directory Abstract



6 Armstrong Road Shelton, CT 96484 800.352.0050 www.edrnet.com



#### TABLE OF CONTENTS

#### SECTION

**Executive Summary** 

**Findings** 

City Directory Images

Thank you for your business.

Please contact EDR at 1-800-352-0050 with any questions or comments.

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#### **EXECUTIVE SUMMARY**

#### DESCRIPTION

Environmental Data Resources, Inc.'s (EDR) City Directory Abstract is a screening tool designed to assist environmental professionals in evaluating potential liability on a target property resulting from past activities. EDR's City Directory Abstract includes a search and abstract of available city directory data. For each address, the directory lists the name of the corresponding occupant at five year intervals.

Business directories including city, cross reference and telephone directories were reviewed, if available, at approximately five year intervals for the years spanning 1920 through 2014. This report compiles information gathered in this review by geocoding the latitude and longitude of properties identified and gathering information about properties within 660 feet of the target property.

A summary of the information obtained is provided in the text of this report.

#### RECORD SOURCES

EDR's Digital Archive combines historical directory listings from sources such as Cole Information and Dun & Bradstreet. These standard sources of property information complement and enhance each other to provide a more comprehensive report.

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#### RESEARCH SUMMARY

The following research sources were consulted in the preparation of this report. An "X" indicates where information was identified in the source and provided in this report.

<u>Year</u>	Source	<u>TP</u>	<u>Adjoining</u>	Text Abstract	Source Image
2014	EDR Digital Archive	-1	X	X	-
2010	EDR Digital Archive		X	X	
	EDR Digital Archive	X	X	X	·
2005	EDR Digital Archive	-	X	X	-
	EDR Digital Archive	X	X	X	u .
2004	Cole Publishing	-	X	X	-
1999	Hill-Donnelly Corporation		X	X	X
1993	R. L. Polk Co.		X	X	X
	R. L. Polk Co.	X	X	X	X
1988	R. L. Polk Co.	v.	X	X	X
	R. L. Polk Co.	X	X	X	X
1986	R. L. Polk & Co.	-	-	-	-

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EXECUTIVE SUMMARY					
<u>Year</u>	Source	IP	Adjoining	Text Abstract	Source Imag
1983	R. L. Polk Co.	-	×	×	×
	R. L. Polk Co.	x	×	X	X
1980	R.L. POLK & GO.	-		4	*
978	R. L. Polk Co.	2	X	X	×
	R. L. Polk Co.	×	×	×	×
975	R.L. POLK & CO.		9		40
974	R. L. Polk Co.	-	×	X	X
	R. L. Polk Co.	х	×	X	x
971	R.L. POLK & CO.	-			8
969	R. L. Polk & Co.	1.0	X	X	×
	R. L. Polk & Co.	X	×	X	X
966	R.L. POLK & CO.	-		(*4)	
964	R.L. POLK & CO. PUBLISHERS	-	100	540	-
963	R.L POLK & GO.	-	44		36
962	R L Polk Go	-	×	X	×
	R L Polk Co	X	×	X	X
959	R L Polk Co	-	×	X	X
	R L Polk Co	X	X	X	X
955	R L Polk Co	8	×	×	×
	R L Polk Co	X	×	×	×
949	R L Polk, Co	-	×	×	×
	R L Polk Co	x	×	×	X
944	R. L. Polk Co. Publishers	-	×	×	x
	R. L. Polk Co. Publishers	X	×	X	x
939	R. L. Polk Co.	2	×	X	X
934	R. L. Polk Co.	-	×	×	×
	R. L. Polk Co.	X	X	X	×
930	R. L. Polk Co.	244	×	×	×
925	R. L. Polk Co.	-	×	X	×
920	R. L. Polk Co.	_	X	X	X

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Image pg. A14

# **FINDINGS**

# TARGET PROPERTY INFORMATION

# ADDRESS

1023 East Columbus Drive Tampa, FL 33605

# FINDINGS DETAIL

Target Property research detail.

# COLUMBUS DR

# 1023 COLUMBUS DR

<u>Year</u>	<u>Uses</u>	Source
1993	Vacant	R. L. Polk Co.

# COLUMBUS DR E

# 1023 COLUMBUS DR E

Year	<u>Uses</u>	Source	
1978	atin kerican Service Station	R. L. Polk Co.	Image pg. A47
1974	Latin American Service Station	R. L. Polk Co.	Image pg. A61
1969	LATIN AMERICAN SERVICE STATION	R. L. Polk & Co.	Image pg. A71
1944	Latin American Service Sta filling sta	R. L. Polk Co, Publishers	Image pg. A128
1934	Latin Am Service Sta	R. L. Polk Co.	Image pg. A179

# E Columbus Dr

# 1023 E Columbus Dr

<u>Year</u>	<u>Uses</u>	Source
2010	LATIN AMERICAN SERVICE	EDR Digital Archive
2005	LATIN AMERICAN SERVICE	EDR Digital Archive
	LEROME HOWARD PRESSURE CLEANIN	EDR Digital Archive

### E COLUMBUS DR

# 1023 E COLUMBUS DR

<u>Year</u>	Uses	Source	
1988	Cabrera Lourdes	R. L. Polk Co.	Image pg. A24
	Latin American Service Station	R. L. Polk Co.	Image pg. A24
1983	Latin American Service Station	R. L. Polk Co.	Image pg, A34
1962	Latin American Serv St	R L Polk Co	Image pg. A83

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		FINDINGS	
Year	Uses	Source	
1959	Latin American Serv St	R L Polk Co	Image pg. A93
1955	Latin American Serv	R L Polk Co	Image pg. A104
1949	Arniella Manuel fill sta	R L Polk Co	Image pg. A114

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Page 3



# **ATTACHMENT VI**

Sanborn Map Report



Dannys Generators 1023 East Columbus Drive Tampa, FL 33605

Inquiry Number: 5864603.3

November 11, 2019

# **Certified Sanborn® Map Report**



6 Armstrong Road, 4th floor Shelton, CT 06484 Toll Free: 800.352.0050 www.edrnet.com



# Certified Sanborn® Map Report

11/11/19

Site Name:

Client Name:

Dannys Generators 1023 East Columbus Drive Tampa, FL 33605

OHC Environmental Engineering 5420 Bay Center Drive Suite 100 Tampa, FL 33609-0000

EDR Inquiry # 5864603.3 Contact: Thomas Martinelli

The Sanborn Library has been searched by EDR and maps covering the target property location as provided by OHC Environmental Engineering were identified for the years listed below. The Sanborn Library is the largest, most complete collection of fire insurance maps The collection includes maps from Sanborn, Bromley, Perris & Browne, Hopkins, Barlow, and others. Only Environmental Data Resources Inc. (EDR) is authorized to grant rights for commercial reproduction of maps by the Sanborn Library LLC, the copyright holder for the collection. Results can be authenticated by visiting www.edrnet.com/sanborn.

The Sanborn Library is continually enhanced with newly identified map archives. This report accesses all maps in the collection as of the day this report was generated

#### Certified Sanborn Results:

Certification # E0B9-4D57-A807

PO#

Project 1023 East Columbus Drive

### Maps Provided:

1979

1976


1950 1931

1915



Certification #: E0B9-4D57-A807

The Sanborn Library includes more than 1.2 million fire insurance maps from Sanborn, Bromley, Perris & Browne, Hopkins, Barlow and others which track historical property usage in approximately 12,000 American cities and towns. Collections searched:

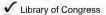

University Publications of America



The Sanborn Library LLC Since 1866™

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#### Sanborn Sheet Key

This Certified Sanborn Map Report is based upon the following Sanborn Fire Insurance map sheets.



#### 1979 Source Sheets







Volume 1, Sheet 68



Volume 3 & 6, Sheet 312



Volume 3 & 6, Sheet 314

### 1976 Source Sheets



Volume 1, Sheet 67



Volume 1, Sheet 68

# 1950 Source Sheets



Volume 3, Sheet 312



Volume 3, Sheet 314



Volume 1, Sheet 67



Volume 1, Sheet 68

### 1931 Source Sheets



Volume 3, Sheet 312



Volume 3, Sheet 314



Volume 1, Sheet 67



Volume 1, Sheet 68

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# Sanborn Sheet Key

This Certified Sanborn Map Report is based upon the following Sanborn Fire Insurance map sheets.



#### 1915 Source Sheets





Volume 1. Sheet 61

Volume 1 Sheet 62

OHC

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# **ATTACHMENT VII**

# **Historic Topographic Maps**



Dannys Generators 1023 East Columbus Drive Tampa, FL 33605

Inquiry Number: 5864603.4

November 11, 2019

# **EDR Historical Topo Map Report**

with QuadMatch™



6 Armstrong Road, 4th floor Shelton, CT 06484 Toll Free: 800.352.0050 www.edrnet.com



# **EDR Historical Topo Map Report**

11/11/19

Site Name:

**Client Name:** 

**Dannys Generators** 1023 East Columbus Drive Tampa, FL 33605

EDR Inquiry # 5864603.4

**OHC Environmental Engineering** 5420 Bay Center Drive Suite 100 Tampa, FL 33609-0000



EDR Topographic Map Library has been searched by EDR and maps covering the target property location as provided by OHC Environmental Engineering were identified for the years listed below. EDR's Historical Topo Map Report is designed to assist professionals in evaluating potential liability on a target property resulting from past activities. EDRs Historical Topo Map Report includes a search of a collection of public and private color historical topographic maps, dating back to the late 1800s

Contact: Thomas Martinelli

Search Resi	ılts:	Coordinates:	
P.O.#	NA	Latitude:	27.966664 27° 58′ 0" North
Project:	1023 East Columbus Drive	Longitude:	-82.447125 -82° 26' 50" West
		UTM Zone:	Zone 17 North
		UTM X Meters:	357662.72
		UTM Y Meters:	3094352.65
		Elevation:	40.00' above sea level
Mans Provid	led:		

2012

1995

1981

1979

1969

1956

1947 1944

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# Topo Sheet Key

This EDR Topo Map Report is based upon the following USGS topographic map sheets.

#### 2012 Source Sheets



Tampa

7.5-minute, 24000

### 1995 Source Sheets



Tampa

7.5-minute, 24000 Aerial Photo Revised 1995

# 1981 Source Sheets



Tampa

7.5-minute, 24000 Aerial Photo Revised 1979

### 1979 Source Sheets



TAMPA

15-minute, 50000

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# Topo Sheet Key

This EDR Topo Map Report is based upon the following USGS topographic map sheets.

#### 1969 Source Sheets



Tampa

7.5-minute, 24000 Aerial Photo Revised 1969

#### 1956 Source Sheets



Tampa

7.5-minute, 24000 Aerial Photo Revised 1954

### 1947 Source Sheets



Tampa

7.5-minute, 25000 Aerial Photo Revised 1942

### 1944 Source Sheets




Tampa


7.5-minute, 31680 Aerial Photo Revised 1942

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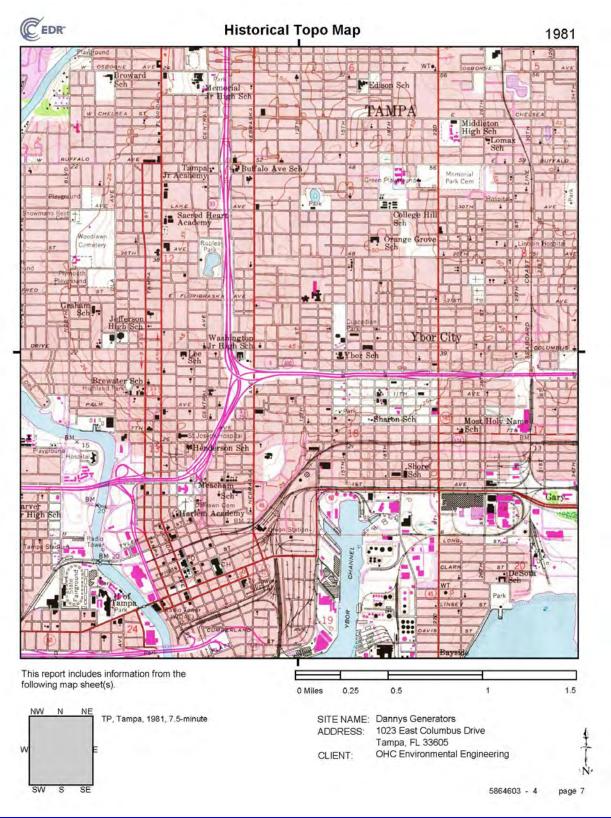




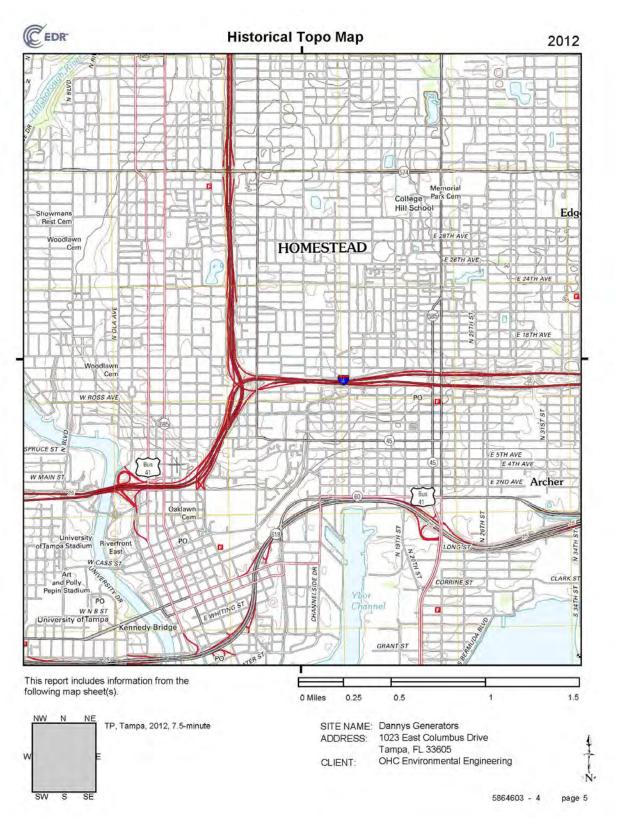




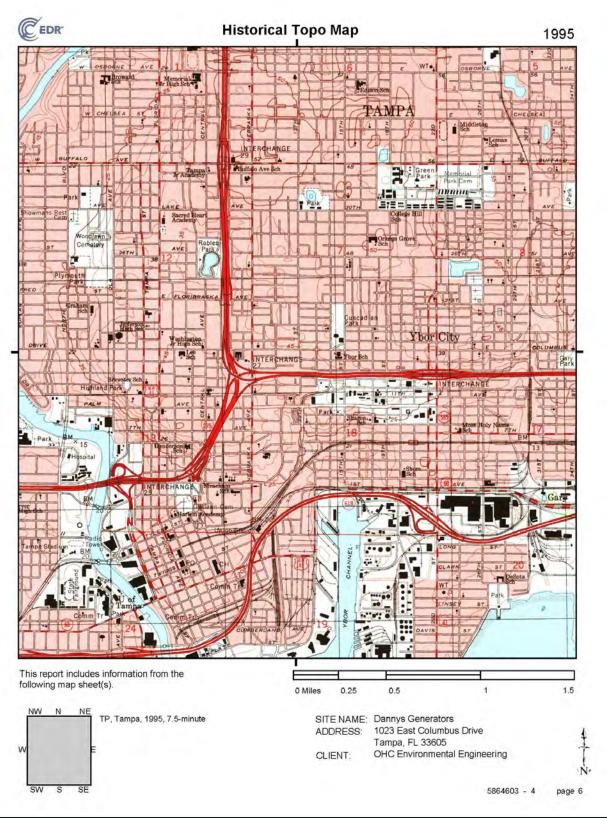







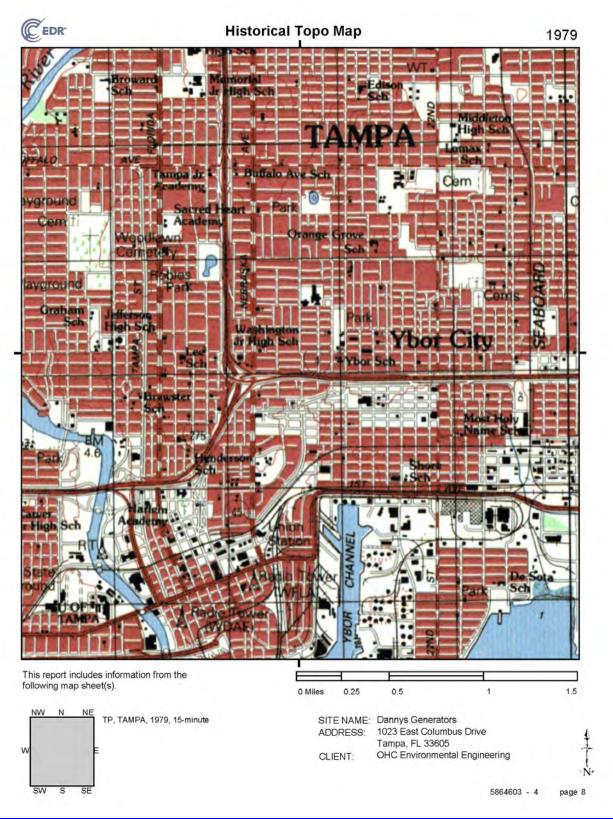




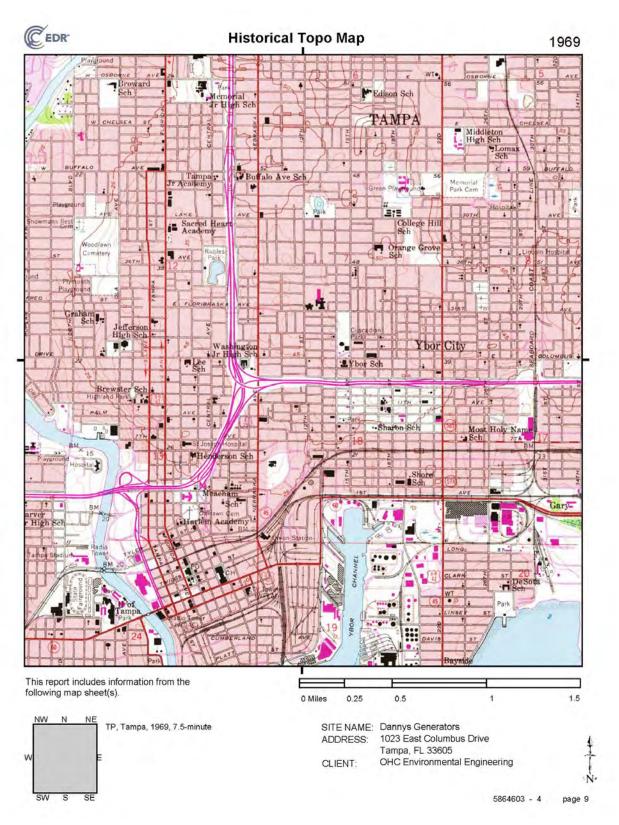




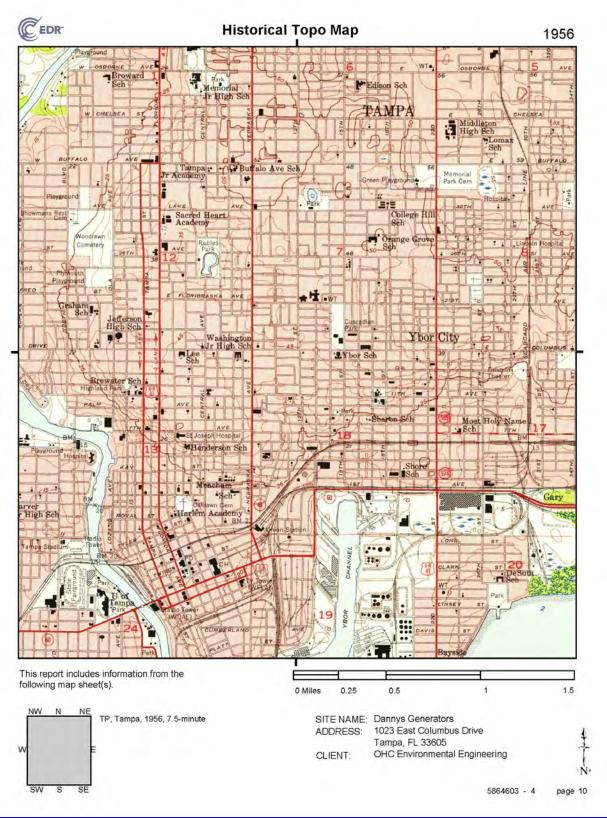



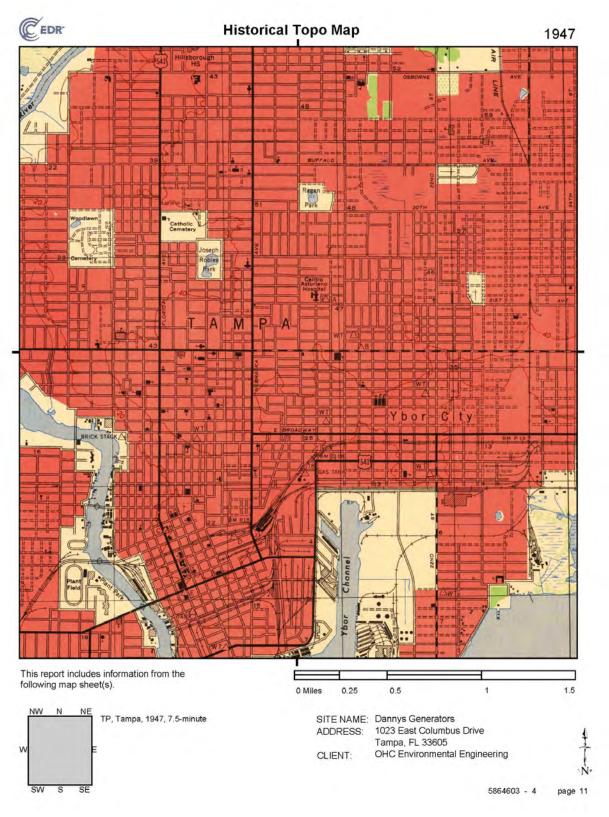



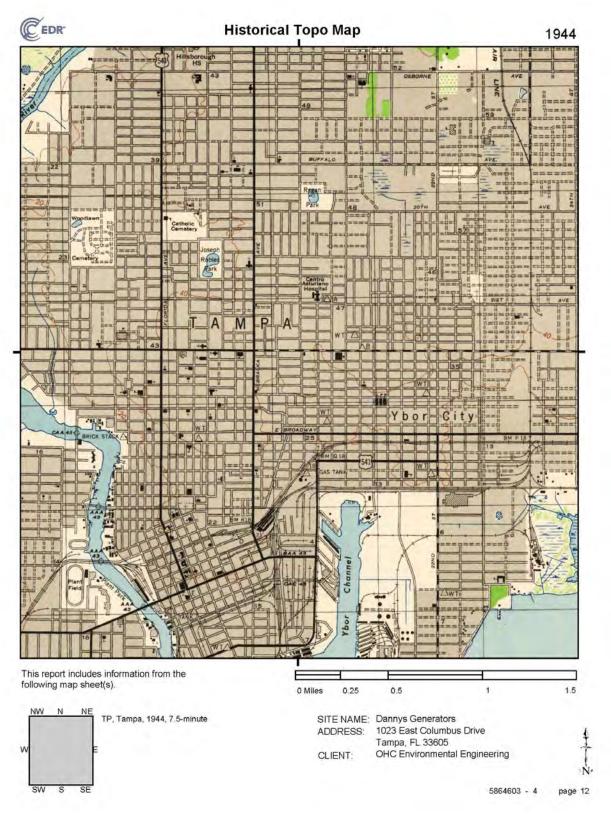



# **ATTACHMENT VIII**

**Aerial Photographs** 



# **Dannys Generators**

1023 East Columbus Drive Tampa, FL 33605

Inquiry Number: 5864603.8

November 11, 2019

# The EDR Aerial Photo Decade Package



6 Armstrong Road, 4th floor Shelton, CT 06484 Toll Free: 800.352.0050 www.edrnet.com



# EDR Aerial Photo Decade Package

11/11/19

Site Name:

Client Name:

**Dannys Generators** 1023 East Columbus Drive Tampa, FL 33605

EDR Inquiry # 5864603.8

OHC Environmental Engineering 5420 Bay Center Drive Suite 100 Tampa, FL 33609-0000



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Contact: Thomas Martinelli

Search Results:				
Year	Scale	Details	Source	
2017	1"=500"	Flight Year: 2017	USDA/NAIP	
2010	1"=500'	Flight Year: 2010	USDA/NAIP	
2007	1"=500"	Flight Year: 2007	USDA/NAIP	
1998	1"=500"	Acquisition Date: December 31, 1998	USGS/DOQQ	
1995	1"=500"	Flight Date: March 20, 1995	FDOT	
1991	1"=500'	Flight Date: April 01, 1991	FDOT	
1987	1"=500"	Flight Date: October 22, 1987	USGS	
1980	1"=500"	Flight Date: October 13, 1980	FDOT	
1976	1"=500"	Flight Date: January 09, 1976	FDOT	
1973	1"=500'	Flight Date: February 17, 1973	FDOT	
1965	1"=500"	Flight Date: October 27, 1965	FDOT	
1957	1"=500'	Flight Date: March 23, 1957	U of FL	
1950	1"=500'	Flight Date: April 07, 1950	USGS	
1938	1"=500'	Flight Date: November 28, 1938	U of FL	

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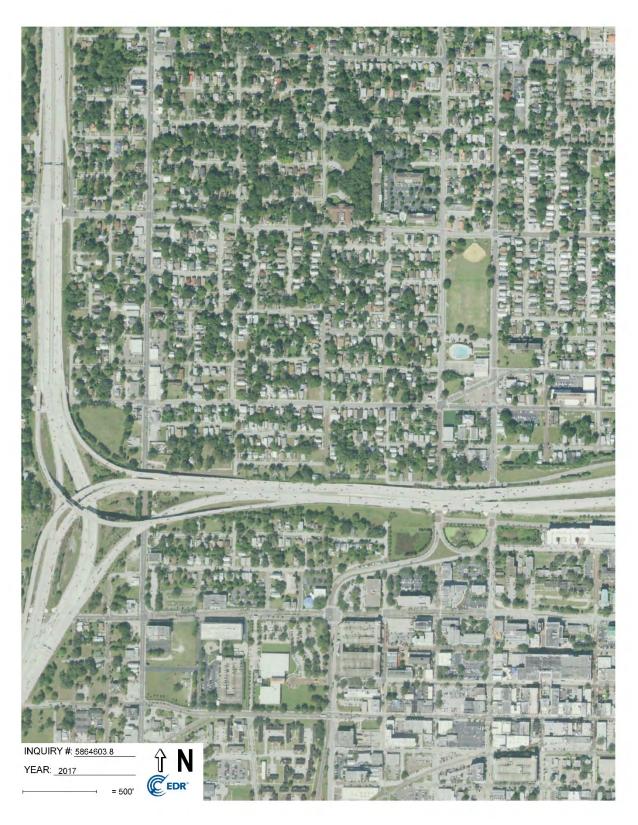
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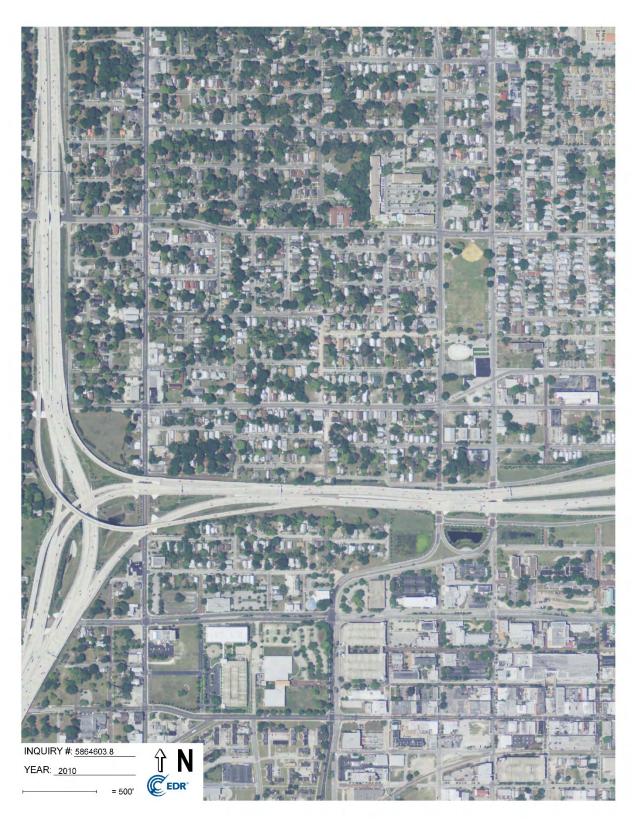
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5864603 - 8












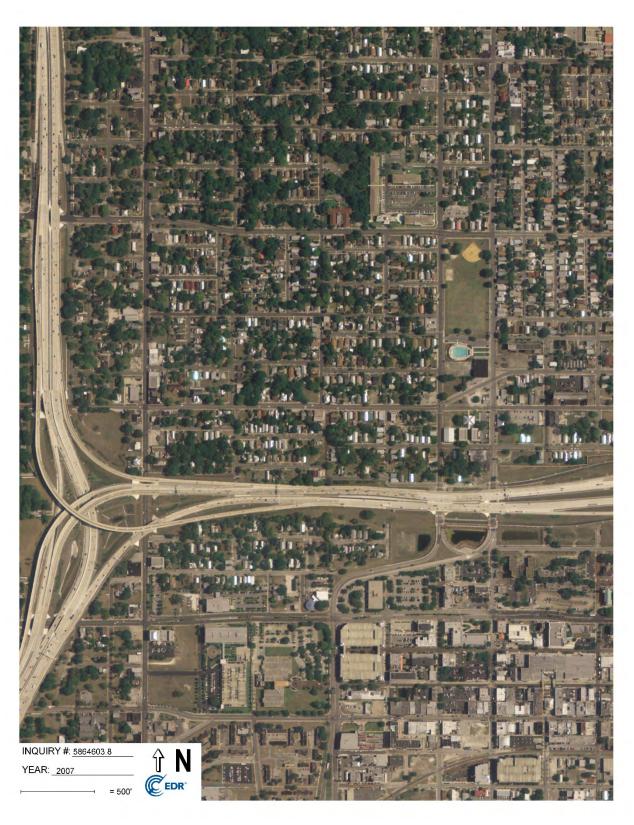





































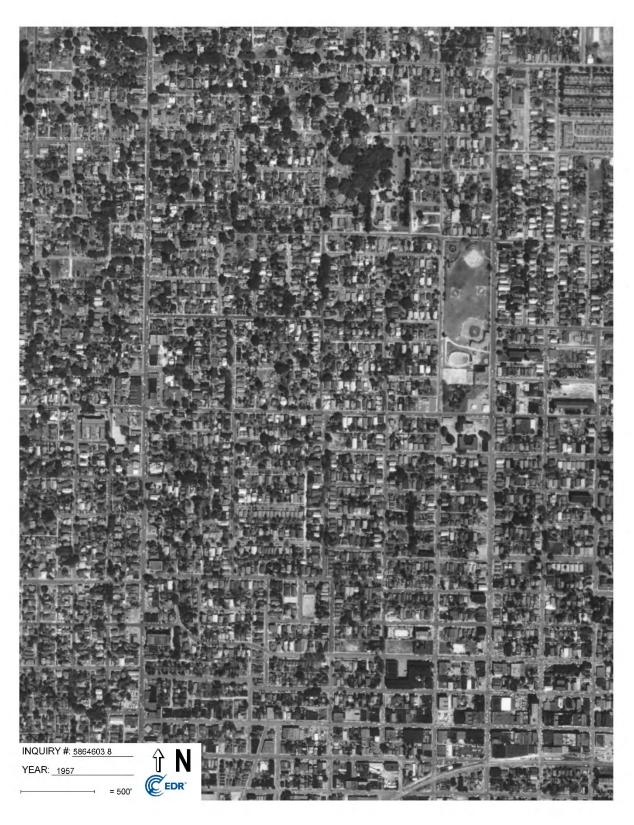



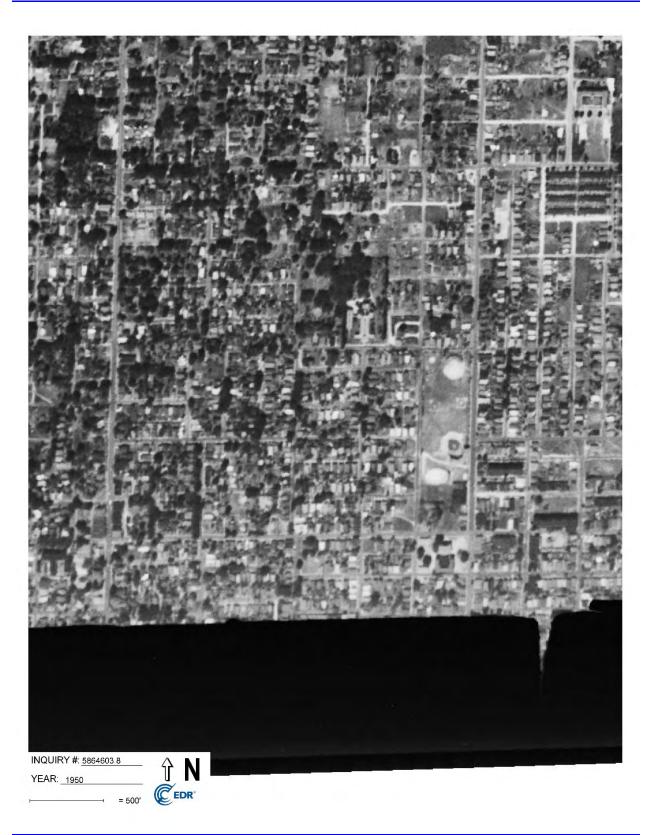







### **ATTACHMENT IX**

### **Consultant Credentials**





organized to improve the practice of industrial hygiene proclaims that

## Jim F. Rizk

having met all requirements of education, experience and examination, and ongoing maintenance, is hereby certified in the

#### COMPREHENSIVE PRACTICE of INDUSTRIAL HYGIENE

and has the right to use the designations

#### CERTIFIED INDUSTRIAL HYGIENIST

#### CIH

Certificate Number 3956 CP

Awarded: June 30, 1988

Expiration Date: December 1, 2020

luck George

Chief Executive Officer, ABIH





#### TOM MARTINELLI

Is Awarded 2.1 CEU'S

for successful completion of the course on

Phase I and Phase II Environmental Site Assessments for Commercial Real Estate

October 16-18, 2007

Harrisburg, PA





# Phase I Environmental Assessment Report

Performed at:

Columbus Foods 1312 East Columbus Drive Tampa, FL 33605

**Report Prepared For:** 

Mr. Jeff Siewert, Senior Project Manager Ayres Associates 8875 Hidden River Parkway Tampa, Florida 33637-1035

Report Prepared By:

OHC ENVIRONMENTAL ENGINEERING

OHC Environmental Engineering, Inc. 101 South Hoover Blvd, Suite 101 Tampa, Florida 33609

OHC Project #190239-ES

November 24, 2019

#### Sanborn Sheet Key

This Certified Sanborn Map Report is based upon the following Sanborn Fire Insurance map sheets.



#### 1979 Source Sheets







Volume 1, Sheet 69



Volume 3 & 6, Sheet 31



Volume 3 & 6, Sheet 314

#### 1976 Source Sheets



Volume 1, Sheet 68



Volume 1, Sheet 69

#### 1950 Source Sheets



Volume 1, Sheet 68



Volume 1, Sheet 69



Volume 3, Sheet 314



Volume 3, Sheet 316

#### 1931 Source Sheets



Volume 1, Sheet 68



Volume 1, Sheet 69



Volume 3, Sheet 314



Volume 3, Sheet 316

5864605 - 3 page 3



#### Sanborn Sheet Key

This Certified Sanborn Map Report is based upon the following Sanborn Fire Insurance map sheets.



#### 1915 Source Sheets



Volume 1, Sheet 62

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### **ATTACHMENT VII**

### **Historic Topographic Maps**



November 24, 2019 Mr. Jeff Siewert – Ayres Associates 1312 East Columbus Drive Phase I Environmental Assessment OHC Project No. 190239-ES

Columbus Foods 1312 East Columbus Drive Tampa, FL 33605

Inquiry Number: 5864605.4

November 11, 2019

### **EDR Historical Topo Map Report**

with QuadMatch™



6 Armstrong Road, 4th floor Shelton, CT 06484 Toll Free: 800.352.0050 www.edrnet.com



#### **EDR Historical Topo Map Report**

11/11/19

Site Name:

**Client Name:** 

Columbus Foods 1312 East Columbus Drive Tampa, FL 33605 OHC Environmental Engineering 5420 Bay Center Drive Suite 100 Tampa, FL 33609-0000 EDR.

EDR Inquiry # 5864605.4 Contact: Thomas Martinelli

EDR Topographic Map Library has been searched by EDR and maps covering the target property location as provided by OHC Environmental Engineering were identified for the years listed below. EDR's Historical Topo Map Report is designed to assist professionals in evaluating potential liability on a target property resulting from past activities. EDRs Historical Topo Map Report includes a search of a collection of public and private color historical topographic maps, dating back to the late 1800s

Search Results:		Coordinates:	
P.O.#	NA	Latitude:	27.967071 27° 58' 1" North
Project:	1312 East Columbus Drive	Longitude:	-82.44449 -82° 26' 40" West
		UTM Zone:	Zone 17 North
		UTM X Meters:	357922.46
		UTM Y Meters:	3094394.68
		Elevation:	38.00' above sea level
Maps Provid	led:		
2012			
1995			

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5864605 - 4 page



#### Topo Sheet Key

This EDR Topo Map Report is based upon the following USGS topographic map sheets.

#### 2012 Source Sheets



Tampa

7.5-minute, 24000

#### 1995 Source Sheets



Tampa

7.5-minute, 24000 Aerial Photo Revised 1995

#### 1981 Source Sheets



Tampa

7.5-minute, 24000 Aerial Photo Revised 1979

#### 1979 Source Sheets



TAMPA

15-minute, 50000

5864605 - 4 page 3



#### Topo Sheet Key

This EDR Topo Map Report is based upon the following USGS topographic map sheets.

#### 1969 Source Sheets



Tampa

7.5-minute, 24000 Aerial Photo Revised 1969

#### 1956 Source Sheets



Tampa

7.5-minute, 24000 Aerial Photo Revised 1954

#### 1947 Source Sheets



Tampa

7.5-minute, 25000 Aerial Photo Revised 1942

#### 1944 Source Sheets




Tampa


7.5-minute, 31680 Aerial Photo Revised 1942

5864605 - 4 page 4




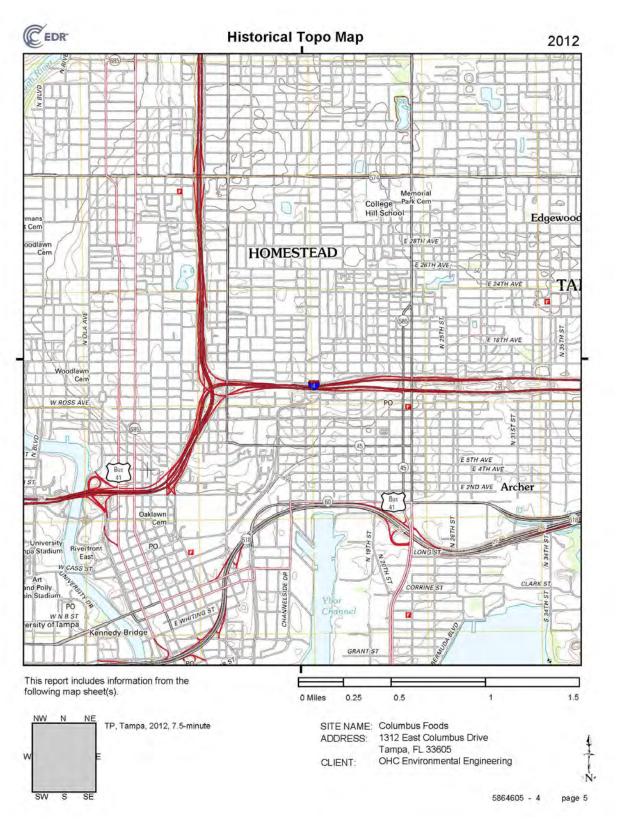




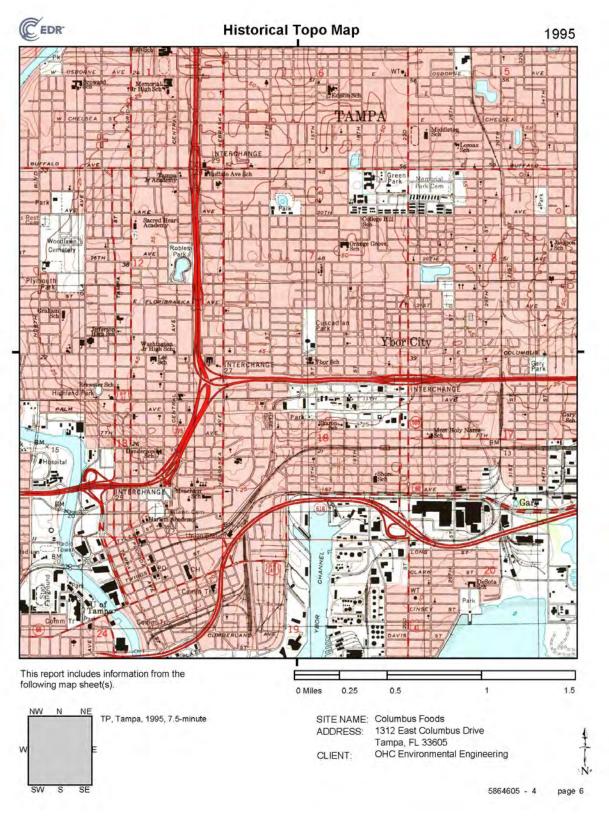




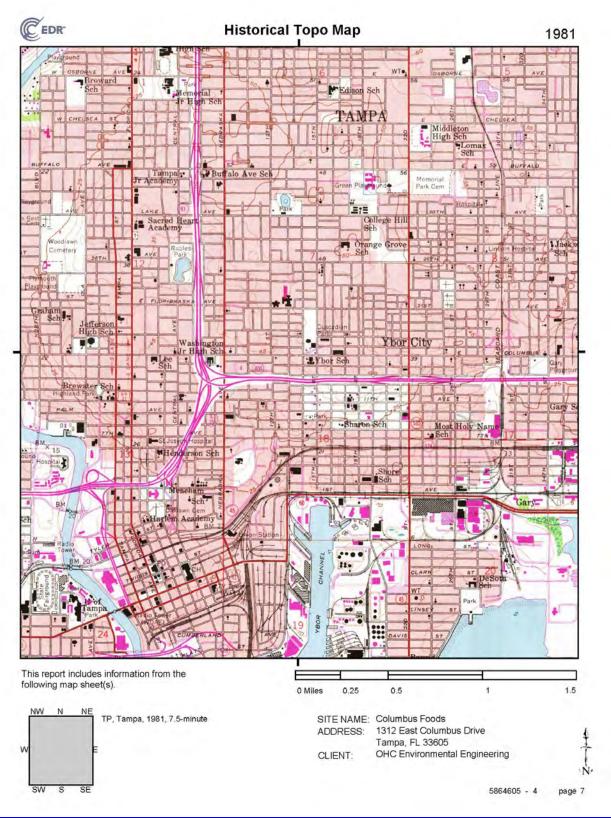




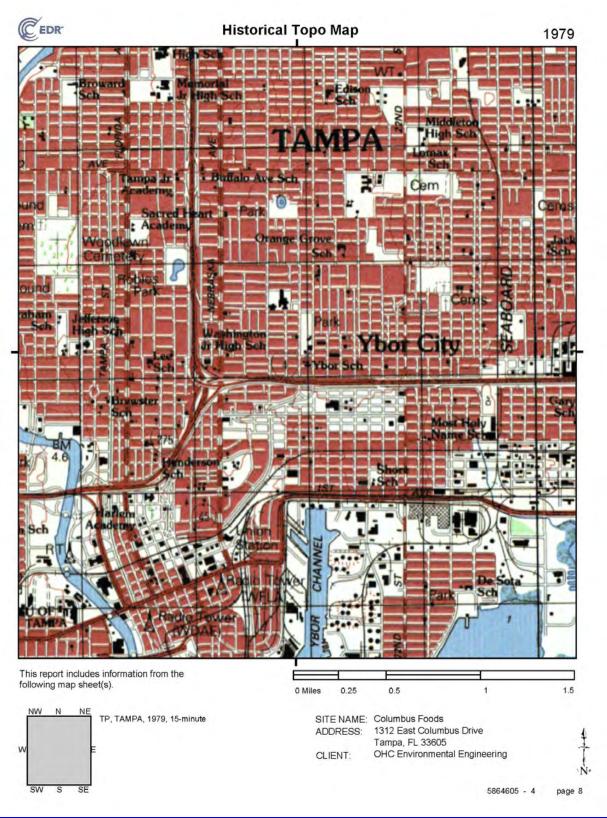




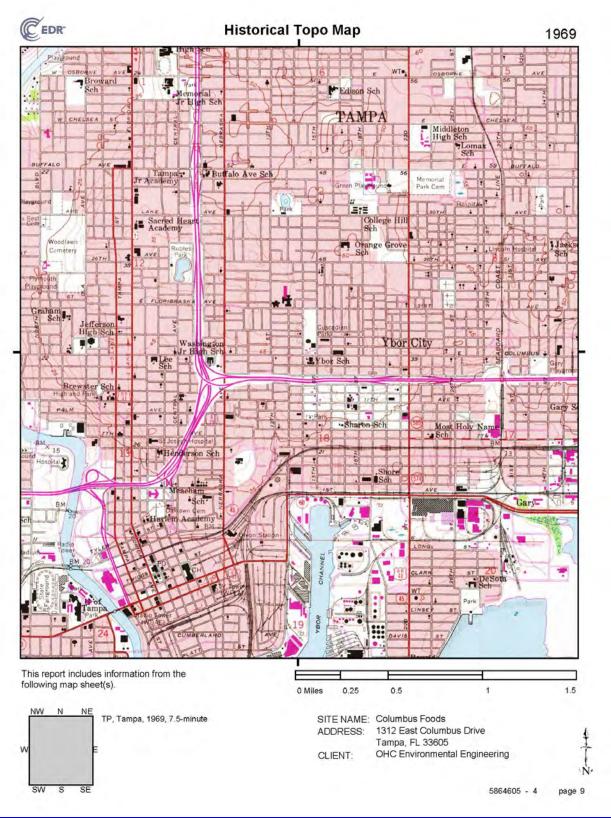




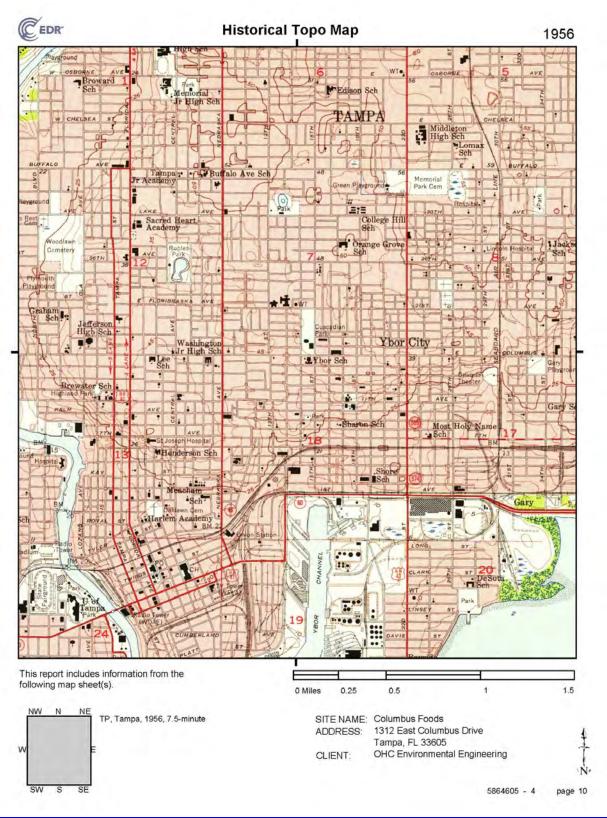



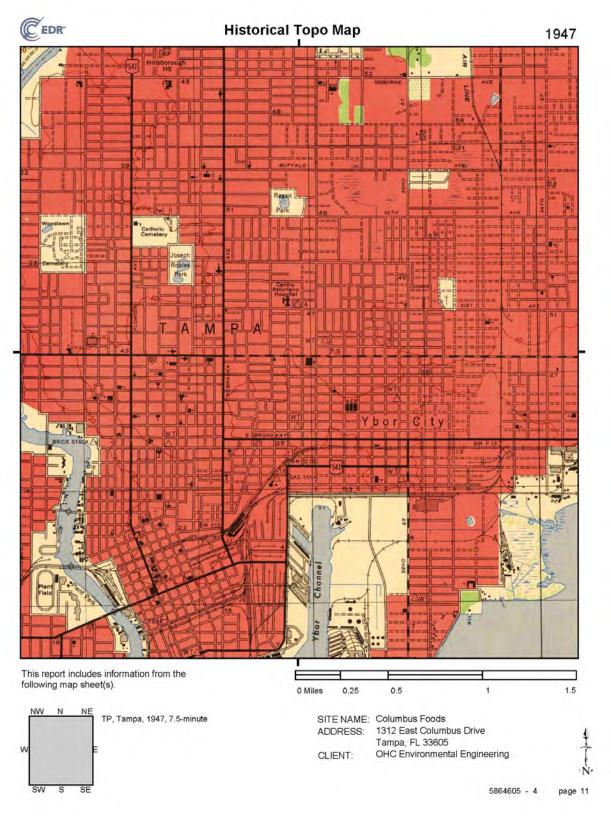



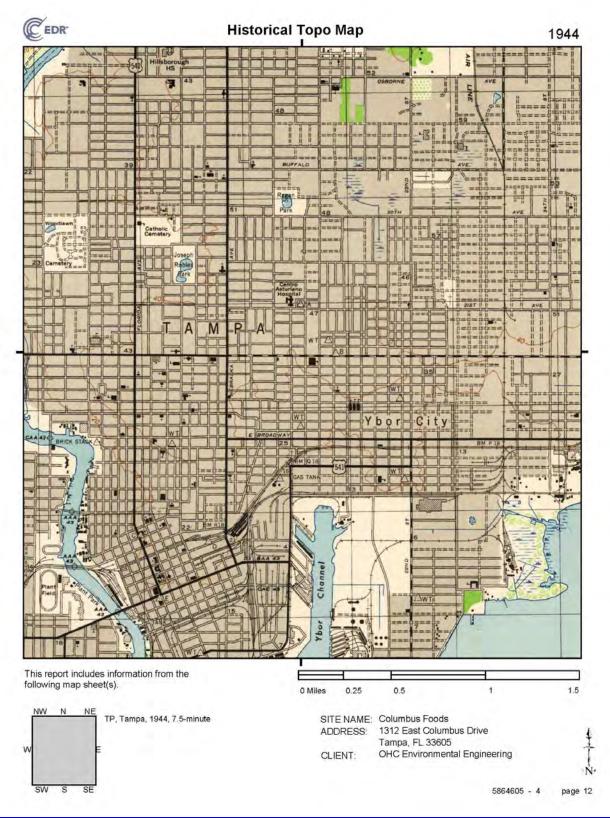



November 24, 2019 Mr. Jeff Siewert – Ayres Associates 1312 East Columbus Drive Phase I Environmental Assessment OHC Project No. 190239-ES

### ATTACHMENT VIII

### **Aerial Photographs**



November 24, 2019 Mr. Jeff Siewert – Ayres Associates 1312 East Columbus Drive Phase I Environmental Assessment OHC Project No. 190239-ES

#### **Columbus Foods**

1312 East Columbus Drive Tampa, FL 33605

Inquiry Number: 5864605.8

November 11, 2019

### The EDR Aerial Photo Decade Package



6 Armstrong Road, 4th floor Shelton, CT 06484 Toll Free: 800.352.0050 www.edrnet.com



#### **EDR Aerial Photo Decade Package**

11/11/19

Site Name:

Client Name:

Columbus Foods

1312 East Columbus Drive Tampa, FL 33605

EDR Inquiry # 5864605.8

OHC Environmental Engineering 5420 Bay Center Drive Suite 100

Tampa, FL 33609-0000 Contact: Thomas Martinelli



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1973	1"=500"	Flight Date: February 17, 1973	FDOT
1965	1"=500'	Flight Date: October 27, 1965	FDOT
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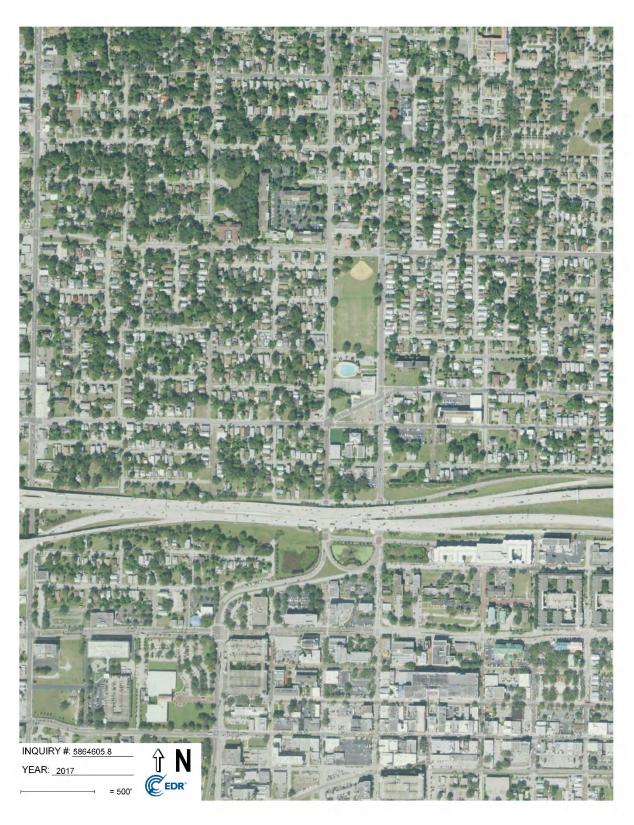
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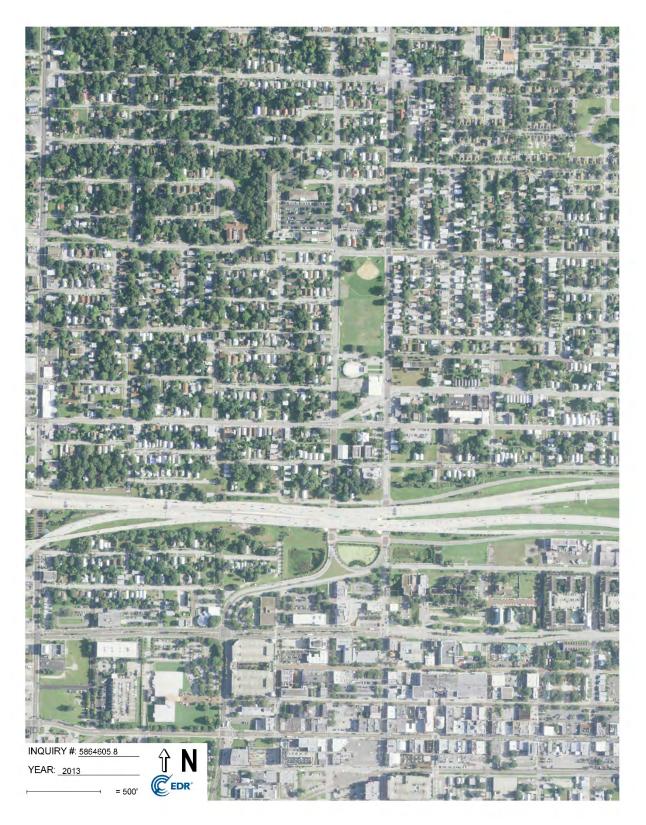
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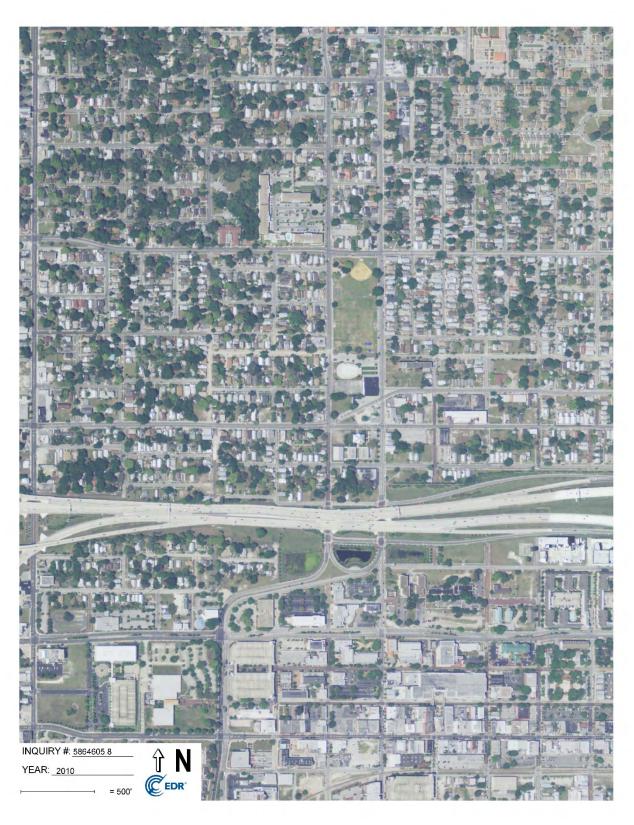















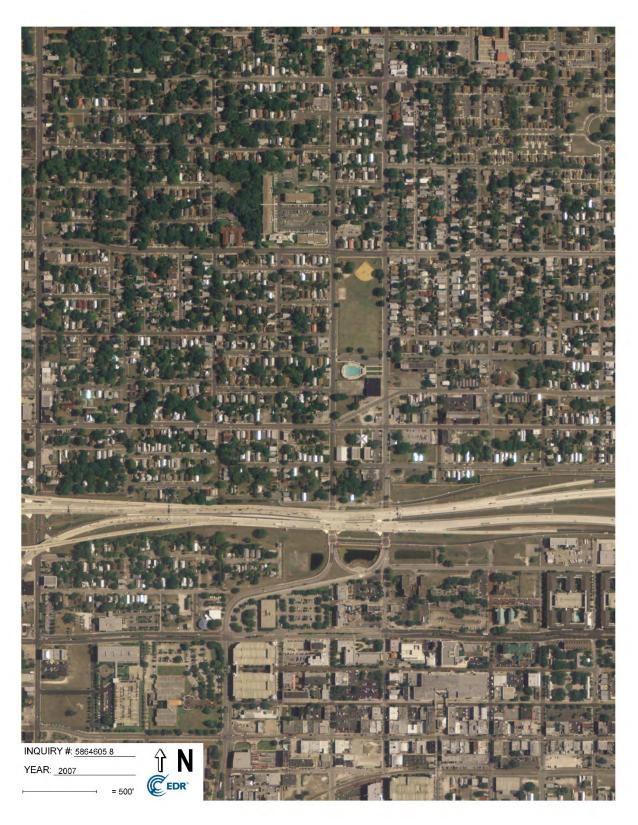
















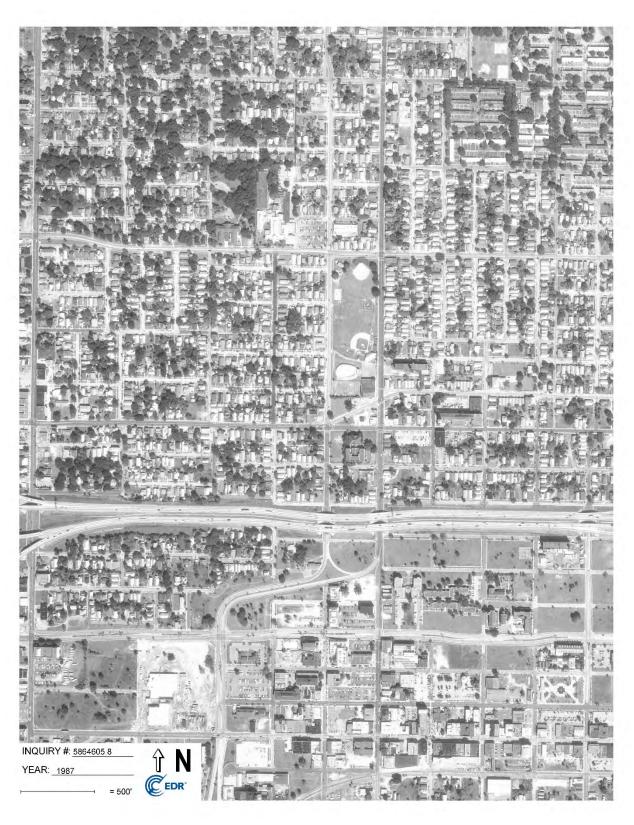

















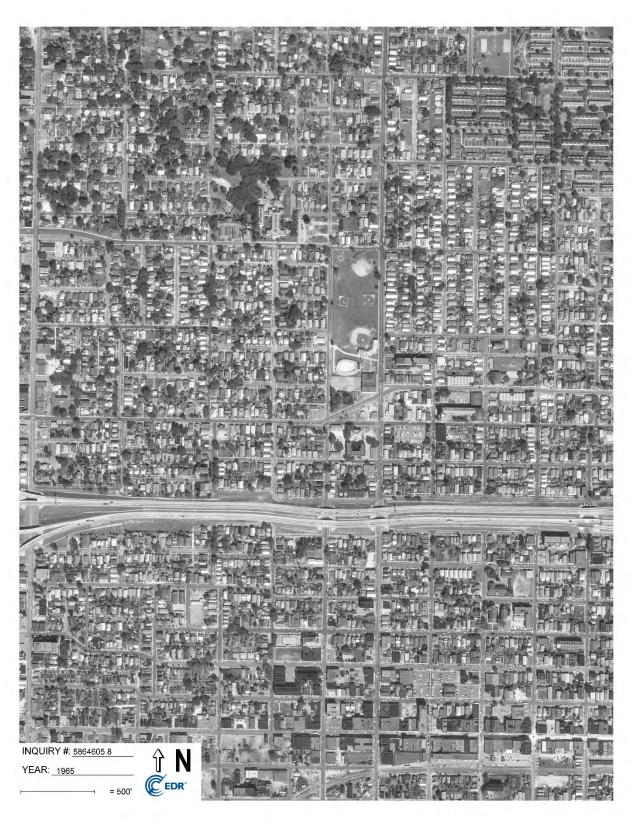




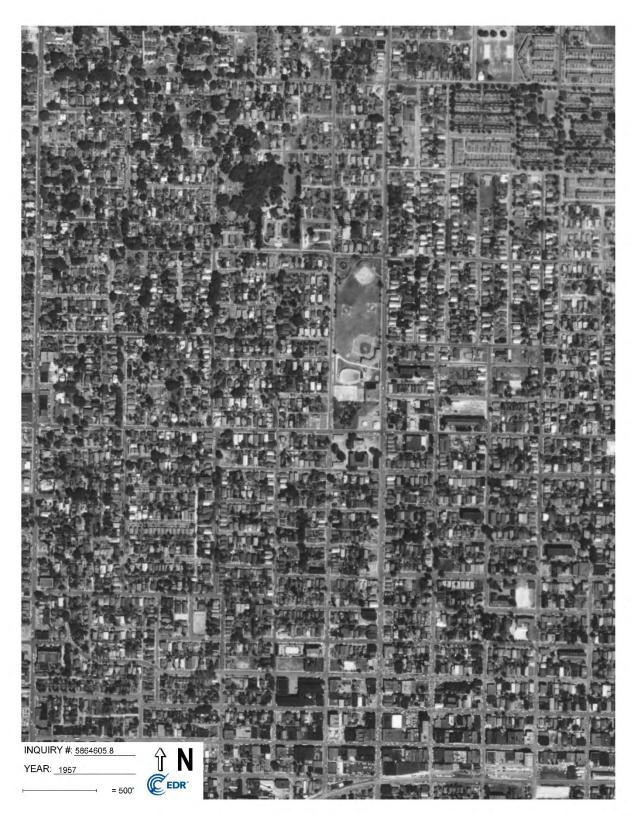







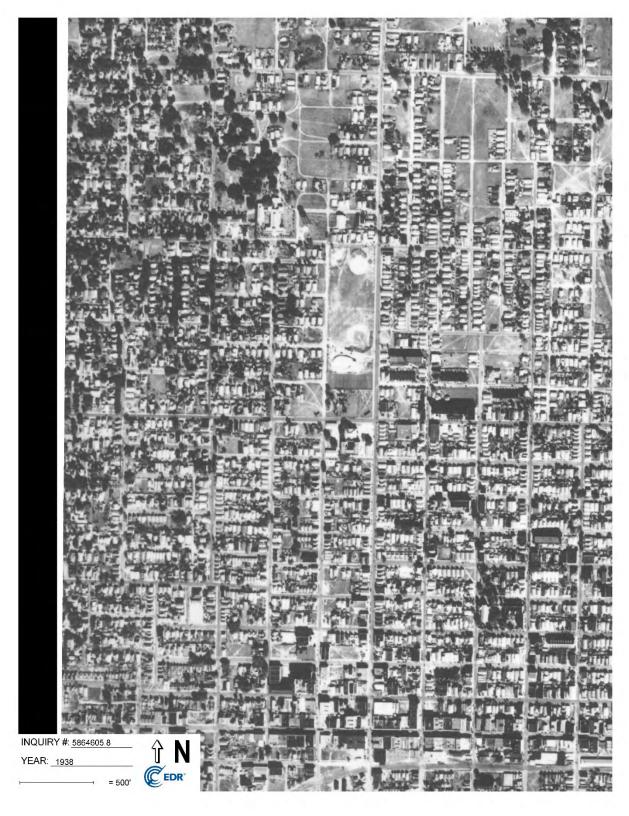



## **ATTACHMENT IX**

## **Consultant Credentials**





organized to improve the practice of industrial hygiene proclaims that

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and has the right to use the designations

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Certificate Number

3956 CP

Awarded:

June 30, 1988

**Expiration Date:** 

December 1, 2020



Chief Executive Officer, ABIH





#### TOM MARTINELLI

Is Awarded 2.1 CEU'S

for successful completion of the course on

Phase I and Phase II Environmental Site Assessments for Commercial Real Estate

October 16-18, 2007

Harrisburg, PA



# Phase I Environmental Assessment Report

Performed at:

Goldstar Foods 2317 North Nebraska Avenue Tampa, FL 33602

**Report Prepared For:** 

Mr. Jeff Siewert, Senior Project Manager Ayres Associates 8875 Hidden River Parkway Tampa, Florida 33637-1035

Report Prepared By:

OHC ENVIRONMENTAL ENGINEERING

OHC Environmental Engineering, Inc. 101 South Hoover Blvd, Suite 101 Tampa, Florida 33609

**OHC Project #190237-ES** 

November 24, 2019

November 17, 2019

Mr. Jeff Siewert Senior Project Manager Ayres Associates 8875 Hidden River Parkway Tampa, FL 33637-1035

> RE: Phase I Environmental Site Assessment Report Goldstar Foods Site 2317 North Nebraska Avenue Tampa, Hillsborough County, FL 33602

Dear Mr. Siewert,

OHC Environmental Engineering, Inc., (OHC), is pleased to submit this Phase I Environmental Site Assessment Report for the above referenced property. The following information summarizes our findings.

#### **Executive Summary**

OHC was retained by Mr. Jeff Siewert, Senior Project Manager of Ayres Associates, and acting project manager for the City of Tampa's future right of way construction, to conduct a Phase I Environmental Assessment of one tax parcel totaling approximately one quarter of an acre. The parcel is located on the corner of East Columbus Drive and North Nebraska Avenue. The tax parcel PIN ID # is A-18-29-19-51D-00000-00001.0. OHC performed the Phase I Environmental Site Assessment of the property operating as Goldstar Foods, Inc. (GFI), herein known as the property, or site. The property is currently an active commercial convenience store and gas station facility which consists of one building encompassing approximately 1,700 square feet. The property is currently owned by O'Henry Foods, Inc.

The purpose of this Phase I Environmental Assessment (ESA) is to assess current site conditions and render an opinion as to the presence of exterior recognized environmental conditions (REC) at the property. The building's interior was not accessible, and therefore not inspected. OHC performed this Phase I in general conformance with the scope and limitations of the ASTM Practice E1527-13 and 40 CFR part 312. The following findings which are potential REC's are listed below, along with supporting opinions and recommendations:



Finding 1) The site address is listed as a leaking underground storage tank (LUST) site, a DWM Contaminated site, a Historic Automobile Service site, a Florida UST site and a Cleanup site in the EDR Radius Map Report. The Florida DEP facility site ID # is 8944840 and the Florida DEP Cleanup Site Key # is 597343428. The site is listed as an open site, therefore it is an active retail site. The site is listed as having an open discharge cleanup status from a discharge reported on 11/30/2010. This means the site has not undergone any cleanup activities. Therefore, this discharge represents a REC. There are monitoring wells located in the concrete slab and sidewalk at the site which may be in the proposed right of way construction. Therefore, these well locations should be properly surveyed for location to determine if they are within the right of way. If so, they should be closed prior to the construction activities to prevent any accidental release of hazardous material contacting the wellhead locations. This closure should be coordinated with the Hillsborough County EPC Case Manager. The proposed construction involves sidewalk and road reconstruction which is expected to impact depths from grade to approximately twenty feet below grade surface (bgs). Static groundwater levels are approximately 23 to 39 feet bgs. Therefore, if any soil or groundwater contamination exists (up to 20 feet below grade) in the vicinity of the ongoing remediation area, it would be expected to impact the proposed construction activities.

Finding 2) The use of PCBs in newly manufactured electrical equipment and oils has been banned since 1979. There is one pole mounted transformer present which may contain PCB containing dielectric fluid. Therefore, this item is a potential REC. However, the pole mounted transformer does not appear to be leaking and is owned by the electric power supplier, TECO (TECO pole # 037342). Therefore, if future leakage would occur, it would be the responsibility of TECO to perform any related cleanup. The transformer does not appear to be within the proposed right of way construction area. Based on these assumptions, this finding does not represent a REC.

Finding 3) At least eight 55-gallon drums of unknown contents were stored to the rear or east side of the convenience store building. No significant leakage or staining was observed on the asphalt surface. These drums represent a REC. These drums should be characterized and properly disposed of by the owner. These drums would not be expected to impact the proposed right of way construction.



November 24, 2019 Mr. Jeff Siewert – Ayres Associates 2317 North Nebraska Avenue Phase I Environmental Assessment OHC Project No. 190237-ES

No other REC's were identified on the exterior of the site. The undersigned declares that he meets the definition of Environmental Professional as stated in 40 CFR part 312 and that he has conducted the assessment in accordance with same. OHC appreciates the opportunity to be of service to you on this project. If you have any further questions, please contact me at your earliest convenience.

Respectfully Submitted, OHC ENVIRONMENTAL ENGINEERING, INC.

Thomas Martinelli

**Environmental Professional** 



## **PHASE I ASSESSMENT**

*OHC PROJECT #:* 190237-ES

**CLIENT NAME:** Mr. Jeff Siewert

**Ayres Associates** 

**PROJECT LOCATION:** Goldstar Foods, Inc.

2317 North Nebraska Avenue

Tampa, FL 33602

*DATE OF SURVEY:* November 12, 2019

**CONSULTING FIRM:** OHC Environmental Engineering, Inc.

101 South Hoover Blvd, Suite101

Tampa, Florida 33609

**ENVIRONMENTAL** 

**PROFESSIONAL:** Thomas Martinelli

OHC PROJECT MANAGER: Christina Jones

**CONSULTANT:** 

James F. Rizk, CIH



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#### **EXECUTIVE SUMMARY**

OHC was retained by Mr. Jeff Siewert, Senior Project Manager of Ayres Associates, and acting project manager for the City of Tampa's future right of way construction to conduct a Phase I Environmental Assessment of one tax parcel totaling approximately one quarter of an acre located on the corner of East Columbus Drive and North Nebraska Avenue. The tax parcel PIN ID # is A-18-29-19-51D-00000-00001.0. OHC performed the Phase I Environmental Site Assessment of the property operating as Goldstar Foods, Inc. (GFI), herein known as the property, or site. The property is currently an active commercial convenience store and gas station facility which consists of one building encompassing approximately 1,700 square feet. The property is currently owned by O'Henry Foods, Inc.

The purpose of this Phase I Environmental Assessment (ESA) is to assess current site conditions and render an opinion as to the presence of exterior recognized environmental conditions (REC) at the property. The building's interior was not accessible, and therefore not inspected. OHC performed this Phase I in general conformance with the scope and limitations of the ASTM Practice E1527-13 and 40 CFR part 312. The following findings which are potential REC's are listed below, along with supporting opinions and recommendations:

Finding 1) The site address is listed as a leaking underground storage tank (LUST) site, a DWM Contaminated site, a Historic Automobile Service site, a Florida UST site and a Cleanup site in the EDR Radius Map Report. The Florida DEP facility site ID # is 8944840 and the Florida DEP Cleanup Site Key # is 597343428. The site is listed as an open site, therefore it is an active retail site. The site is listed as having an open discharge cleanup status from a discharge reported on 11/30/2010. Tis means the site has not undergone any cleanup activities. Therefore, this discharge represents a REC. There are monitoring wells located in the concrete slab and sidewalk at the site which may be in the proposed right of way construction. Therefore, these well locations should be properly surveyed for location to determine if they are within the right of way. If so, they should be closed prior to the construction activities to prevent any accidental release of hazardous material contacting the wellhead locations. This closure should be coordinated with the Hillsborough County EPC Case Manager. The proposed construction involves sidewalk and road reconstruction which is expected to impact depths from grade to approximately twenty feet below grade surface (bgs). Static groundwater levels are approximately 23 to 39 feet bgs. Therefore, if any soil or groundwater contamination



exists (up to 20 feet below grade) in the vicinity of the future remediation area, it may be expected to impact the proposed construction activities.

Finding 2) The use of PCBs in newly manufactured electrical equipment and oils has been banned since 1979. There is one pole mounted transformer present which may contain PCB containing dielectric fluid. Therefore, this item is a potential REC. However, the pole mounted transformer does not appear to be leaking and is owned by the electric power supplier, TECO (TECO pole # 037342). Therefore, if future leakage would occur, it would be the responsibility of TECO to perform any related cleanup. The transformer does not appear to be within the proposed right of way construction area. Based on these assumptions, this finding does not represent a REC.

Finding 3) At least eight 55-gallon drums of unknown contents were stored to the rear or east side of the convenience store building. No significant leakage or staining was observed on the asphalt surface. These drums represent a REC. These drums should be characterized and properly disposed of by the owner. These drums would not be expected to impact the proposed right of way construction.

#### 1.0 INTRODUCTION

OHC Environmental Engineering, Inc. (OHC) was retained by Mr. Jeff Siewert, Senior Project Manager of Ayres Associates, and City of Tampa's construction project manager for the future right of way improvements at the site, ("user"), to prepare a Phase I Environmental Site Assessment of the subject property ("site") in general conformance with ASTM Standard E1527-13 and 40 CFR part 312. This report documents OHC's findings from our Phase I Investigation of the site. The site currently consists of one tax parcel which is zoned Commercial TL Class 7. The site is currently an active commercial convenience store and gas station type facility. The site is located in a primarily commercial/light industrial setting with residential properties nearby.

#### 1.1 Purpose

The purpose of this Phase I Environmental Site Assessment (ESA) is to determine whether there are "recognized environmental conditions" (REC), historical REC's (HREC) or controlled REC's (CREC) on the property, which may have an impact on the future construction along the City of Tampa right of way at the site and liability of the user from a governmental or private party. The purpose of this assessment is to evaluate current exterior environmental conditions. Since the purpose of this assessment is to



evaluate potential subsurface contamination issues present at the right of way construction, access to the interior of the building on site was not granted by the owner. This ESA will therefore document current environmental conditions so either party, user or owner, will be able to establish their impact to the site, if any. Evidence for recognized environmental conditions were sought through environmental and historical records searches, interviews, and a site reconnaissance, etc.

#### 1.2 Project Scope

This ESA is designed to generally conform to the American Society for Testing and Materials (ASTM) Practice E 1527-13, Standard Practice for Environmental Site Assessments: Phase I Environmental Site Assessment Process in terms of levels of inquiry, standard regulatory record search distances and site reconnaissance methodology. The All Appropriate Inquiry document outlined in 40 CFR 312 was also referenced in preparing this report.

The following issues were not evaluated within the scope of this Phase I ESA: 1) regulatory compliance or permitting of facility operations, 2) off-site waste disposal tracking, 3) integrity of on-site sewage disposal systems, 4) geotechnical/structural concerns with underlying soil or fill, 5) wetlands delineation, 6) the potential for naturally-occurring elements or their products that exceed applicable regulatory standards, 7) radon, 8) underground storage tank testing, 9) electromagnetic fields, 10) agricultural practices, 11) the potential for biological hazards and (12) building interior.

Phase I ESA's do not generally include field or laboratory analyses of building materials, air, soil or water samples, which may yield additional information unforeseen in a Phase I ESA. OHC completed this study under the regulatory framework known to be in effect as of the date of this report; and the investigation, findings and conclusions as set forth are predicated upon those laws and regulations.

#### 1.3 Project Limitations

According to ASTM Practice E 1527-13, a Phase I ESA is intended to reduce, not necessarily eliminate, uncertainty regarding the potential environmental conditions in connection with the subject property. The standard states that it recognizes "reasonable limits of time and cost" in this process. Consequently, assessments cannot be judged solely on whether they missed some existing contamination, but instead on "the



reasonableness of the judgments made at the time and under the circumstances in which they were made."

This report is based upon the application of scientific principles and professional judgment to certain facts with resultant subjective interpretations. Professional judgments expressed herein are based on the facts currently available within the limit or scope of work, budget and schedule. The work described in this report was carried out in accordance with the Terms and Conditions in the proposal. An environmental lien and activity use limitation search was not performed or requested by the user.

In preparing this report, OHC may have relied on certain information provided by Environmental Data Resources (EDR), federal, state and local officials and other parties referenced therein, and on information contained in the files of state agencies, local agencies, or both, available to OHC at the time of this site assessment. Although there may have been some degree of overlap in the information provided by these various sources, OHC did not attempt to independently verify the accuracy or completeness of all the information reviewed or received during the course of this site assessment. Observations were made of the site and of the structure exterior, if any, on the site as indicated in this report. While access to portions of the site or to structures on the site was unavailable or limited, OHC renders no opinion as to the presence of indirect evidence relating to petroleum substance, hazardous substances, or both, in that portion of the site and structure. In addition, OHC renders no opinion as to the presence or indirect evidence relating to hazardous material storage or oil, where direct observation of the interior/exterior walls, ground surface, floors, ceiling or a structure is obstructed by objects or vegetation covering on or over these surfaces.

As part of this assessment, OHC has submitted a request for an informal file review with the Hillsborough County Environmental Protection Commission (EPC) and Fire Marshalls offices and the City of Tampa Fire Marshalls office. Information from these inquiries are found in Attachment V.

#### 1.4 Special Terms and Conditions

Terms as defined by ASTM E 1527 are used, as appropriate, in this report. ASTM defines recognized environmental conditions as: "the presence or likely presence of any hazardous substances or petroleum products in, on or at a property (1) due to a release to the environment, (2) under conditions indicative of a release to the environment or (3)



under conditions that pose a material threat of a future release to the environment. The term includes hazardous substances or petroleum products even under conditions in compliance with laws. The term is not intended to include de-minimus conditions that generally do not present a material risk of harm to public health or the environment and that generally would not be the subject of an enforcement action if brought to the attention of appropriate governmental agencies. Conditions determined to be de-minimus are not recognized environmental conditions. Within the context of the ASTM standard, the "site" is the Goldstar Foods property and the "user" of this report is Mr. Jeff Siewert. Representatives from O'Henry's Foods, Inc, owner of the site, declined to complete the User Questionnaire found in Attachment I. OHC would normally rely on information from the questionnaire to assist in determining if REC's were present on site.

#### 2.0 SITE DESCRIPTION

#### 2.1 Location and Legal Description

The subject property, consisting of the aforementioned tax parcel, is described as approximately one quarter of an acre of commercially developed property. The site is located at 2317 North Nebraska Avenue, Ybor City section of the City of Tampa, Hillsborough County, Florida, herein known as the property, or site. The property is currently owned by O'Henry's Foods, Inc. Refer to the tax assessment/site maps in Attachment II and site photographs in Attachment III for visual reference.

#### 2.2 Environmental Setting

The site is located in a mixed light industrial/commercial/residential setting. According to the EDR FEMA Flood Hazard Area Map, the site is not located within a flood plain. According to the EDR provided wetland inventory map, no wetland areas are present. According to the EDR provided information from the 1994 United States Geological Survey, the rock stratigraphic unit at the site is of the Miocene Series of the Tertiary system which was formed in the Cenozoic era. Metamorphic rock formation consists of limestone. Native soil types of the area are primarily Tavares fine sands that are moderate to well drained. The site may consist of urban land. The survey does not identify any depressions or sinkholes on the site. The elevation of the site is approximately 41 feet above mean sea level. The natural topography of the site generally slopes slightly to the south.



#### 2.3 General Site and Vicinity Characteristics

Located within the Ybor City section of the City of Tampa, the surrounding area was initially developed in the early 1880's as primarily industrial or residential in nature.

Commercial, light industrial, recreational and residences are located in the vicinity. Water in the vicinity is provided by municipal sources. The site is serviced by the city sanitary sewer system. Municipal waste disposal in the vicinity is contracted. Electric & telephone are available at the street. The site consists of one rectangular shaped parcel consisting of approximately one quarter of an acre.

The surrounding area was partially developed by at least the early 1850's. By 1895, surrounding properties to the east included residential structures. The immediate surrounding area is currently mixed light industrial, commercial and residential.

#### 2.4 On-site structures/Improvements

The one quarter acre site is approximately 50% used for exterior storage space including sidewalk/road/parking areas, 30% improved with the building and 20% for the gasoline dispensing system with canopy. The improved area consists of one building and the gasoline dispensing system. The building is described as follows:

#### Convenience Store Building

The convenience store building is a one-story structure constructed in 1964 on concrete slab at grade which encompasses approximately 1,700 square feet. The building is rectangular in shape and is of concrete block construction with brick or masonry facade. The roof is a flat built up or of rubber membrane construction. There is a steel/metal canopy covering the gasoline dispensing area.

#### 2.5 Current Site Usage and Adjoining Properties

The site is currently an active commercial convenience store and gasoline station facility. The adjoining property to the south is East 15<sup>th</sup> Avenue. Directly south of 15<sup>th</sup> Avenue is a former gas station facility where monitoring wells are present. Further south are commercial properties and residences. The adjoining property to the north is East Columbus Drive. Further north is are commercial properties and residences. The adjoining properties to east are commercial and residential properties. Further east are residential properties. The adjoining property to the west is a North Nebraska Avenue.



Further west are residences. Surrounding land use is primarily commercial, light industrial or residential.

#### 3.0 RECORDS REVIEW

#### 3.1 Site History & Ownership

Information obtained through the Hillsborough County Tax Assessment search indicates that the most recent deed activity for the site consists of a Deed issued to O'Henry's Foods in May 1987, (Deed Book 5109, page 1229).

#### 3.2 Federal and State Environmental Database Search (EDR)

A search of federal and state records was conducted according to ASTM standards by contracting a commercial database service, EDR, in order to identify any property within a designated proximity to the site that may pose a risk of contamination of the site. Definitions for selected database sites were identified and are described along with each identified site in the following sections. See Attachment IV for definitions and the Executive Summary of the EDR database report.

#### Pertinent Federal ASTM Records

The site was not listed as any type of site as described in the federal database descriptions. The following are designated by the ASTM Standard as search databases with the number of sites identified in the search area:

**NPL** US EPA National Priorities List - 0

CERCLIS/SEMS US EPA Comprehensive Environmental Response,

Compensation and Liability Act Information

System - 1

**RCRA CORRACTS** Facilities Subject to Corrective Action Under the

Resource Conservation and Recovery Act -0

**RCRA non-CORRACTS** Facilities Not Subject to Corrective Action Under

the Resource Conservation and Recovery Act - 0

**RCRA generators** Generators Under the Resources Conservation and

Recovery Act -0

**NRI/ERNS** National Response Incidents – 0



Based on proximity and a cursory drive by, none of the federal mapped or unmapped sites identified in the EDR report would be expected to impact the subject property or the proposed right of way construction. However, any contamination issues present on adjacent sites migrating to the site would be the responsibility of the adjacent site owner to rectify through the applicable regulatory guidelines.

#### Florida Records

No state hazardous waste sites, six solid waste facilities/historic landfill sites, seventeen LUST sites and three Brownfields sites were identified by EDR within a designated proximity to the site according to ASTM standards. The target property is listed as a leaking underground storage tank (LUST) site, a DWM Contaminated site, a Historic Automobile Service site named Ultra Tune Service Station, a Florida UST site and a Cleanup site in the EDR Radius Map Report. The Florida DEP facility site ID # is 8944840 and the Florida DEP Cleanup Site Key # is 59734328. The site is listed as an open site, therefore it is an active retail site. The site is listed as having an incomplete discharge cleanup status from a discharge reported on 11/30/2010. Based on proximity, a cursory drive by and the fact that the EDR reports do not identify non-reported leaking tanks, none of these types of state properties or unmapped properties would be expected to impact the site. Based on the involvement of the Hillsborough County EPC, if subsurface contamination has migrated to the target property, the current owner should have been notified.

#### 3.3 Local and State Environmental Record Search

As part of this assessment, OHC has submitted a request for an informal file review with the Hillsborough County EPC and Fire Marshalls offices and the City of Tampa Fire Marshalls Office. Information obtained from these requests is as follows:

The Hillsborough County EPC office responded back stating that there were no air management, wetlands management or water management files associated with the subject property. The waste management division did locate files including Enforcement Actions, Warning Notices and Tank/Cleanup files which were reviewed on 11/22/19. Information obtained from the file review is as follows:

#### **Enforcement File**



Various Warning Notices of Violations, Consent Orders and general correspondence between the owner and the EPC dating from 1998 through 2016 were reviewed. The violations included but was not limited to leak detection reporting deficiencies, placing product in unregistered tanks, not performing tank tightness testing or tank upgrades. Correspondence included EPC notices to perform site characterization studies and owner claiming inability to perform the studies due to financial hardship. The site is currently in the enforcement stage as no current site characterization study has been performed.

#### Storage Tank File

There were five UST's located on the site at one time. One was removed in 1992 and three were removed in 2010. One remains in service. A gasoline discharge notification dated 11-30-2010 was present. See the site map outlining the tank locations.

#### Cleanup File

The cleanup file contained a storage tank closure assessment which identified the three tanks removed in 2010. As part of the closure, soil samples were collected and groundwater monitoring wells were installed. Groundwater samples were collected. Groundwater was encountered at 23 feet bgs. Soil sample results from this limited preliminary assessment indicate soil contamination above the ECP soil cleanup target levels at 2 to 22 feet bgs. Groundwater sample results from well MW-1 were found to be above the ECP groundwater cleanup target levels (GCTL).

- The City of Tampa and Hillsborough County Fire Marshalls offices were contacted. Hillsborough stated the site was outside of their response jurisdiction. The Tampa request was not completed due to time constraints associated with this report.

File review requests and information is found in Attachment V.

#### 3.4 Other Environmental Record Sources

OHC conducted a review of geological maps, land use and zoning maps at the Hillsborough County Planning Commission office. The site is zoned commercial TL Class 7 and the land use is currently 1422 Convenience Store/Gas Station. The geology is as stated in section 2.2. A City Directory Search was performed which identifies business



entities which have had phone numbers associated with the site address. The listings for 2317 North Nebraska Avenue are as follows:

-	2014	Goldstar Gas
-	2010	God Star, Inc. & RND Brothers, Inc.
-	2004	Goldstar Foods Store
-	1993	Goldstar Foods
-	1988	Citgo Food Mart
-	1983	Ultra Tune Auto Repair
-	1978	V & V Auto Service and Gas Station
-	1974	Thompsons Auto Service & Gas Station
-	1969	Thompsons Sinclair Service Station
-	1955	Leo's Service Station
-	1949	Romeo Auto Filling Station
-	1944	Hermans Service & Filling Station
_	1939	Fox Service & Filling Station

See the pertinent City Directory Search information in Attachment V.

#### 3.5 Sanborn Maps

JMT conducted a Sanborn Fire Insurance Map search through EDR. The search conducted revealed that maps produced for the subject area in 1915, 1931, 1950, 1976 & 1979. The Sanborn search report and maps are found in Attachment VI. The information from the maps is as follows:

The 1915 and 1931 maps reveal the site is not developed. There is commercial, light industrial and residential development in surrounding areas. The 1950 map reveals the site is developed with a gasoline filling station that has three UST's on the north side of the property. The 1976 and 1979 maps reveal a gasoline filling station facility exists.

#### 3.6 Topographic Maps

Historic topographic maps for the years 1944, 1947, 1956, 1969, 1979, 1981, 1995 and 2012 were obtained and reviewed for the subject area. The 1944 through 1995 maps reveal the site is located in a developed urban setting. The maps produced do not show



building structures, only topographic features. No useful data depicting site usage can be derived from the maps searched. The map search data is found in Attachment VII.

#### 3.7 Aerial Photograph Review

Historic aerial photographs for the years 1938, 1950, 1957, 1965, 1973, 1976, 1980, 1987, 1991, 1995, 1998, 2007, 2010, and 2017 were obtained and reviewed of the subject area. The aerials were at varying scales which have varying levels of resolution. The 1938 through 1957 aerials reveal that the site is not developed. Interstate 4 does not exist to the south. Less residential and commercial development as compared to today exists in all directions. The 1965 aerial reveals the site is developed and Interstate 4 exists to the south. The remaining aerials indicate the site is developed and significant residential, commercial and industrial development has taken place in surrounding areas. The 2017 aerial depicts the site as it is today. The photos obtained are found in Attachment VIII.

#### 4.0 SITE RECONNAISSANCE

On November 13, 2019 OHC Environmental Professional, Mr. Thomas Martinelli, performed site reconnaissance at the subject property. Remarkable observations as a result of the reconnaissance are discussed in the following sections of the report.

#### **4.1 General Site Observations**

The site was observed to have the characteristics outlined in Section 2.3 and 2.4. The site was an active office and apartment building at the time of the site reconnaissance. Specific items were observed:

#### 4.1.1 Storage Tanks

Evidence of aboveground or underground storage tanks, (i.e. vent/fill pipes), were observed. Vent and fill pipes were observed that indicate at least one UST exists on the site.

#### 4.1.2 Polychlorinated Biphenyls ("PCBs")

The use of PCBs in newly manufactured electrical equipment and oils has been banned since 1979. Therefore, this type of equipment (pole mounted transformers, fluorescent light ballasts) which were installed at the site near or prior to this date may contain parts which may be filled with PCB-contained dielectric fluid. One pole mounted transformer was present on the exterior of the site. The transformer was not labeled as to PCB content



and appeared to be relatively new; however, no evidence of leaks or spills were observed. According to the pole label (TECO pole # 037342), the transformer is owned by TECO Electric Utilities. As likely owner, TECO would be responsible for any leaks or spills from their transformers.

#### **4.2 Exterior Observations**

Exterior areas of the site include exterior storage, concrete/asphalt parking areas, a dispensing pump island canopy, concrete sidewalks, etc. The roof stormwater is either conveyed directly to the concrete/asphalt surfaces or via sheet flow from the rooftops. A number of groundwater monitoring wells are located on the north, south and west sides of the building. These observation wells are associated with the active gasoline tank leak detection system and the initial subsurface contamination discharge monitoring from former LUST's on the site. Some of these wells are located within 30 to 40 feet from the proposed right of way construction area. At least eight 55-gallon drums of unknown contents were observed behind the building. No significant leakage or stained asphalt was observed in the drum storage area.

#### **Indicators Not Observed**

The following indicators of possible recognized environmental conditions under the ASTM standard were not observed at the site during the external site reconnaissance: stressed vegetation, material storage ponds or lagoons.

#### 4.3 Interior Observations

No access to the building interior was granted for this assessment.

#### **4.4 Non-Scope Observations**

#### 4.4.1 Lead-Based Paint

Lead-based paint was not physically evaluated as part of this ESA. Exterior painted areas were observed to be in good condition.

#### 4.4.2 Asbestos-Containing Material (ACM)

ACM was not physically evaluated as part of this ESA. Exterior suspect asbestos containing materials were observed which included roofing materials, masonry stucco, caulking, etc. All materials were observed to be in fair to good condition.



## 4.4.3 Radon

Radon was not physically evaluated as part of this ESA. Since the site is zoned commercial class 4, radon would not be expected to be considered a concern.

## 5.0 INTERVIEW INFORMATION

Mr. Charles Heintz (Hillsborough County EPC Case Manager), was contacted and he stated that he was the current Case Manager for the site. He stated that the site does have soil and groundwater contamination present. He reported that the site in in the enforcement stage. This means the EPC is pursuing legal action to have the owner characterize and cleanup the site. The owner is claiming financial hardship and does not have the financial means or insurance to perform these tasks. He did not know the vertical or lateral extent of the contamination as no current site characterization study has been performed.

Ms. Jeanette Figari (Hillsborough County EPC), was contacted and stated that she is the point of contact at the EPC to prepare right to know requests. She prepared the request to the air, waste, water and wetland management divisions. She stated that the only requested files of interest were in the waste management division office. A file review was scheduled for 11-22-19.

Ms. Gabrielle Williams, (City of Tampa Emergency Mgt.), stated that there is now a fifteen dollar charge to perform the right to know request. Due to time constraints associated with this project, this request was not performed. She did state that the Hillsborough County Fire Marshalls office be contacted as well.

Ms. Miguelina Rodriguez, (Hillsborough County Fire/Rescue), stated that she researched her files and found that the City of Tampa Fire Marshalls office responds to the site.

## 6.0 FINDINGS, CONCLUSIONS & RECOMMENDATIONS

OHC Environmental Engineering, Inc. has performed a Phase I Environmental Site Assessment in general conformance with the scope and limitations of ASTM Practice E1527-13 and 40 CFR 312 of the Goldstar Foods site located in the Ybor City section of the City of Tampa, Hillsborough County, FL. Any exceptions to or deletions from this practice are described in Section 7.0, Exceptions/Data Gaps section of this report. This



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assessment has revealed evidence of the following potential recognized environmental conditions (REC) in connection with the property:

Finding 1) The site address is listed as a leaking underground storage tank (LUST) site, a DWM Contaminated site, a Historic Automobile Service site, a Florida UST site and a Cleanup site in the EDR Radius Map Report. The Florida DEP facility site ID # is 8944840 and the Florida DEP Cleanup Site Key # is 597343428. The site is listed as a open site, therefore it is an active retail site. The site is listed as having an open discharge cleanup status from a discharge reported on 11/30/2010. This means the site has not undergone any cleanup activities. Therefore, this discharge represents a REC. There are monitoring wells located in the concrete slab and sidewalk at the site which may be in the proposed right of way construction. Therefore, these well locations should be properly surveyed for location to determine if they are within the right of way. If so, they should be closed prior to the construction activities to prevent any accidental release of hazardous material contacting the wellhead locations. This closure should be coordinated with the Hillsborough County EPC Case Manager, Mr. Charles Heintz. The proposed construction involves sidewalk and road reconstruction which is expected to impact depths from grade to approximately twenty feet below grade surface (bgs). Static groundwater levels are approximately 23 to 30 feet bgs. Therefore, if any soil or groundwater contamination exists (up to 20 feet below grade) in the vicinity of the future remediation area, it may be expected to impact the proposed construction activities.

Finding 2) The use of PCBs in newly manufactured electrical equipment and oils has been banned since 1979. There is one pole mounted transformer present which may contain PCB containing dielectric fluid. Therefore, this item is a potential REC. However, the pole mounted transformer does not appear to be leaking and is owned by the electric power supplier, TECO (TECO pole # 037342). Therefore, if future leakage would occur, it would be the responsibility of TECO to perform any related cleanup. The transformer does not appear to be within the proposed right of way construction area. Based on these assumptions, this finding does not represent a REC.

Finding 3) At least eight 55-gallon drums of unknown contents were stored to the rear or east side of the convenience store building. No significant leakage or staining was observed on the asphalt surface. These drums represent a REC. These drums should be



characterized and properly disposed of by the owner. These drums would not be expected to impact the proposed right of way construction.

## 7.0 EXCEPTIONS/DATA GAPS

## **Section Reference 3.1: Explanation**

A complete, thorough 50 year chain of title was not obtained for the site due to the county deed records becoming too complex to trace back. Also, the microfilm viewing machine was not operating properly at the time of the records search. If a thorough chain of title is required, an abstract company should be retained. Also, data gaps are present which determine exact site usage of the site for every year dating back to when the site was undeveloped.

## **Section Reference 4.3: Explanation**

This assessment is limited to exterior observations only as no access was granted to observe interior conditions.

## 8.0 NON-SCOPE ISSUES

## Radon

The EPA has established 4 picocuries per liter ("pCi/L") of radon gas in indoor air as a guidance level for residences. Accumulations above 4 pCi/L are considered to represent a health risk to occupants. Hillsborough County is known to lie within an area that has elevated radon levels. The EDR Report has identified 50% of the structures tested in the basements of Hillsborough County residences are above the guidance level. None of the structures tested within the 33602 zip code area were above the EPA level. Actual radon concentration can only be determined by actual on-site measurement. Radon was not evaluated as part of this EA. The possible presence of naturally occurring radon is a non-scope issue, as it is not included in CERCLA's definition of hazardous substances and does not otherwise present potential CERCLA liability.

## Asbestos

The issue of asbestos is outside the scope of the Phase I ESA standard practice. Effective October 11, 1994, the Occupational Safety and Health Administration ("OSHA") expanded the scope of its general industry standard for asbestos, 29 CFR



1910.1001. The standard requiring asbestos building surveys now applies to virtually all buildings constructed before 1980 and brings OSHA' enforcement power to an issue which was previously regulated by the EPA's National Emission Standards for Hazardous air Pollutants ("NESHAPS"). Since the building on site was constructed around 1964, suspect asbestos materials may be expected to be a business risk. Suspect materials may include but not be limited to drywall ceilings and walls, suspended ceiling tiles, thermal system insulation, roofing materials, etc. If renovation or demolition of the site building is planned, the areas or building involved should be inspected by an accredited building inspector prior to disturbance.

#### Lead Based Paint

Lead-based paint was not evaluated as part of this EA. Since the building on site was reportedly constructed before 1978, lead paint may be expected to be a business issue. The possible presence of lead-containing paint is a non-scope issue, as lead-containing paint is not included in CERCLA's definition of hazardous substances and does not otherwise present potential CERCLA liability. Due to the age of the building on site, suspect lead based paint may be located within the building. Lead based paint inspections relating to human exposure are not required in commercial or industrial settings. However, OSHA regulates lead as it relates to employee exposure if the material is disturbed. The condition of painted surfaces is in fair to good condition.



November 24, 2019 Mr. Jeff Siewert – Ayres Associates 2317 North Nebraska Avenue Phase I Environmental Assessment OHC Project No. 190237-ES

## **ATTACHMENT I**

**User Questionnaire** 





## PHASE I ENVIRONMENTAL ASSESSMENT USER QUESTIONAIRRE

Pu	rchaser:
Pu	rchaser's Telephone No.:
Ov	vner's Name:
O	vner's Telephone No.:
Su	bject Property:
t.	Land use: Is the property or adjoining property currently used for manufacturing or industrial use? Adjoining properties include those that border the immediate site and include properties across the street from the property.  YES NO (If "YES", please describe)
	Subject Property:
	Adjoining property north:
	Adjoining property south:
	Adjoining property east:
	Adjoining property west:
2.	Has the property or adjoining property been used for manufacturing or industrial purposes in the past? YES NO (If "YES", please describe)
	Owner / Use / Date(s) Subject Property Previous use:
	Previous use (north):
	Previous use (south):
	Previous use (east):
	Previous use (west):
3.	Are there any pesticides, automotive or industrial batteries, paints or other chemicals stored on the property of at the facility other than undamaged containers of consumer products under five gallons in total volume?  YES NO (If "YES", please describe)

OHC ENVIRONMENTAL ENGINEERING, INC. 101 SOUTH HOOVER BLVD, SUITE 101 • TAMPA, FLORIDA 33609 PHONE: (813) 626 - 8156 • FAX: (813) 623 - 6702 WEBSITE: WWW.OHCNET.COM

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- Are there any plastic or metal industrial drums (typically 55-gallon) located on the property or at the facility?
   YES NO (If "YES", please describe)
- Has fill dirt been brought onto the site that could be contaminated?
   YES NO (If "YES", please describe)
- 6. Have any construction debris, substances identified as hazardous, unidentified waste materials, tires, automotive or industrial batteries or any other waste materials been dumped above grade, buried and/or burned on the site?

YES NO (If "YES", please describe)

7. Are there any pits, ponds or lagoons located on the property in connection with waste treatment or waste disposal?

YES NO (If "YES", please describe)

Is there any soil on the property that has been obviously stained? YES NO (If "YES", please describe) Are storage tanks above or underground located on the property? YES NO (If "YES", please describe)

10. Are vent pipes protruding from the ground or buildings at the property or adjacent to any structure located on the property?

YES NO (If "YES", please describe)

11. Does the property discharge waste water, other than storm water, directly to a ditch or stream on or adjacent to the property?

YES NO (If "YES", please describe)

- 12. If the property is served by a private well or non-public water system has the well or water system been designated as contaminated by a governmental environmental or health agency? YES NO (If "YES", please describe)
- Asbestos: Does the property or any buildings located on the property contain any asbestos?
   YES NO (If "YES", please describe)
- 14. <u>Polychlorinated biphenyls (PCBs)</u>: Have polychlorinated biphenyls been used in electrical transformers, capacitors or other equipment at the property?

YES NO (If "YES", please describe)

OHC ENVIRONMENTAL ENGINEERING, INC. 101 SOUTH HOOVER BLVD, SUITE 101 • TAMPA, FLORIDA 33609 PHONE: (813) 626 - 8156 • FAX: (813) 623 - 6702 WEBSITE: <u>WWW.OHCNET.COM</u>

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- 15. Is there a transformer that is not owned by a public or private utility or group and for which there are no records indicating the absence of PCBs?
  - YES NO (If "YES", please describe)
- 16. <u>Radon</u>: Has the property or any buildings located on the property been tested for radon? YES NO (If "YES", please describe)
- 17. <u>Urea-Formaldehyde</u>: Does the property or any buildings located on the property contain any urea-formaldehyde materials?
  YES NO (If "YES", please describe)
- 18. <u>Lead</u>: Does the property or any buildings located on the property contain any lead-based paint or lead plumbing?
  YES NO (If "YES", please describe)
- 19. <u>Miscellaneous</u>: Does the owner of the property or operator of the facility have any knowledge of environmental liens, activity/use limitations or governmental notification relating to violations of environmental laws on the property or any facility located on the property? YES NO (If "YES", please describe)
- 20. Has the owner of the property or operator of the facility been informed of the presence of hazardous substances or environmental violations in regards to the property or any facility located on the property? YES NO (If "YES", please describe)
- 21. Are you aware of any environmental assessment of the property that indicated the presence of hazardous substances on the site or recommended further assessment of the property?
  YES NO (If "YES", please describe)
- 22. Are there past, current or pending lawsuits or administrative proceedings for alleged environmental damages involving the property or any owner or tenant of the property? YES NO (If "YES", please describe)
- 23. Does the purchase and/or sales price of this property reflect the presence of hazardous substances on the property?
  YES NO (If "YES", please describe)

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-	ENVIRONMENTAL ENGINEERING
	Land: Have pesticides, herbicides or other agricultural chemicals been stored pplied to the property? YES NO (If "YES", please describe)
This questionnaire	was completed by the property owner (required):
	to Commercial Commerci
Owner's/Seller's Si	ignature:
Owner's/Seller's Si Owner's Printed N	

OHC ENVIRONMENTAL ENGINEERING, INC. 101 SOUTH HOOVER BLVD, SUITE 101 • TAMPA, FLORIDA 33609 PHONE: (813) 626 - 8156 • FAX: (813) 623 - 6702 WEBSITE: WWW.OHCNET.COM

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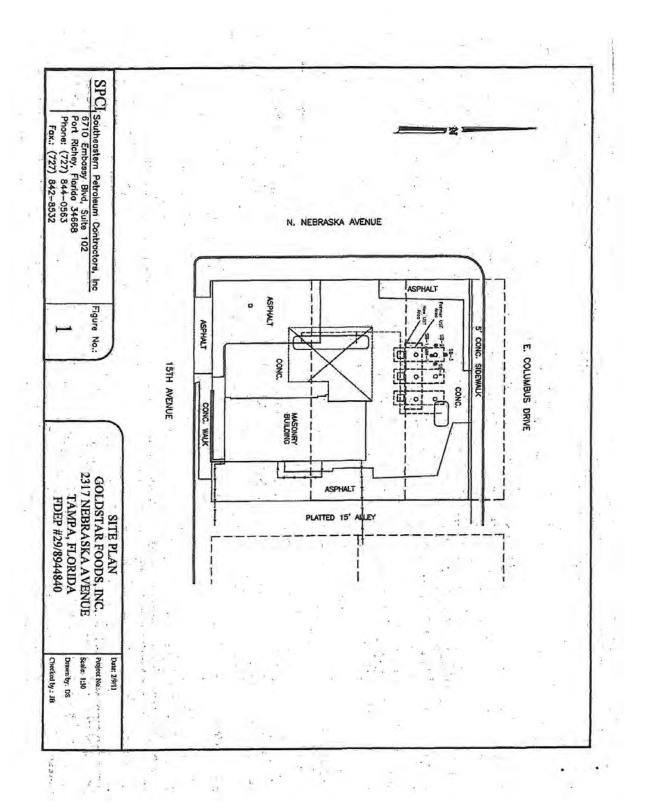


November 24, 2019 Mr. Jeff Siewert – Ayres Associates 2317 North Nebraska Avenue Phase I Environmental Assessment OHC Project No. 190237-ES

## **ATTACHMENT II**

# **Site Maps/Tax Assessment Information**










## Bob Henriquez Hillsborough County Property Appraiser


https://www.hcpafl.org/ 15th Floor County Ctr. 601 E. Kennedy Blvd, Tampa, Florida 33602-4932 Ph: (813) 272-6100

## Folio: 198390-0000

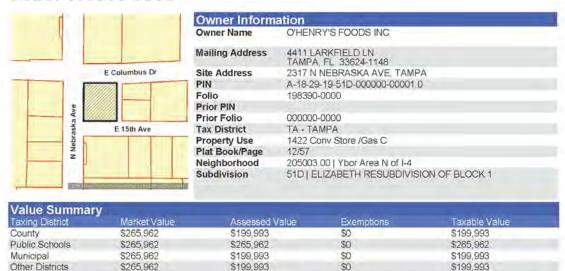


Note: This section shows Market Value, Assessed Value, Exemptions, and Taxable Value for taxing districts. Because of changes in Florida Law, it is possible to have different assessed and taxable values on the same property. For example, the additional \$25,000 Homestead Exemption and the non-homestead CAP do not apply to public schools, and the Low Income Senior Exemption only applies to countywide and certain municipal millages.

Sales In	formation						
Book	Page	Month	Year	Type Inst	Qualified or Unqualified	Vacant or Improved	Price
5109	1229	05	1987	WD	Qualified	Improved	\$150,000
5114	0990	05	1987	WD	Qualified	Improved	\$295,000
4473	0758	12	1984	WD	Qualified	Improved	\$75,000

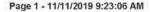



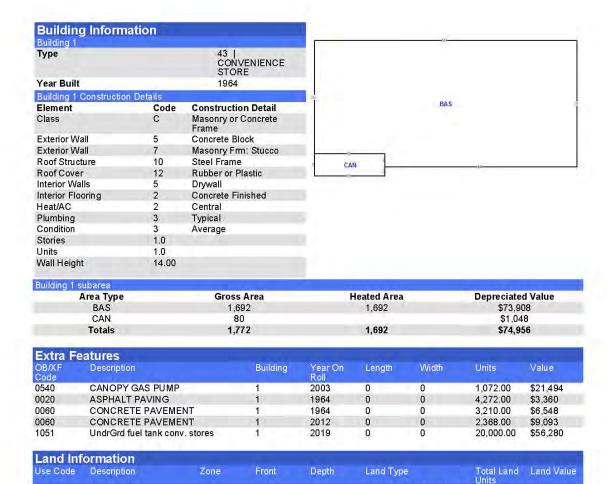

SF | SQUARE FEET

10,355.00

\$94,230

## Legal Description

TL Class 7


TLGK

ELIZABETH RESUBDIVISION OF BLOCK 1 LOTS 1 AND 2 AND LOT 3 LESS N 15 FT FOR RD

109.00

95.00

YC-5

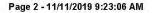




November 24, 2019 Mr. Jeff Siewert – Ayres Associates 2317 North Nebraska Avenue Phase I Environmental Assessment OHC Project No. 190237-ES

# **ATTACHMENT III**


**Site Photographs** 



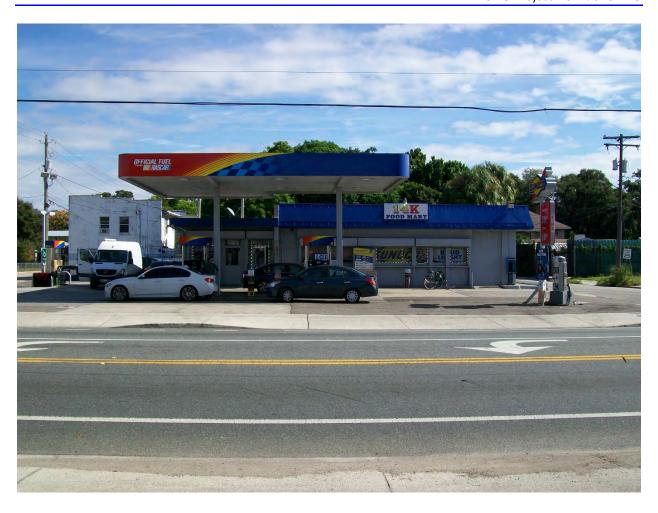

West Side of Building



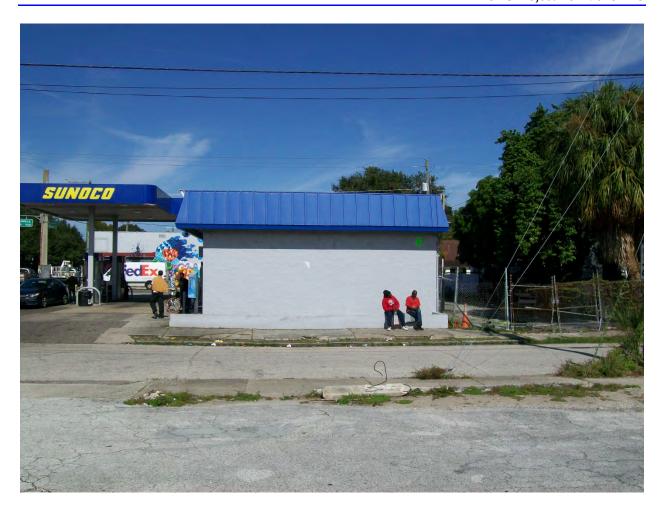


South Side of Building





East Side of Building



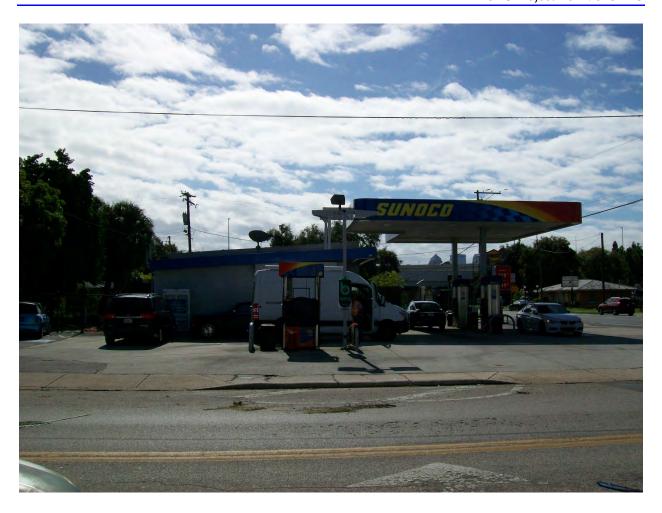


North Side of Building






Monitoring Well



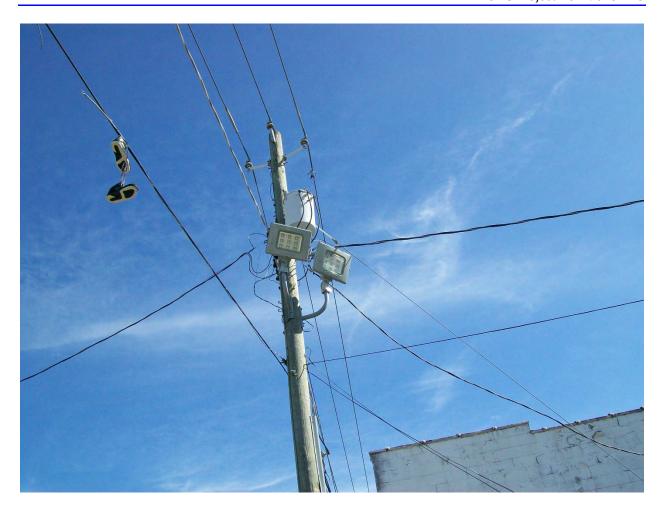

Pole Mounted Transformer



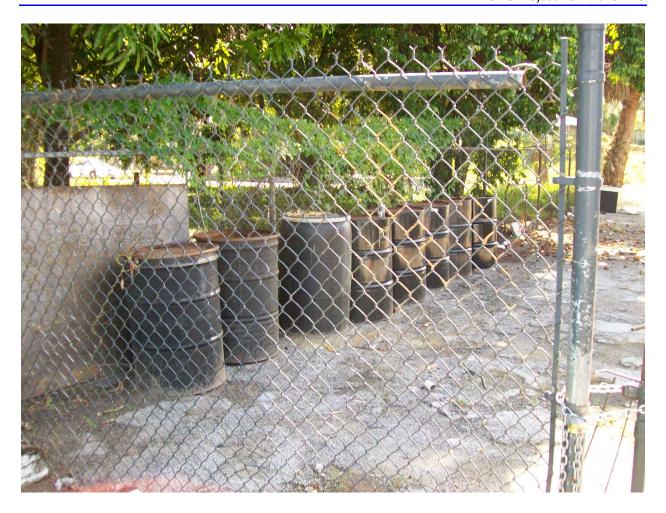

Exterior Drum Storage



## **ATTACHMENT IV**

# **EDR Regulatory Database Report**



November 24, 2019 Mr. Jeff Siewert – Ayres Associates 2317 North Nebraska Avenue Phase I Environmental Assessment OHC Project No. 190237-ES

Goldstar Foods 2317 North Nebraska Avenue Tampa, FL 33602

Inquiry Number: 5864597.2s November 11, 2019

# The EDR Radius Map™ Report with GeoCheck®



6 Armstrong Road, 4th floor Shelton, CT 06484 Toll Free: 800.352.0050 www.edrnet.com

FORM-LBC-DVV



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Thank you for your business.
Please contact EDR at 1-800-352-0050 with any questions or comments.

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TC5864597.2s Page 1



A search of available environmental records was conducted by Environmental Data Resources, Inc (EDR). The report was designed to assist parties seeking to meet the search requirements of EPA's Standards and Practices for All Appropriate Inquiries (40 CFR Part 312), the ASTM Standard Practice for Environmental Site Assessments (E 1527-13), the ASTM Standard Practice for Environmental Site Assessments for Forestland or Rural Property (E 2247-16), the ASTM Standard Practice for Limited Environmental Due Diligence Transaction Screen Process (E 1528-14) or custom requirements developed for the evaluation of environmental risk associated with a parcel of real estate.

#### TARGET PROPERTY INFORMATION

## ADDRESS

2317 NORTH NEBRASKA AVENUE TAMPA FL 33602

#### COORDINATES

27,9666070 = 27° 57' 59.78" 82,4509840 = 82" 27' 3,54" Latitude (North): Longitude (West): 82.45098 Universal Tranverse Mercator: Zone 17

UTM X (Meters) 357280.3 UTM Y (Meters). 3094179.2

Elevation 41 ft. above sea level

## USGS TOPOGRAPHIC MAP ASSOCIATED WITH TARGET PROPERTY

5655712 TAMPA, FL Target Property Map: 2012

Version Date:

## AERIAL PHOTOGRAPHY IN THIS REPORT

Portions of Photo from: 20150510 Source: USDA



## MAPPED SITES SUMMARY

#### Target Property Address: 2317 NORTH NEBRASKA AVENUE TAMPA, FL 33602

## Click on Map ID to see full detail.

MAP	SITE NAME	ADDRESS	DATABASE ACRONYMS	RELATIVE ELEVATION	DIST (ft. & mi.) DIRECTION
A1	GOLDSTAR FOODS	2317 N NEBRASKA AVE	LUST, UST, CLEANUP SITES, DWM CONTAM, Financial	17	TP
42	ULTRA TUNE CL AVANA	2317 NEBRASKA AVE	EDR Hist Auto		TP
43	GOLDSTAR FOODS	2317 N NEBRASKA AVE	RGA LUST		TP
Reg	CENTRO ASTURIANO PLA		BROWNFIELDS	Same	2190, 0.415, NE
44	GENES SERVICE	2318 N NEBRASKA AVE	UST	Higher	140, 0.027, West
A5	GENE S SIXTY SIX SER	2318 NEBRASKA AVE	EDR Hist Auto	Higher	140, 0.027, West
46	JOHNSON J C	2705 NEBRASKA AVE	EDR Hist Cleaner	Higher	151, 0.029, NNW
B7	EASTERN SERVICE STAT	2309 NEBRASKA AV	EDR Hist Auto	Higher	158, 0.030, South
88	COASTAL MART #643	2309 N NEBRASKA AVE	UST	Higher	158, 0.030, South
C9	GORDON J G	2709 NEBRASKA AVE	EDR Hist Cleaner	Higher	189, 0.036, NNW
010	MILLER WM B	2721 NEBRASKA AVE	EDR Hist Auto	Higher	305, 0.058, North
C11	BEST CLEANING SERVIC	2722 NEBRASKA AVE	EDR Hist Cleaner	Higher	317, 0.060, NNW
12	BAY CITY GARAGE	508-14 JACKSON	EDR Hist Auto	Higher	422, 0.080, South
13	TRINITY CAFE	2801 N NEBRAKSA AVE	LUST, UST, Financial Assurance	Higher	435, 0.082, North
14	HILLSBOROUGH CNTY SC	707 E COLUMBUS DR	UST, AST	Higher	473, 0.090, West
15	GLASS FREDK W REAR	914 14TH AVE	EDR Hist Auto	Lower	535, 0.101, SE
16	NEBRASKA CLEANERS	2809 NEBRASKA AVE	EDR Hist Cleaner	Higher	607, 0.115, North
17		2812 N 9TH STREET	DEDB	Higher	634, 0.120, NNE
18	R10 - FOLIO NO. 1868	2813 NORTH 9TH STREE	US BROWNFIELDS, FINDS	Higher	772, 0.146, NNE
9	EAST TAMPA AFFORDABL	906 EAST 19TH AVENUE	US BROWNFIELDS	Higher	871, 0.165, North
20	TAMPA CITY-FIRE DEPT	2904 N MITCHELL AVE	LUST, UST, AST, CLEANUP SITES, DWM CONTAM,	Higher	1228, 0.233, NNW
21	DANNY'S GENERATORS	1023 E COLUMBUS DR	LUST, UST, CLEANUP SITES, DWM CONTAM	Lower	1245, 0.236, East
022	GIGLIO PROPERTY	2007 NEBRASKA AVE	LUST, UST	Higher	1413, 0.268, South
023	TORRES TRANSMISSIONS	2002 N NEBRASKA AVE	LUST, UST	Higher	1496, 0.283, South
24	TRAILER SERVICE INC	1213 17TH AVE	SWF/LF	Higher	1577, 0.299, ENE
25	PEOPLES GAS SYSTEM	1200 NORTH 13TH STRE	VCP, FI Sites, CLEANUP SITES, DWM CONTAM, RESP.,	Lower	1590, 0.301, ESE
26	EAST 23RD BATTERY	903 EAST 23RD AVENUE	SEMS, PRP, ICIS	Higher	1877, 0.355, North
27	EASTELL & CORNELL TH	909 E 23RD AVE	SWF/LF	Higher	1885, 0.357, North
28	CRESCENZO PROPERTY	520 FLORIBRASKA AVE	LUST, UST, Financial Assurance	Higher	1942, 0.368, NNW
29	COLUMBUS FOOD MART	1312 E COLUMBUS DR	LUST, UST, CLEANUP SITES, DWM CONTAM, Financial	Lower	2103, 0.398, East
E30	STAR #1229	1802 N NEBRASKA AVE	LUST, UST, CLEANUP SITES, DWM CONTAM	Lower	2138, 0.405, South
31	VIMAL INVESTMENT LLC	3115 N NEBRASKA AVE	LUST, UST, CLEANUP SITES, DWM CONTAM, Financial	Higher	2163, 0.410, North
32	SILVER DOLLAR TAVERN	411 E PALM	LUST, UST	Lower	2205, 0.418, SW
E33	HILLSBOROUGH COMMUNI	7TH AVE & NEBRASKA A	LUST, UST, CLEANUP SITES, DWM CONTAM	Lower	2218, 0.420, South
34	CHANDRA PATEL	3201 N NEBRASKA AVE	SWF/LF	Higher	2322, 0.440, North
35	TAMPA ELECTRIC CO-TE	1898 NUCCIO PKY	LUST, UST, CLEANUP SITES, DWM CONTAM, Financial	7.10	2348, 0.445, SSE
36	TAMPA CITY-YBOR GRAM	1407 E COLUMBUS AVE	LUST, UST	Lower	2384, 0.452, East
37	BP #429-SHAMIES	901 E 7TH AVE	LUST, UST, CLEANUP SITES, DWM CONTAM, Financial		2384, 0.452, South
38	KWIK STOP	934 E HENDERSON AVE	LUST, UST, CLEANUP SITES, DWM CONTAM, Financial		2386, 0.452, South

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## MAPPED SITES SUMMARY

#### Target Property Address: 2317 NORTH NEBRASKA AVENUE TAMPA, FL 33602

## Click on Map ID to see full detail.

SITE NAME	ADDRESS	DATABASE ACRONYMS	RELATIVE ELEVATION	DIST (ft & ml.) DIRECTION
JOSUE BETANCOURT	1315 HOLMES AVENUE	SWF/LF	Higher	2448, 0,464, ENE
DEEPER LIFE CHRISTIA	3300 N NEBRASKA AVE	SWF/LF	Lower	2500, 0.473, North
CENTRO AUSTURIANO HO	1302 E 21ST AVE	VCP, RESP PARTY	Higher	2545, 0.482, NE
HIGHTOWER PROPERTY	3301 NORTH NEBRASKA	INST CONTROL	Higher	2579, 0.488, North
HIGHTOWER PROPERTY	3301 N NEBRASKA AVE	SWF/LF, LUST, UST, Financial Assurance	Higher	2579, 0.488, North
EAST TAMPA - HIGHTOW	3301 N NEBRASKA AVEN	US BROWNFIELDS, FINDS	Higher	2579, 0,488, North
DEVOE & RAYNOLDS COM	1010-26 NORTH 19TH S	FI Sites	Higher	2857, 0.541, NNE
PEOPLES GAS SYSTEM	1200 NORTH 13TH STRE	EDR MGP	Lower	4037, 0.765, SSE
FORT BROOKE		FUDS	Lower	5171, 0.979, SSE
	JOSUE BETANCOURT DEEPER LIFE CHRISTIA CENTRO AUSTURIANO HO HIGHTOWER PROPERTY HIGHTOWER PROPERTY EAST TAMPA - HIGHTOW DEVOE & RAYNOLDS COM PEOPLES GAS SYSTEM	JOSUE BETANCOURT  DEEPER LIFE CHRISTIA  CENTRO AUSTURIANO HO HIGHTOWER PROPERTY HIGHTOWER PROPERTY EAST TAMPA - HIGHTOW DEVOE & RAYNOLDS COM PEOPLES GAS SYSTEM  1315 HOLMES AVENUE A3301 N NEBRASKA AVE 3301 N NEBRASKA AVE 3301 N NEBRASKA AVEN 1010-26 NORTH 19TH S 1200 NORTH 13TH STRE	JOSUE BETANCOURT  1315 HOLMES AVENUE SWF/LF  DEEPER LIFE CHRISTIA  3300 N NEBRASKA AVE SWF/LF  CENTRO AUSTURIANO HO  1302 E 21ST AVE VCP, RESP PARTY  HIGHTOWER PROPERTY  3301 NORTH NEBRASKA INST CONTROL  HIGHTOWER PROPERTY  3301 N NEBRASKA AVE EAST TAMPA - HIGHTOW  3301 N NEBRASKA AVEN US BROWNFIELDS, FINDS  DEVOE & RAYNOLDS COM  1010-26 NORTH 19TH S  FI Sites  PEOPLES GAS SYSTEM  1200 NORTH 13TH STRE  EDR MGP	SITE NAME         ADDRESS         DATABASE ACRONYMS:         ELEVATION           JOSUE BETANCOURT         1315 HOLMES AVENUE         SWF/LF         Higher           DEEPER LIFE CHRISTIA         3300 N NEBRASKA AVE         SWF/LF         Lower           CENTRO AUSTURIANO HO         1302 E 21ST AVE         VCP, RESP PARTY         Higher           HIGHTOWER PROPERTY         3301 NORTH NEBRASKA         INST CONTROL         Higher           HIGHTOWER PROPERTY         3301 N NEBRASKA AVE         SWF/LF, LUST, UST, Financial Assurance         Higher           EAST TAMPA - HIGHTOW         3301 N NEBRASKA AVEN         US BROWNFIELDS, FINDS         Higher           DEVOE & RAYNOLDS COM         1010-26 NORTH 19TH S         FI Sites         Higher           PEOPLES GAS SYSTEM         1200 NORTH 13TH STRE         EDR MGP         Lower

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## TARGET PROPERTY SEARCH RESULTS

The target property was identified in the following records. For more information on this property see page 8 of the attached EDR Radius Map report

Site	Database(s)	EPA ID
GOLDSTAR FOODS 2317 N NEBRASKA AVE TAMPA, FL 33602	LUST UST Database, UST, Date of Government Version: 05/17/2019 Tank Status: B Tank Status: U Facility-Site Id: 8944840 Facility Status: OPEN	N/A
	CLEANUP SITES DEP Cleanup Site Key. 59734328	
	DWM CONTAM Program Site Id: 8944840	
	Financial Assurance Database; Financial Assurance 3, Date of Government Versi Facility Status. OPEN Facility ID: 8944840	on: 05/02/2019
ULTRA TUNE CL AVANA 2317 NEBRASKA AVE TAMPA, FL	EDR Hist Auto	<b>WA</b>
GOLDSTAR FOODS 2317 N NEBRASKA AVE TAMPA, FL	RGA LUST Facility ID: 8944840	N/A

## DATABASES WITH NO MAPPED SITES

No mapped sites were found in EDR's search of available ("reasonably ascertainable ") government records either on the target property or within the search radius around the target property for the following databases.

## STANDARD ENVIRONMENTAL RECORDS

#### Federal NPL site list

#### Federal Delisted NPL site list

Delisted NPL...... National Priority List Deletions



Federal CERCLIS list

FEDERAL FACILITY...... Federal Facility Site Information listing

Federal CERCLIS NFRAP site list

SEMS-ARCHIVE...... Superfund Enterprise Management System Archive

Federal RCRA CORRACTS facilities list

CORRACTS....... Corrective Action Report

Federal RCRA non-CORRACTS TSD facilities list

RCRA-TSDF...... RCRA - Treatment, Storage and Disposal

Federal RCRA generators list

RCRA-LQG RCRA - Large Quantity Generators RCRA-SQG RCRA - Small Quantity Generators

RCRA-VSQG.......RCRA - Very Small Quantity Generators (Formerly Conditionally Exempt Small Quantity

Generators)

Federal institutional controls / engineering controls registries

Federal ERNS list

ERNS...... Emergency Response Notification System

State- and tribal - equivalent CERCLIS

State and tribal leaking storage tank lists

LAST.....Leaking Aboveground Storage Tank Listing
INDIAN LUST...Leaking Underground Storage Tanks on Indian Land

State and tribal registered storage tank lists

FF TANKS. Federal Facilities Listing
FEMA UST. Underground Storage Tank Listing
INDIAN UST Underground Storage Tanks on Indian Land
TANKS. Storage Tank Facility List

State and tribal institutional control / engineering control registries

ENG CONTROLS..... Institutional Controls Registry

State and tribal voluntary cleanup sites

INDIAN VCP..... Voluntary Cleanup Priority Listing



## ADDITIONAL ENVIRONMENTAL RECORDS

#### Local Lists of Landfill / Solid Waste Disposal Sites

IHS OPEN DUMPS...... Open Dumps on Indian Land

#### Local Lists of Hazardous waste / Contaminated Sites

US HIST CDL..... Delisted National Clandestine Laboratory Register PRIORITYCLEANERS ...... Priority Ranking List US CDL...... National Clandestine Laboratory Register

PFAS.........PFOS and PFOA stand for perfluorooctane sulfonate and perfluorooctanoic acid

#### Local Land Records

LIENS 2..... CERCLA Lien Information

#### Records of Emergency Release Reports

HMIRS...... Hazardous Materials Information Reporting System SPILLS Oil and Hazardous Materials Incidents SPILLS 90. SPILLS 90 data from FirstSearch SPILLS 80...... SPILLS 80 data from FirstSearch

### Other Ascertainable Records

RCRA NonGen / NLR ......... RCRA - Non Generators / No Longer Regulated DOD Department of Defense Sites
SCRD DRYCLEANERS State Coalition for Remediation of Drycleaners Listing 2020 COR ACTION. 2020 Corrective Action Program List
TSCA. Toxic Substances Control Act
TRIS. Toxic Chemical Release Inventory System SSTS....... Section 7 Tracking Systems ...... Risk Management Plans ......Potentially Responsible Parties

PADS...... PCB Activity Database System

ICIS. Integrated Compliance Information System
FTTS. FIRA/ TSCA Tracking System - FIRA (Federal Insecticide, Fungicide, & Rodenticide
Act)/TSCA (Toxic Substances Control Act)

MATS. Material Licensing Tracking System
COAL ASH DOE Steam-Electric Plant Operation Data
COAL ASH EDA

........... Coal Combustion Residues Surface Impoundments List COAL ASH EPA\_

PCB TRANSFORMER...... PCB Transformer Registration Database

RADINFO...... Radiation Information Database

HIST FTTS...... FIFRA/TSCA Tracking System Administrative Case Listing



DOT OPS Incident and Accident Data

FUSRAP......Formerly Utilized Sites Remedial Action Program

LEAD SMELTERS..... Lead Smelter Sites

US AIRS...... Aerometric Information Retrieval System Facility Subsystem

US MINES..... Mines Master Index File

ECHO...... Enforcement & Compliance History Information

AIRS\_\_\_\_\_Permitted Facilities Listing

ASBESTOS. ..... ASBESTOS

DRYCLEANERS..... Drycleaning Facilities

FL Cattle Dip. Vats. Cattle Dipping Vats
SITE INV SITES. Site Investigation Section Sites Listing
TIER 2. Tier 2 Facility Listing
UIC. Underground Injection Wells Database Listing
NEDDES: Machine Facility Regulation Database 

#### EDR RECOVERED GOVERNMENT ARCHIVES

### Exclusive Recovered Govt. Archives

RGA LF...... Recovered Government Archive Solid Waste Facilities List

#### SURROUNDING SITES: SEARCH RESULTS

Surrounding sites were identified in the following databases.

Elevations have been determined from the USGS Digital Elevation Model and should be evaluated on a relative (not an absolute) basis. Relative elevation information between sites of close proximity should be field verified. Site's with an elevation equal to or higher than the target property have been

differentiated below from sites with an elevation lower than the target property.

Page numbers and map identification numbers refer to the EDR Radius Map report where detailed data on individual sites can be reviewed

Sites listed in bold italics are in multiple databases

Unmappable (orphan) sites are not considered in the foregoing analysis.

## STANDARD ENVIRONMENTAL RECORDS

#### Federal CERCLIS list

SEMS: SEMS (Superfund Enterprise Management System) tracks hazardous waste sites, potentially hazardous waste sites, and remedial activities performed in support of EPA's Superfund Program across the United States. The list was formerly know as CERCLIS, renamed to SEMS by the EPA in 2015. The list contains



data on potentially hazardous waste sites that have been reported to the USEPA by states, municipalities, private companies and private persons, pursuant to Section 103 of the Comprehensive Environmental Response, Compensation, and Liability Act (CERCLA). This dataset also contains sites which are either proposed to or on the National Priorities List (NPL) and the sites which are in the screening and assessment phase for possible inclusion on the NPL

A review of the SEMS list, as provided by EDR, and dated 07/19/2019 has revealed that there is 1 SEMS site within approximately 0.5 miles of the target property.

Equal/Higher Elevation	Address	Direction / Distance	Map ID	Page
EAST 23RD BATTERY Site ID: 0409761	903 EAST 23RD AVENUE	N 1/4 - 1/2 (0.355 ml.)	26	63
FPA Id: FI N000409761				

#### State and tribal landfill and/or solid waste disposal site lists

SWF/LF: The Solid Waste Facilities/Landfill Sites records typically contain an inventory of solid waste disposal facilities or landfills in a particular state. The data come from the Department of Environmental Protection's Facility Directory (Solid Waste Facilities).

A review of the SWF/LF list, as provided by EDR, has revealed that there are 6 SWF/LF sites within approximately 0.5 miles of the target property.

Equal/Higher Elevation	Address	Direction / Distance	Map ID	Page
TRAILER SERVICE INC Database: SWF/LF, Date of Govern Facility-Site Id; 96603 Class Status: INACTIVE (I)	1213 17TH AVE nment Version: 07/16/2019	ENE 1/4 - 1/2 (0.299 ml.)	24	60
EASTELL & CORNELL TH Database: SWF/LF, Date of Govern Facility-Site Id: 97087 Class Status: INACTIVE (I)	909 E 23RD AVE nment Version 07/16/2019	N 1/4 - 1/2 (0.357 mi.)	27	65
CHANDRA PATEL Database: SWF/LF, Date of Gover Facility-Site Id: 95720 Class Status: REGISTERED (R)	3201 N NEBRASKA AVE nment Version: 07/16/2019	N 1/4 - 1/2 (0.440 mi.)	34	107
JOSUE BETANCOURT Database: SWF/LF, Date of Govern Facility-Site Id: 103806 Class Status: INACTIVE (I)	1315 HOLMES AVENUE nment Version, 07/16/2019	ENE 1/4 - 1/2 (0.464 mi.)	39	136
HIGHTOWER PROPERTY Database: SWF/LF, Date of Goven Facility-Site Id: 98469 Class Status: INACTIVE (I)	3301 N NEBRASKA AVE nment Version 07/16/2019	N 1/4 - 1/2 (0.488 ml.)	F43	141
Lower Elevation	Address	Direction / Distance	Map ID	Page
DEEPER LIFE CHRISTIA Database: SWF/LF, Date of Govern Facility-Site Id: 96635 Class Status: REGISTERED (R)	3300 N NEBRASKA AVE nment Version: 07/16/2019	N 1/4 - 1/2 (0.473 mi.)	40	137



## State and tribal leaking storage tank lists

LUST: The Leaking Underground Storage Tank Incident Reports contain an inventory of reported leaking underground storage tank incidents. The data come from the Department of Environmental Protection's PCTO1--Petroleum Contamination Detail Report.

A review of the LUST list, as provided by EDR, and dated 07/30/2019 has revealed that there are 16 LUST sites within approximately 0.5 miles of the target property

Equal/Higher Elevation	Address	Direction / Distance	Map ID	Page
TRINITY CAFE	2801 N NEBRAKSA AVE	N 0 - 1/8 (0.082 ml.)	13	23
TAMPA CITY-FIRE DEPT	2904 N MITCHELL AVE	NNW 1/8 - 1/4 (0.233 ml.)	20	35
GIGLIO PROPERTY	2007 NEBRASKA AVE	S 1/4 - 1/2 (0.268 ml.)	D22	50
TORRES TRANSMISSIONS	2002 N NEBRASKA AVE	S 1/4 - 1/2 (0.283 mi.)	D23	55
CRESCENZO PROPERTY	520 FLORIBRASKA AVE	NNW 1/4 - 1/2 (0.368 ml.)	28	66
VIMAL INVESTMENT LLC	3115 N NEBRASKA AVE	N 1/4 - 1/2 (0.410 mi.)	31	88
HIGHTOWER PROPERTY	3301 N NEBRASKA AVE	N 1/4 - 1/2 (0.488 mi.)	F43	141
Lower Elevation	Address	Direction / Distance	Map ID	Page
DANNY'S GENERATORS	1023 E COLUMBUS DR	E 1/8 - 1/4 (0.236 mi.)	21	42
COLUMBUS FOOD MART	1312 E COLUMBUS DR	E 1/4 - 1/2 (0.398 ml.)	29	70
STAR #1229	1802 N NEBRASKA AVE	S 1/4 - 1/2 (0.405 ml.)	E30	83
SILVER DOLLAR TAVERN	411 E PALM	SW 1/4 - 1/2 (0.418 ml.)	32	101
HILLSBOROUGH COMMUNI	7TH AVE & NEBRASKA A	S 1/4 - 1/2 (0.420 mi.)	E33	104
TAMPA ELECTRIC CO-TE	1898 NUCCIO PKY	SSE 1/4 - 1/2 (0.445 mi.)	35	108
TAMPA CITY-YBOR GRAM	1407 E COLUMBUS AVE	E 1/4 - 1/2 (0.452 mi.)	36	121
BP #429-SHAMIES	901 E 7TH AVE	S 1/4 - 1/2 (0.452 mi.)	37	124
KWIK STOP	934 E HENDERSON AVE	S 1/4 - 1/2 (0.452 mi.)	38	130

## State and tribal registered storage tank lists

UST: The Underground Storage Tank database contains registered USTs. Shortly after the September 11 event, the DEP was instructed to remove the detail about some of the storage tank facilities in the state from their reports. Federal-owned facilities and bulk storage facilities are included in that set.

A review of the UST list, as provided by EDR, has revealed that there are 6 UST sites within approximately 0.25 miles of the target property.

Equal/Higher Elevation	Address	Direction / Distance	Map ID	Page
GENES SERVICE Database: UST, Date of Governme Tank Status: A Facility-Site Id: 8625737 Facility Status: CLOSED	231å N NEBRASKA AVE ent Version: 05/17/2019	W 0 - 1/8 (0.027 ml.)	A4	17
COASTAL MART #643 Database: UST, Date of Governme Tank Status: B Facility-Site Id: 8508941 Facility Status: CLOSED	2309 N NEBRASKA AVE ent Version: 05/17/2019	S 0 - 1/8 (0.030 ml.)	88	20
TRINITY CAFE Database: UST, Date of Government	2801 N NEBRAKSA AVE ent Version: 05/17/2019	N 0 - 1/8 (0.082 ml.)	13	23



Tank Status: B Facility-Site Id: 9813324 Facility Status: CLOSED HILLSBOROUGH CNTY SC 707 E COLUMBUS DR W 0 - 1/8 (0.090 ml.) Database: UST, Date of Government Version: 05/17/2019 Tank Status: B Facility-Site Id: 8736992 Facility Status: OPEN TAMPA CITY-FIRE DEPT 2904 N MITCHELL AVE NNW 1/8 - 1/4 (0,233 mi.) 20 Database: UST, Date of Government Version: 05/17/2019 Tank Status: B Facility-Site Id: 8842212 Facility Status: GLOSED Lower Elevation Address Direction / Distance Map ID Page DANNY'S GENERATORS 1023 E COLUMBUS DR E 1/8 - 1/4 (0.236 mi.) 42 Database: UST, Date of Government Version: 05/17/2019 Tank Status: B Facility-Site Id: 8508982 Facility Status: CLOSED

AST: Shortly after the Sept 11 event, the DEP was instructed to remove the detail about some of the storage tank facilities in the state from their reports. Federal-owned facilities and bulk storage facilities are included in that set.

A review of the AST list, as provided by EDR, has revealed that there are 2 AST sites within approximately 0.25 miles of the target property.

Equal/Higher Elevation	Address	Direction / Distance	Map ID	Page
HILLSBOROUGH CNTY SC Database: AST, Date of Governme Facility Status; OPEN Facility-Site Id: 8736992 Facility Status: OPEN	707 E COLUMBUS DR int Version: 05/17/2019	W 0 - 1/8 (0.090 mi.)	14	27
TAMPA CITY-FIRE DEPT Database: AST, Date of Governme Facility Status: CLOSED Facility-Site Id: 8842212 Facility Status: CLOSED	2904 N MITCHELL AVE int Version: 05/17/2019	NNVY 1/8 - 1/4 (0.233 ml.)	20	35

#### State and tribal institutional control / engineering control registries

INST CONTROL: The registry is a database of all contaminated sites in the state of Florida which are subject to institutional and engineering controls.

A review of the INST CONTROL list, as provided by EDR, and dated 06/28/2019 has revealed that there is 1 INST CONTROL site within approximately 0.5 miles of the target property.



Equal/Higher Elevation	Address	Direction / Distance	Map ID	Page
HIGHTOWER PROPERTY Facility-Site Id: ERIC 6582	3301 NORTH NEBRASKA	N 1/4 - 1/2 (0.488 ml.)	F42	138
Equility Site Id: 9812414				

#### State and tribal voluntary cleanup sites

VCP: The Florida Voluntary Cleanup Program database.

A review of the VCP list, as provided by EDR, and dated 06/28/2019 has revealed that there are 2 VCP sites within approximately 0.5 miles of the target property.

Equal/Higher Elevation	Address	Direction / Distance	Map ID	Page
CENTRO AUSTURIANO HO Status: CLOSED Comet-Site Id: 268895	1302 E 21ST AVE	NE 1/4 - 1/2 (0.482 mi.)	41	137
Lower Elevation	Address	Direction / Distance	Map ID	Page
PEOPLES GAS SYSTEM Status: OPEN Comet Site Id: 65122	1200 NORTH 13TH STRE	ESE 1/4 - 1/2 (0.301 ml.)	25	60

### State and tribal Brownfields sites

BROWNFIELDS: Brownfields are defined by the Florida Department of Environmental Protection (FDEP) as abandoned, idled, or underused industrial and commercial facilities where expansion or redevelopment is complicated by real or perceived environmental contamination.

A review of the BROWNFIELDS list, as provided by EDR, has revealed that there is 1 BROWNFIELDS site within approximately 0.5 miles of the target property.

Equal/Higher Elevation	Address	Direction / Distance	Map ID	Page
CENTRO ASTURIANO PLA		NE 1/4 - 1/2 (0.415 ml.)	0	17
Database: BROWNFIELDS AREAS	Date of Government Version	05/06/2019		

### ADDITIONAL ENVIRONMENTAL RECORDS

#### Local Brownfield lists

US BROWNFIELDS. The EPA's listing of Brownfields properties from the Cleanups in My Community program, which provides information on Brownfields properties for which information is reported back to EPA, as well as areas served by Brownfields grant programs.

A review of the US BROWNFIELDS list, as provided by EDR, and dated 06/03/2019 has revealed that there



are 3 US BROWNFIELDS sites within approximately 0.5 miles of the target property.

Equal/Higher Elevation	Address	Direction / Distance	Map ID	Page
R10 - FOLIO NO. 1868 ACRES property ID: 106261	2813 NORTH 9TH STREE	NNE 1/8 = 1/4 (0.146 ml.)	18	29
EAST TAMPA AFFORDABL ACRES property ID: 60011	906 EAST 19TH AVENUE	N 1/8 + 1/4 (0.165 mi.)	19	32
ACRES property ID: 111450	3301 N NEBRASKA AVEN	N 1/4 - 1/2 (0.488 ml.)	F44	146

#### Local Lists of Hazardous waste / Contaminated Sites

FI Sites: This summary status report is a compilation and revision of other existing lists. It was developed from a number of lists including the Eckhardt list, the Moffit list, the EPA Hazardous Waste Sites list, EPA's Emergency and Remedial Response Information System list (RCRA Section 3012), and existing department lists such as the Obsolete Uncontrolled Hazardous Waste Sites list. The purpose of this list is to track the progress of activities within and outside the department as they relate to the listed sites. It is not a list of uncontrolled sites or sources causing environmental contamination. The Sites List comes from the Department of Environmental Protection.

A review of the FI Sites list, as provided by EDR, and dated 12/31/1989 has revealed that there are 2 FI Sites sites within approximately 1 mile of the target property

Equal/Higher Elevation	Address	Direction / Distance	Map ID	Page
DEVOE & RAYNOLDS COM EPA ID: FLD130010176 Facility-Site Id: 000451	1010-26 NORTH 19TH S	NNE 1/2 - 1 (0.541 mi.)	45	152
Lower Elevation	Address	Direction / Distance	Map ID	Page
PEOPLES GAS SYSTEM Facility-Site Id: 000480	1200 NORTH 13TH STRE	ESE 1/4 - 1/2 (0.301 ml.)	25	60

#### Other Ascertainable Records

FUDS: The Listing includes locations of Formerly Used Defense Sites Properties where the US Army Corps Of Engineers is actively working or will take necessary cleanup actions.

A review of the FUDS list, as provided by EDR, and dated 05/15/2019 has revealed that there is 1 FUDS site within approximately 1 mile of the target property.

Lower Elevation	Address	Direction / Distance	Map ID	Page
FORT BROOKE		SSE 1/2 - 1 (0.979 ml.)	47	153



## **EXECUTIVE SUMMARY**

DEDB: Ethylene dibromide (EDB), a soil furnigant, that has been detected in drinking water wells. The amount found exceeds the maximum contaminant level as stated in Chapter 62-550 or 520. It is a potential threat to public health when present in drinking water.

A review of the DEDB list, as provided by EDR, and dated 06/18/2019 has revealed that there is 1 DEDB site within approximately 0.25 miles of the target property.

Equal/Higher Elevation	Address	Direction / Distance	Map ID	Page
Not reported	2812 N 9TH STREET	NNE 0 - 1/8 (0.120 mi.)	17	28

DWM CONTAM: A listing of active or known sites. The listing includes sites that need cleanup but are not actively being working on because the agency currently does not have funding (primarily petroleum and drycleaning).

A review of the DWM CONTAM list, as provided by EDR, and dated 01/28/2019 has revealed that there are 10 DWM CONTAM sites within approximately 0.5 miles of the target property.

Equal/Higher Elevation	Address	Direction / Distance	Map ID	Page	
TAMPA CITY-FIRE DEPT Program Site Id: 8842212	2904 N MITCHELL AVE	NNW 1/8 - 1/4 (0.233 ml.)	20	35	
VIMAL INVESTMENT LLC Program Site Id: 8625232	3115 N NEBRASKA AVE	N 1/4 - 1/2 (0.410 mi.)	31	88	
Lower Elevation	Address	Direction / Distance	Map ID	Page	
DANNY'S GENERATORS Program Site Id: 8508982	1023 E COLUMBUS DR	E 1/8 - 1/4 (0.236 mi.)	21	42	
PEOPLES GAS SYSTEM Program Site Id: 65122	1200 NORTH 13TH STRE	ESE 1/4 - 1/2 (0.301 ml.)	25	60	
COLUMBUS FOOD MART Program Site Id: 8624765	1312 E COLUMBUS DR	E 1/4 - 1/2 (0.398 mi.)	29	70	
STAR #1229 Program Site Id: 8625656	1802 N NEBRASKA AVE	S 1/4 - 1/2 (0.405 ml.)	E30	83	
HILLSBOROUGH COMMUNI Program Site Id: 9802434	7TH AVE & NEBRASKA A	S 1/4 - 1/2 (0.420 mi.)	E33	104	
TAMPA ELECTRIC CO-TE Program Site Id; 8839853	1898 NUCCIO PKY	SSE 1/4 - 1/2 (0.445 ml.)	35	108	
BP #429-SHAMIES Program Site Id: 8624761	901 E 7TH AVE	S 1/4 - 1/2 (0.452 mi.)	37	124	
KWIK STOP Program Site Id: 8625526	934 E HENDERSON AVE	\$ 1/4 - 1/2 (0.452 mi.)	38	130	

RESP PARTY Open, inactive and closed responsible party sites

A review of the RESP PARTY list, as provided by EDR, and dated 06/30/2019 has revealed that there are 2 RESP PARTY sites within approximately 0.5 miles of the target property.

Equal/Higher Elevation	Address	Direction / Distance	Map ID	Page
CENTRO AUSTURIANO HO	1302 E 21ST AVE	NE 1/4 - 1/2 (0.482 mi.)	41	137



## **EXECUTIVE SUMMARY**

Site Status: CLOSED

Lower Elevation	Address	Direction / Distance	Map ID	Page
PEOPLES GAS SYSTEM	1200 NORTH 13TH STRE	ESE 1/4 - 1/2 (0.301 ml.)	25	60
Site Status: ODEM				

#### EDR HIGH RISK HISTORICAL RECORDS

#### EDR Exclusive Records

EDR MGP. The EDR Proprietary Manufactured Gas Plant Database includes records of coal gas plants (manufactured gas plants) compiled by EDR's researchers. Manufactured gas sites were used in the United States from the 1800's to 1950's to produce a gas that could be distributed and used as fuel. These plants used whale oil, rosin, coal, or a mixture of coal, oil, and water that also produced a significant amount of waste. Many of the byproducts of the gas production, such as coal tar (oily waste containing volatile and non-volatile chemicals), sludges, oils and other compounds are potentially hazardous to human health and the environment. The byproduct from this process was frequently disposed of directly at the plant site and can remain or spread slowly, serving as a continuous source of soil and groundwater contamination.

A review of the EDR MGP list, as provided by EDR, has revealed that there is 1 EDR MGP site within approximately 1 mile of the target property.

Lower Elevation	Address	Direction / Distance	Map ID	Page
PEOPLES GAS SYSTEM	1200 NORTH 13TH STRE	SSE 1/2 - 1 (0.765 mi.)	46	152

EDR Hist Auto: EDR has searched selected national collections of business directories and has collected listings of potential gas station/filling station/service station sites that were available to EDR researchers. EDR's review was limited to those categories of sources that might, in EDR's opinion, include gas station/filling station/service station establishments. The categories reviewed included, but were not limited to gas, gas station, gasoline station, filling station, auto, automobile repair, auto service station, service station, etc. This database falls within a category of information EDR classifies as "High Risk Historical Records", or HRHR. EDR's HRHR effort presents unique and sometimes proprietary data about past sites and operations that typically create environmental concerns, but may not show up in current government records searches.

A review of the EDR Hist Auto list, as provided by EDR, has revealed that there are 5 EDR Hist Auto sites within approximately 0.125 miles of the target property.

Equal/Higher Elevation	Address	Direction / Distance	Map ID	Page
GENE S SIXTY SIX SER	2318 NEBRASKA AVE	W 0 - 1/8 (0.027 mi.)	A5	18
EASTERN SERVICE STAT	2309 NEBRASKA AV	S 0 - 1/8 (0,030 mi.)	B7	20
MILLER WM B	2721 NEBRASKA AVE	N 0 - 1/8 (0.058 mi.)	C10	22
BAY CITY GARAGE	508-14 JACKSON	S 0 - 1/8 (0.080 mi.)	12	22
Lower Elevation	Address	Direction / Distance	Map ID	Page
GLASS FREDK W REAR	914 14TH AVE	SE 0 - 1/8 (0.101 mi.)	15	28



## **EXECUTIVE SUMMARY**

EDR Hist Cleaner: EDR has searched selected national collections of business directories and has collected listings of potential dry cleaner sites that were available to EDR researchers. EDR's review was limited to those categories of sources that might, in EDR's opinion, include dry cleaning establishments. The categories reviewed included, but were not limited to dry cleaners, cleaners, laundry, laundromat, cleaning/laundry, wash & dry etc. This database falls within a category of information EDR classifies as "High Risk Historical Records", or HRHR. EDR's HRHR effort presents unique and sometimes proprietary data about past sites and operations that typically create environmental concerns, but may not show up in current government records searches.

A review of the EDR Hist Cleaner list, as provided by EDR, has revealed that there are 4 EDR Hist Cleaner sites within approximately 0.125 miles of the target property.

Equal/Higher Elevation	Ad	dress	Direction / Distance	Map ID	Page
JOHNSON J C	2705	NEBRASKA AVE	NNW 0 - 1/8 (0.029 ml.)	A6	19
GORDON J G	2709	NEBRASKA AVE	NNW 0 - 1/8 (0.036 mi.)	C9	22
BEST CLEANING SERVIC	2722	NEBRASKA AVE	NNW 0 - 1/8 (0.060 mi.)	C11	22
NEBRASKA CLEANERS	2809	NEBRASKA AVE	N 0 - 1/8 (0.115 mi.)	16	28



## **EXECUTIVE SUMMARY**

Due to poor or inadequate address information, the following sites were not mapped. Count: 1 records.


Site Name

Database(s)


HECTOR ALONSO

SWE/LF



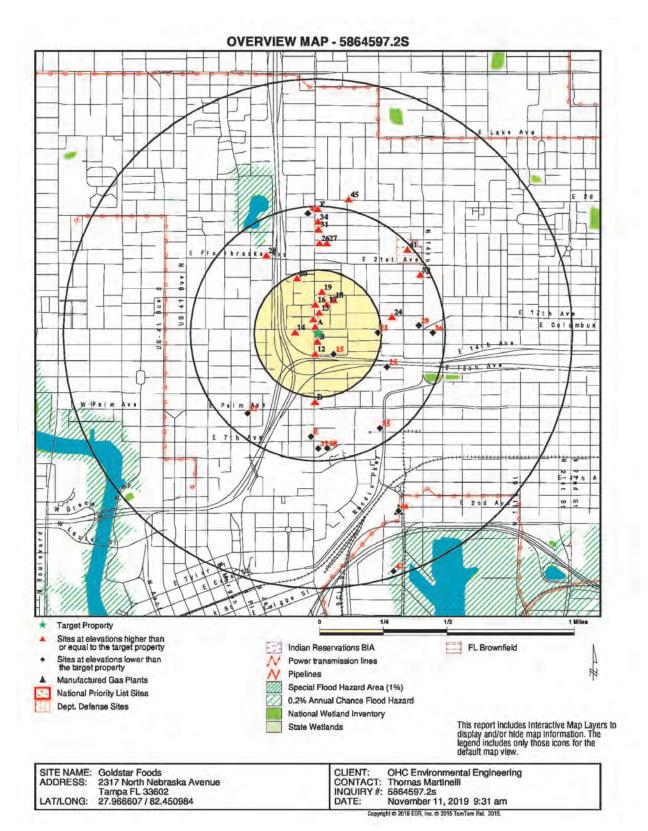



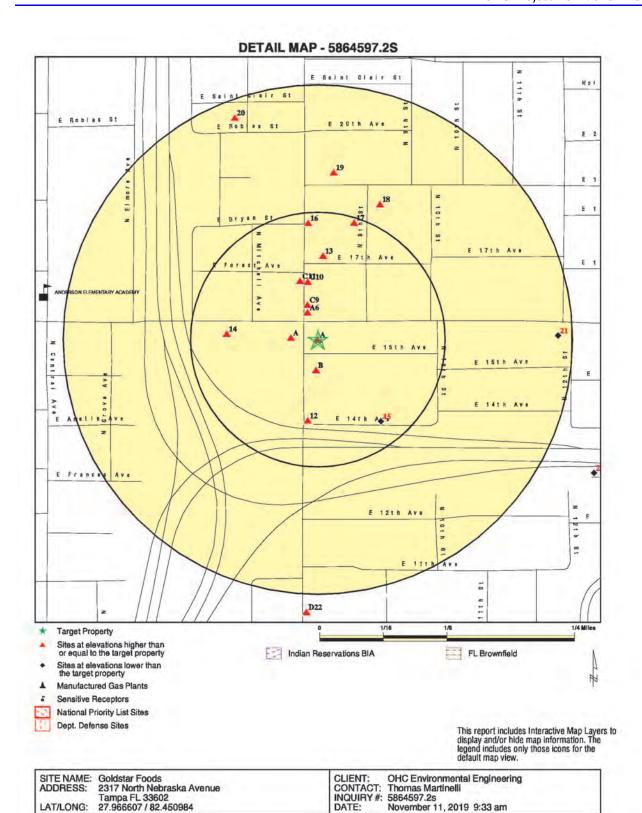



DATE:

November 11, 2019 9:33 am ight ⊕ 2019 EDR, Inc. ⊕ 2015 TomTom Rel. 2015.

LAT/LONG:

Database	Search Distance (Miles)	Target Property	< 1/8	1/8 - 1/4	1/4 - 1/2	1/2 - 1	<u>* 1</u>	Total Plotted
STANDARD ENVIRONMEN	NTAL RECORDS							
Federal NPL site list								
NPL Proposed NPL NPL LIENS	1.000 1.000 1.000		0	0	0	0	NR NR NR	0
Federal Delisted NPL s	ite list							
Delisted NPL	1.000		0	0	0	0	NR	0
Federal CERCLIS list								
FEDERAL FACILITY SEMS	0.500 0.500		0	0	0	NR NR	NR NR	0
Federal CERCLIS NFRA	AP site list							
SEMS-ARCHIVE	0.500		0	0	0	NR	NR	0
Federal RCRA CORRAC	CTS facilities l	ist						
CORRACTS	1.000		O	0	0	O.	NR	O
Federal RCRA non-COI	RRACTS TSD	facilities list						
RCRA-TSDF	0.500		0	0	0	NR	NR	O
Federal RCRA generate	ors list							
RCRA-LQG RCRA-SQG RCRA-VSQG	0.250 0.250 0.250		0	0	NR NR NR	NR NR NR	NR NR NR	0 0
Federal institutional co engineering controls re	De la Contra de la							
LUCIS US ENG CONTROLS US INST CONTROL	0.500 0.500 0.500		0	0	0	NR NR NR	NR NR NR	0
Federal ERNS list								
ERNS	TP		NR.	NR	NR	NR	NR	0
State- and tribal - equiv	alent CERCLIS	S						
SHWS	1.000		0	0	0	0	NR	0
State and tribal landfill solid waste disposal sit								
SWF/LF	0.500		0	Ö	6	NR	NR	6
State and tribal leaking	storage tank i	lists						
LUST LAST INDIAN LUST	0.500 0.500 0.500	ì	1 0 0	2 0 0	13 0 0	NR NR NR	NR NR NR	17 0 0
State and tribal register	red storage tar	nk lists						
FF TANKS	0.250		0	0	NR	NR	NR	0



Database	Search Distance (Miles)	Target Property	< 1/8	1/8 - 1/4	1/4 - 1/2	1/2 - 1	*1	Total Plotted
FEMA UST UST AST INDIAN UST TANKS	0.250 0.250 0.250 0.250 0.250	1	0 4 1 0	0 2 1 0 0	NR NR NR NR NR	NR NR NR NR NR	NR NR NR NR NR	0 7 2 0 0
State and tribal institution control / engineering co		es						
ENG CONTROLS INST CONTROL	0.500 0.500		0	0	0	NR NR	NR NR	0
State and tribal voluntar	ry cleanup sit	es						
VCP INDIAN VCP	0.500 0.500		0	0	2	NR NR	NR NR	2
State and tribal Brownfi	elds sites							
BROWNFIELDS	0.500		0 -	0	1	NR	NR	1
ADDITIONAL ENVIRONMENT	NTAL RECORD	s						
Local Brownfield lists								
US BROWNFIELDS	0.500		O	2	1	NR	NR	3
Local Lists of Landfill / 3 Waste Disposal Sites	Solid							
SWRCY INDIAN ODI ODI DEBRIS REGION 9 IHS OPEN DUMPS	0.500 0.500 0.500 0.500 0.500		0000	0 0 0 0	0 0 0	ZR ZR ZR ZR ZR	NR NR NR NR NR	0 0 0
Local Lists of Hazardou Contaminated Sites	s waste /							
US HIST CDL PRIORITYCLEANERS FI Sites US CDL PFAS	TP 0.500 1.000 TP 0.500		NR 0 NR 0	NR 0 0 NR 0	NR 0 1 NR 0	NR NR 1 NR NR	NR NR NR NR NR	0 0 2 0
Local Land Records								
LIENS 2	TP		NR	NR	NR	NR	NR	0
Records of Emergency	Release Repo	orts						
HMIRS SPILLS SPILLS 90 SPILLS 80	TP TP TP		NR NR NR NR	NR NR NR	NR NR NR NR	NR NR NR NR	NR NR NR NR	0 0
Other Ascertainable Rec	cords							
RCRA NonGen / NLR	0.250		0	0	NR	NR	NR	0



Database	Search Distance (Miles)	Target Property	< 1/8	1/8 - 1/4	1/4 - 1/2	1/2 - 1	×1_	Total Plotted
FUDS	1.000		Ō	0	0	1	NR	1
DOD	1.000		O	ō	ō	Ö	NR	0
SCRD DRYCLEANERS	0.500		ō	ō	Ō	NR	NR	ō
US FIN ASSUR	TP		NR	NR:	NR	NR	NR	0
EPA WATCH LIST	TP		NR	NR	NR	NR	NR	0
2020 COR ACTION	0.250		0	0	NR	NR	NR	0
TSCA	TP		NR	NR	NR	NR	NR	0
TRIS	TP		NR	NR	NR	NR	NR	o.
SSTS	TP		NR	NR.	NR	NR	NR	0
ROD	1,000		0	0	0	0	NR	0
RMP	TP		NR	NR:	NR	NR	NR	0
RAATS	TP		NR	NR	NR	NR	NR	0
PRP	TP		NR	NR	NR	NR	NR	0
PADS	TP		NR	NR	NR	NR	NR	0
ICIS	TP		NR	NR	NR	NR	NR	0
FTTS	TP		NR	NR	NR	NR	NR	0
MLTS	TP		NR	NR	NR	NR	NR	0
COAL ASH DOE	TP		NR	NR	NR	NR	NR	0
COAL ASH EPA	0,500		0	0	0	NR	NR	0
PCB TRANSFORMER	TP		NR	NR	NR	NR	NR	0
RADINFO	TP		NR	NR	NR	NR	NR	0
HIST FTTS	1b		NR	NR	NR	NR	NR	0
DOT OPS	TP		NR	NR	NR	NR	NR	0
CONSENT	1.000		0	0	0	0	NR	0
INDIAN RESERV	1.000		0	0	0	0	NR	0
FUSRAP	1.000		0	0	0	0	NR	0
UMTRA	0.500		0	0	0	NR	NR	0
LEAD SMELTERS	TP		NR	NR	NR.	NR	NR	0
US AIRS	TP		NR	NR	NR	NR	NR	0
US MINES	0.250		0	0	NR	NR	NR	0
ABANDONED MINES	0,250 TP		NR	NR	NR	NR	NR NR	0
FINDS DOCKET HWC	TP		NR	NR	NR	NR NR	NR	0
ECHO	TP		NR	NR	NR	NR	NR	Ö
UXO	1.000		0	0	.0	0	NR	Ö
FUELS PROGRAM	0.250		0	Ö	NR	NR	NR	Ö
AIRS	TP		NR	NR	NR	NR	NR	Ö
ASBESTOS	TP		NR	NR	NR	NR	NR	Ö
CLEANUP SITES	TP	ì	NR.	NR	NR	NR	NR	1
DEDB	0.250		1	0	NR	NR	NR	1
DRYCLEANERS	0.250		0	ŏ	NR	NR	NR	0
DWM CONTAM	0.500	7	0	2	8	NR	NR	11
Financial Assurance	TP	1	NR	NR	NR	NR	NR	1
FL Cattle Dip. Vats	0.250		0	0	NR	NR	NR	0
RESP PARTY	0.500		0	0	2	NR	NR	2
SITE INV SITES	0.500		0	ō	ō	NR	NR	ō
TIER 2	TP		NR	NR	NR	NR	NR	0
UIC	TP		NR	NR	NR	NR	NR	0
NPDES	TP		NR	NR:	NR	NR	NR	0
MINES MRDS	TP		NR	NR:	NR	NR	NR	0
EDR HIGH RISK HISTORICA	AL RECORDS							
EDR Exclusive Records								
EDR MGP	1.000		0	0	0	1	NR	1



Database	Search Distance (Miles)	Target Property	< 1/8	1/8 - 1/4	1/4 - 1/2	1/2 - 1	×1	Total Plotted
EDR Hist Auto EDR Hist Cleaner	0.125 0.125	1	5	NR NR	NR NR	NR NR	NR NR	8
Exclusive Recovered	Govt. Archives							
RGA HWS	TP		NR	NR	NR	NR	NR	0
RGALF	TP		NR	NR:	NR	NR	NR	0
RGA LUST	TP	1	NR	NR	NR	NR	NR	1
- Totals		7	16	9	36	3	0	71

#### NOTES

TP = Target Property

NR = Not Requested at this Search Distance

Sites may be listed in more than one database



Map ID MAP FINDINGS Direction Distance EDR ID Number Elevation Site Database(s) EPA ID Number GOLDSTAR FOODS U001356047 A1 LUST 2317 N NEBRASKA AVE UST Target N/A Property **TAMPA, FL 33602** CLEANUP SITES DWM CONTAM Site 1 of 6 in cluster A Financial Assurance Actual: LUST Region: STATE Facility Id. 8944840 Facility Status: OPEN A - Retail Station Facility Type: (813)443-5022 Not reported Facility Phone: Facility Cleanup Rank: Southwest District 27 58 0.0494 / 82 27 3.5345 District: Lat/Long (dms): Section: Not reported Township: Not reported Range Not reported Feature: Not reported Method: AGPS Datum: 10 Score: Score Effective Date: 2012-04-06 00:00:00 Score When Ranked Not reported RAID DARWISH Operator: Name Update Not reported Address Update 2010-01-14 00:00:00 Petroleum Cleanup PCT Facility Score Facility Cleanup Status: Contact: ONGO - ONGOING BURT JAGNOHAN/ SHIRLEY Contact Company: O'HENRY FOODS Contact Address: 16019 GLEN HAVEN DR Contact City/State/Zip. TAMPA, FL 33618 Phone. (813)969-3970 Bad Address Ind. State: FL 33602, 1723 Zip: Score: 10 Score Effective Date: 2012-04-06 00:00:00 Related Party ID: 30537 Primary RP Role: ACCOUNT OWNER RP Begin Date: 1994-04-22 RP Zip Not reported RP Extension Not reported Discharge Cleanup Summary: Discharge Date: 11/30/2010 PCT Discharge Combined: Not reported R - CLEANUP REQUIRED Cleanup Required: Discharge Cleanup Status: SA - SA ONGOING Disch Cleanup Status Date: Cleanup Work Status: 3/14/2012 INACTIVE D - DISCHARGE NOTIFICATION Information Source: Other Source Description. Not reported Eligibility Indicator: I - INELIGIBLE Site Manager. HEINTZ\_C Site Mgr End Date: Not reported PCLP29 - HILLSBOROUGH ENVIRONMENTAL PROTECTION COMMISSION Tank Office:



Map ID
Direction
Distance
Elevation Site

MAP FINDINGS

EDR ID Number

EDR ID Number

EPA ID Number

#### GOLDSTAR FOODS (Continued)

U001356047

Contaminated Media: Discharge Date 11/30/2010 Pct Discharge Combined With: Not reported R - CLEANUP REQUIRED Cleanup Required: Discharge Cleanup Status: Disch Cleanup Status Date: SA - SA ONGOING 3/14/2012 Cleanup Work Status: INACTIVE Information Source: D - DISCHARGE NOTIFICATION Other Source Description: Not reported Elig Indicator: I-INELIGIBLE Site Manager HEINTZ\_C Site Mgr End Date: Not reported PCLP29 - HILLSBOROUGH ENVIRONM Tank Office: Contaminated Drinking Wells: Not reported Contaminated Monitoring Well: Contaminated Soil: No Yes Contaminated Surface Water: No Contaminated Ground Water: No B - Unleaded Gas Pollutant Other Description: Mid-grade Gallons Discharged: Not reported Task Information: District: SWD Facility ID 8944840 Facility Status: OPEN Facility Type: A - Relail Station -County: HILLSBOROUGH County ID: Cleanup Eligibility Status: Source Effective Date. Not reported 11-30-2010 R - CLEANUP REQUIRED Discharge Date: Cleanup Required: Discharge Cleanup Status: SA - SA ONGOING Disch Cleanup Status Date: 03-14-2012 SRC Action Type: SRC Submit Date: Not reported SRC Review Date: Not reported SRC Completion Status: Not reported SRC Issue Date: SRC Comment: Not reported INACTIVE Cleanup Work Status: Site Mgr: HEINTZ\_C Site Mgr End Date: Not reported Tank Office PCLP29 - Hillsborough County SR Task ID Not reported SR Cleanup Responsible: SR Funding Eligibility Type: SR Actual Cost: Not reported SR Completion Date: SR Payment Date: Not reported Not reported Not reported SR Oral Date: Not reported SR Written Date: SR Soil Removal: Not reported SR Free Product Removal: Not reported SR Soil Tonnage Removed: Not reported SR Soil Treatment: Not reported



MAP FINDINGS Map ID Direction Distance EDR ID Number Elevation Site Database(s) EPA ID Number

GOLDSTAR FOODS (Continued)

U001356047

SR Other Treatment: Not reported SR Alternate Proc Received Date Not reported SR Alternate Procedure Status: Not reported SR Alternate Procedure Status Date Not reported SR Alternate Procedure Comments: Not reported SA Task ID: SA Cleanup Responsible; SA Funding Eligibility Type: SA Actual Cost: Not reported

SA Completion Date: Not reported SA Payment Date: Not reported RAP Task ID: Not reported RAP Cleanup Responsible ID:

RAP Funding Eligibility Type: RAP Actual Cost:

Not reported RAP Completion Date: Not reported RAP Payment Date: Not reported RAP Last Order Approved: Not reported RA Task ID: Not reported RA Cleanup Responsible:

RA Funding Eligibility Type: RA Years to Complete:

Not reported RA Actual Cost: Not reported

Click here for Florida Oculus:

UST

Facility Id: 8944840 Facility Status: OPEN Type Description: Retail Station Facility Phone: 8134435022 Region: STATE Positioning Method: AGPS

27 57 47 / 82 26 16 Lat/Long (dms):

Owner:

Owner Id: 30537

O'HENRY FOODS Owner Name: 16019 GLEN HAVEN DR Owner Address: Owner Address 2: ATTN: BURT JAGNOHAN/ SHIRLEY

TAMPA, FL 33618 BURT JAGNOHAN/ SHIRLEY Owner City, St. Zip:

Owner Contact:

Owner Phone: 8139693970

Tank Info:

GOLDSTAR FOODS Name: Address 2317 N NEBRASKA AVE Tank ld:

Removed Status: Status Date: 11/16/2010 install Date: 7/1/1984 Substance Unleaded gas Content Description: Unleaded Gas Gallons: 6000

Vessel Indicator: TANK Tank Location: UNDERGROUND

DEP Contractor: C



MAP FINDINGS Map ID Direction Distance EDR ID Number Elevation Site Database(s) EPA ID Number

GOLDSTAR FOODS (Continued)

U001356047

GOLDSTAR FOODS Name: Address 2317 N NEBRASKA AVE Tank Id:

Status: Removed Status Date: 11/16/2010 Install Date: 7/1/1984 Substance: Unleaded gas Content Description: Unleaded Gas Gallons: 6000 Vessel indicator TANK

UNDERGROUND Tank Location:

DEP Contractor:

Name: GOLDSTAR FOODS Address: 2317 N NEBRASKA AVE

Tank Id: Status: Removed Status Date: 11/16/2010 Install Date: 7/1/1984 Unleaded gas Substance: Content Description: Unleaded Gas Gallons: 6000 TANK Vessel Indicator

Tank Location! UNDERGROUND

DEP Contractor

Name: GOLDSTAR FOODS Address Tank Id: 2317 N NEBRASKA AVE

Removed 4/30/1992 Status: Status Date: Install Date: Not reported Kerosene Substance: Content Description: Kerosene Gallons: 550 Vessel indicator: TANK

Tank Location: UNDERGROUND

DEP Contractor:

GOLDSTAR FOODS 2317 N NEBRASKA AVE Name: Address: Tank Id:

Status: In service Status Date: 11/1/2010 Install Date: 11/1/2010 Substance: Unleaded gas Content Description: Unleaded Gas Gallons 20000 Vessel Indicator TANK

UNDERGROUND

Tank Location: DEP Contractor. C

Construction

Tank ld:

Construction Category, Primary Construction

Construction Description Steel

Tank Id: 5



 Map ID
 Direction

 Distance
 EDR ID Number

 Elevation
 Site

 Database(s)
 EPA ID Number

GOLDSTAR FOODS (Continued)

U001356047

Construction Category: Overfill/Spill Construction Description: Ball check vi

Ball check valve

Tank Id:

Construction Category Secondary Containment
Construction Description, Double wall - tank jacket

Tank ld: 5

Construction Category M Construction Description C

Miscellaneous Attributes Compartmented

Tank ld:

Construction Category Overfill/Spill Construction Description: Flow shut-Off

Tank ld:

Construction Category: Overfill/Spill

Construction Description Spill containment bucket

Monitoring:

Tank ID;

Monitoring Description Monitor dbl wall tank space

Tank ID:

Monitoring Description Electronic monitor pipe sumps

Tank ID:

Monitoring Description. Visual inspect dispenser liners

Tank ID:

Monitoring Description. Continuous electronic sensing

Tank ID:

Monitoring Description: Monitor dbl wall pipe space

Tenk ID:

Monitoring Description: Mechanical line leak detector

Piping: Tank ID:

ank ID:

Píping Category: Miscellaneous Attributes
Píping Description: Pressurized piping system

Tank ID:

Piping Category: Primery Construction
Piping Description: Approved synthetic material

Tank ID:

Piping Category Miscellaneous Attributes
Piping Description: Dispenser liners

Tank ID:

Piping Category: Secondary Containment

Piping Description: Double wall



Map ID MAP FINDINGS Direction Distance EDR ID Number Elevation Site Database(s) EPA ID Number

GOLDSTAR FOODS (Continued)

U001356047

#### Click here for Florida Oculus.

CLEANUP SITES:

GOLDSTAR FOODS 2317 N NEBRASKA AVE Name Address: TAMPA, FL 33602 City.State.Zip: DEP Cleanup Site Key: 59734328

Source Database Name: Storage Tank Contamination Monitoring

Source Database Id: 8944840 CPAC Program Area Id: CLLC Cleanup Category Key: PETRO RSC2 Remediation Status Key: ACTIVE Data Load Date: 08/26/2019 OC3 Office ld: SWD Physical Address Line 2: Not reported OIC Object Of Interest Id: FACIL PC2 Proximity Id: EXACT

Calc Coordinates Accuracy Level Id:

CMC2 Coordinate Method Id: Digital Aerial Photography With Ground Control

DC4 Datum Id: High Accuracy Reference Network

VSC1 Verification Status: REVIEWED RICCI\_L 06/04/2003 Collect Username Collect Date:

DEPARTMENT OF ENVIRONMENTAL PR Collect Affiliation

Map Source: 1994 dogs Map Source Scale 2670 Interpolation Scale: Not reported Verifier Username: RICCI\_L

Verifier Affiliation: DEPARTMENT OF ENVIRONMENTAL PR Verification Date: 06/04/2003

Verified Coordinate Method Id: Digital Aerial Photography With Ground Control

Source Database Name Code: STCM CMC2 Coordinate Method ID Code: DPHO DC4 Datum ID Code: HARN Verified Coordinate Method ID Code: DPHO Not reported Comments

Latitude/Longitude (deg/min/sec): 27 58 0.0494 / 82 27 3,5345

DWM CONTAM

Program Site Id: Lat DD: 8944840 27 Lat MM 58 Lat SS: 0.0494 Long DD: 82 Long MM: 27 Long SS 3.5345 Office/ District: SWD Program Area Offsite Contamination Storage Tanks Not reported Project Manager Not reported Priority Score: 10 Datum: 0 Method: AGPS Facility Status: OPEN Feature: Not reported



Map ID MAP FINDINGS Direction Distance EDR ID Number Elevation Site Database(s) EPA ID Number

GOLDSTAR FOODS (Continued)

U001356047

Not reported Not reported Sections Township: Not reported Range: Staff Assigned: Not reported Priority (Y/N): Not reported

FL Financial Assurance 3:

Region: Facility ID: 8944840

Facility Phone: 8134435022 Facility Status; OPEN Facility Type: Retail Station Type Description: DEP CO: Finaincial Responsibility: INSURANCE Insurance Company: ACE Effective Date:

12/27/2012 Expire Date: 12/27/2013 Owner ID: 30537 Onwer Name: O'HENRY FOODS

Owner Address: 16019 GLEN HAVEN DR Owner Address2: ATTN: BURT JAGNOHAN/ SHIRLEY Owner City, St, Zip: TAMPA, FL 33618.

BURT JAGNOHAN/ SHIRLEY Contact

Resp Party Phone 8139693970

Region : Facility ID: 8944840 Facility Phone: 8134435022 Facility Status: OPEN Facility Type:

Type Description: Retail Station DEP CO: INSURANCE Finalnoial Responsibility: Insurance Company: ACE 12/27/2014 Effective Date: 12/27/2015 Expire Date: Owner ID: 30537

Onwer Name: O'HENRY FOODS Owner Address: 16019 GLEN HAVEN DR Owner Address2: ATTN: BURT JAGNOHAN/ SHIRLEY

Owner City, St, Zip: TAMPA, FL 33618

Contact:

BURT JAGNOHAM SHIRLEY Resp Party Phone: 8139693970

Region

Facility ID: 8944840 Facility Phone: 8134435022 Facility Status: OPEN Facility Type: Retail Station Type Description: DEP CO: Finaincial Responsibility: INSURANCE ACE 12/27/2015 Insurance Company: Effective Date: Expire Date: 12/27/2016

Owner ID:

TC5864597.2s Page 14



30537

Map ID MAP FINDINGS Direction EDR ID Number Distance Elevation Site Database(s) EPA ID Number

GOLDSTAR FOODS (Continued)

U001356047

O'HENRY FOODS Onwer Name:

16019 GLEN HAVEN DR Owner Address ATTN: BURT JAGNOHAN/ SHIRLEY Owner Address2

Owner City,St,Zip TAMPA, FL 33618

Contact: BURT JAGNOHAN/ SHIRLEY

Resp Party Phone: 8139693970

Region: Facility ID: 8944840 8134435022 OPEN Facility Phone: Facility Status: Facility Type: Type Description: Retail Station

DEP CO: Finaincial Responsibility: INSURANCE Insurance Company: ACE AMER INS CO Effective Date: 12/27/2016 Expire Date: 12/27/2017 Owner ID: 30537

O'HENRY FOODS Onwer Name 16019 GLEN HAVEN DR Owner Address:

ATTN: BURT JAGNOHAN/SHIRLEY Owner Address2 Owner City,St,Zip: TAMPA, FL 33618.

BURT JAGNOHAN/ SHIRLEY Contact

Resp Party Phone: 8139693970

Region Facility ID: 8944840 Facility Phone: 8134435022 Facility Status: OPEN Facility Type: Type Description: DEP CO: Retail Station

Finalncial Responsibility: INSURANCE

Insurance Company: AMERICAN SAFETY INDEMNITY CO.

Effective Date: 04/25/2008 Expire Date: 04/25/2009 Owner ID: 30537 O'HENRY FOODS Onwer Name:

16019 GLEN HAVEN DR Owner Address:

Owner Address2: ATTN: BURT JAGNOHAN/ SHIRLEY Owner City,St,Zip: **TAMPA, FL 33618** 

BURT JAGNOHAN/ SHIRLEY Contact:

Resp Party Phone: 8139693970

Region: 8944840 Facility ID: Facility Phone: 8134435022 Facility Status: OPEN Facility Type: Type Description: A Retail Station

DEP CO: Finaincial Responsibility: INSURANCE Insurance Company: ZURICH-AMERICAN

Effective Date: 12/27/2010 Expire Date: 12/27/2011 Owner ID: 30537



Map ID MAP FINDINGS Direction Distance EDR ID Number Elevation Site Database(s) EPA ID Number GOLDSTAR FOODS (Continued) U001356047 O'HENRY FOODS Onwer Name: 16019 GLEN HAVEN DR Owner Address Owner Address2 ATTN: BURT JAGNOHAN/ SHIRLEY Owner City,St,Zip: TAMPA, FL 33618 Contact: BURT JAGNOHAN/ SHIRLEY Resp Party Phone: 8139693970 Region: 8944840 Facility ID: Facility Phone: 8134435022 Facility Status: OPEN Facility Type: Type Description: Retail Station DEP CO: Finaincial Responsibility: INSURANCE Insurance Company: ZURICH-AMERICAN Effective Date: 12/27/2011 Expire Date: 12/27/2012 Owner ID: 30537 O'HENRY FOODS Onwer Name: 16019 GLEN HAVEN DR Owner Address: ATTN: BURT JAGNOHAN/SHIRLEY Owner Address2: Owner City, St. Zip: TAMPA, FL 33618 BURT JAGNOHAN/ SHIRLEY Contact Resp Party Phone. 8139693970 A2 ULTRA TUNE CL AVANA MGR EDR Hist Auto 1009102538 2317 NEBRASKA AVE TAMPA, FL Target N/A Property Site 2 of 6 in cluster A Actual: **EDR Hist Auto** 41 ft. Year: Name: FOX SERVICE STATION GASOLINE AND OIL SERVICE STATIONS 1939 1944 HERMAN S SERVICE STATION GASOLINE AND OIL SERVICE STATION ROMEO ALT GASOLINE AND OIL SERVICE STATIONS 1949 LEO S SERVICE STATION GASOLINE SERVICE STATIONS 1955 1959 SCOTT S SINCLAIR SERVICE STATIO GASOLINE STATIONS 1969 THOMPSON SINCLAIR SERVICE STATI GASOLINE STATIONS 1974 THOMPSON S AUTO SERVICE AUTOMOBILE REPAIRING 1978 V & V AUTO SERVICE GASOLINE STATION AUTOMOBILE REPAIRING 1983 ULTRA TUNE CL AVANA MGR GOLD STAR FOOD STORES INC Grocery Stores Grocery Stores 1986 GOLD STAR FOOD STORES INC 1987 1987 O HENRYS FOODS INC Grocery Stores O HENRYS FOODS INC Grocery Stores 1988 1989 O HENRYS FOODS INC Convenience Stores 1990 O HENRYS FOODS INC Convenience Stores 1991 O HENRYS FOODS INC Convenience Stores 1992 O HENRYS FOODS INC Convenience Stores O HENRYS FOODS INC 1993 Convenience Stores 1994 Convenience Stores O HENRYS FOODS INC 1995 Convenience Stores



## ATTACHMENT V

## **Local/State Search Information**



From: Figari, Jeannett
To: Tom Martinelli

RE: PRR - 2317 N. Nebraska Ave, 1023 E. Columbus Drive, 1312 E. Columbus Drive

 Subject:
 RE: PRR - 2317 N. Nebraska Ave, 1023

 Date:
 Friday, November 15, 2019 1:43:07 PM

Good afternoon Mr. Marinelli,

In follow up to the response I sent yesterday, I just wanted to confirm that the Air, Water and Wetlands Divisions did not locate any records for the three properties in question.

Sincerely,

#### Jeannette Figari

Legal Administrative Assistant Legal Department (813) 627-2600 ext. 1054 | www.enchc.org

#### **Environmental Protection Commission**

3629 Queen Palm Drive, Tampa, FL 33619

Our mission is "to protect our natural resources, environment, and quality of life in Hillsborough County," Follow us on: Twitter, | Facebook | YouTube

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From: Figari, Jeannette

**Sent:** Thursday, November 14, 2019 2:29 PM **To:** Tom Martinelli < tmartinelli@ohcnet.com>

Subject: FW: PRR - 2317 N. Nebraska Ave, 1023 E. Columbus Drive, 1312 E. Columbus Drive

Good afternoon Mr. Martinelli,

As we discussed, included below is the response from our Waste Division. Please contact Pat Pons at  $813-627-2600 \times 1204$  and she will be able to let you know if the records are paper records or electronic records.

Sincerely,

#### Jeannette Figari

Légal Administrative Assistant Legal and Administrative Services Division (813) 627-2600 ext. 1054 | www.epchc.org



#### **Environmental Protection Commission**

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From: Pons, Pat < Pons@epchc.org>

Sent: Wednesday, November 13, 2019 1:10 PM To: Figari, Jeannette < Figari, @epchc.org >

Subject: RE: PRR - 2317 N. Nebraska Ave, 1023 E. Columbus Drive, 1312 E. Columbus Drive

Hi Jeannette,

The Waste Division has the following records for these locations:

2317 North Nebraska:
Enforcement Case — 14-44840
Warning Notices - #31073, #31074, #15834, #2005-2554H, #12160 and #2011-0158H
Tanks — Facility ID — 298944840
Cleanup- 298944840

1023 East Columbus Drive SQG -Yes Tanks — Facility ID — 298508982 Cleanup — 298508982

1312 East Columbus Drive
Enforcement Case – 01-24765 and 99-18467
Warning Notices - #18467, #21316, #2016-0085H, #2016-0086H and #2015-278H
Tanks – Facility ID – 298624765
Cleanup – 298624765

Pat

Patricia Pons

Environmental Specialist III Waste Management Division (813) 627-2600 ext. 1204/www.epchc.org

**Environmental Protection Commission** 



3629 Oucen Palm Drive, Tampa, FL 33619

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From: Figari, Jeannette < FigariJ@epchc.org>

Sent: Tuesday, November 12, 2019 11:16 AM

To: Castillo, Laura < castillol@epchc.org>; Hager, Margaret < Hager@epchc.org>; Merchant, Sabatia

<merchants@epchc.org>; Mishriki, Madlein < Mishriki@epchc.org>; Myrick, Joyce

<myricki@epchc.org>; Noblitt, Paula <NoblittP@epchc.org>; Pons, Pat <Pons@epchc.org>; Reese,

Marsha <<u>Reese@epchc.org</u>>; Sanchez, Silvia <<u>sanchezs@epchc.org</u>>; Torres, Gladys

<torresg@epchc.org>

<Boostani@epchc.org>; Elrabi, Sam <<u>Elrabi@epchc.org</u>>; Schipfer, Andy <<u>Schipfer@epchc.org</u>>;

Sims, Jeff < Sims 1@epchc.org >; Woodard, Sterlin < Woodard@epchc.org >

Subject: PRR - 2317 N. Nebraska Ave, 1023 E. Columbus Drive, 1312 E. Columbus Drive

The Legal Dept. received a request for records pertaining to the following properties:

2317 N. Nebraska Ave, Tampa – folio #198390-0000

1023 E. Columbus Drive, Tampa - folio #198262-0000

1312 E. Columbus Drive, Tampa - folio #186699-0000.

Please let me know by Monday, November 18, 2019 if your Division does or does not have any records.

Thank you,

## Jeannette Figari

Legal Administrative Assistant
Legal and Administrative Services Division
(813) 627-2600 ext. 1054 | www.epchc.org

### **Environmental Protection Commission**

3629 Queen Palm Drive, Tampa, FL 33619

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From: Figari, Jeannette
To: Tom Martinelli
Subject: RE: Right to Kno

Subject: RE: Right to Know Request

Date: Tuesday, November 12, 2019 9:48:47 AM

Good morning Mr. Martinelli,

The Environmental Protection Commission of Hillsborough County received your records request and will initiate an Agency-wide records search in accordance with Chapter 119, F.S. We are glad to assist in locating any responsive records and will contact you regarding the outcome of the search as soon as possible.

If you have any questions, please feel free to contact me.

Sincerely,

### Jeannette Figari

Legal Administrative Assistant!
Legal and Administrative Services Division
(813) 527-2600 ext. 1054 | www.epchc.org

#### **Environmental Protection Commission**

3629 Queen Palm Drive, Tampa, FL 33619

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From: Tom Martinelli <tmartinelli@ohcnet.com>
Sent: Monday, November 11, 2019 9:00 AM
To: Figari, Jeannette <FigariJ@epchc.org>

Subject: Right to Know Request

Please search your records for any spills, discharges, hazardous materials releases, underground/aboveground storage tanks, environmental remediation activities, etc. for the sites listed below. Thanks.

O-Henry's Foods Inc.



Parcel #A-18-29-19-51D-000000-00001.0 2317 N NEBRASKA AVE, TAMPA 33602

Danny's Generators-Ramos, Deborah Lisa Parcel #A-18-29-19-51A-000000-1-00001.0 1023 E COLUMBUS DR, TAMPA 33605

Columbus Foods-Pearl Managementco Inc. Parcel #A-07-29-19-4UV-000000-00048.0 1312 E COLUMBUS DR, TAMPA 33605



 From:
 FireMarshall

 To:
 Tom Martinelli

Subject: RE: Right to Know Request

Date: Tuesday, November 12, 2019 9:07:18 AM

Attachments: jmage003.png jmage004.png

Good morning Mr. Martinelli,

Those properties are in the City of Tampa jurisdiction, please contact the City of Tampa Fire Marshal's office at 813-274-7000 to request those records.

## Thank you, have a blessed day.

#### Miguelina (Betty) Rodriguez

Administrative Assistant Hillsborough County Fire Rescue

P: (813) 744-5541 F: (813) 744-5794

E: RodriguezMB@HCFLGov.Net

W HCFLGov.net

## Hillsborough County Fire Rescue

9450 E. Columbus Drive, Tampa, FL 33619

Facebook | Twitter | YouTube | LinkedIn

Please note: All correspondence to or from this office is subject to Florida's Public Records law,



From: Tom Martinelli [mailto:tmartinelli@ohcnet.com]

Sent: Monday, November 11, 2019 9:18 AM

To: FireMarshall <FireMarshal@HillsboroughCounty.ORG>

Subject: Right to Know Request

## [External]

Please provide any emergency response incident records at the properties listed below. Thanks

O-Henry's Foods Inc. Parcel #A-18-29-19-51D-000000-00001.0 2317 N NEBRASKA AVE, TAMPA 33605

Danny's Generators-



Ramos, Deborah Lisa Parcel #A-18-29-19-51A-000000-1-00001.0 1023 E COLUMBUS DR, TAMPA 33602

Columbus Foods-Pearl Managementco Inc. Parcel #A-07-29-19-4UV-000000-00048.0 1312 E COLUMBUS DR, TAMPA 33602

This email is from an **EXTERNAL** source and did not originate from a Hillsborough County email address. Use caution when clicking on links and attachments from outside sources.



## **Goldstar Foods**

2317 North Nebraska Avenue Tampa, FL 33602

Inquiry Number: 5864597.5 November 11, 2019

# The EDR-City Directory Abstract



6 Armstrong Road Shelton, CT 96484 800.352.0050 www.edrnet.com



#### TABLE OF CONTENTS

#### SECTION

**Executive Summary** 

**Findings** 

City Directory Images

Thank you for your business.

Please contact EDR at 1-800-352-0050
with any questions or comments.

#### Disclaimer - Copyright and Trademark Notice

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#### **EXECUTIVE SUMMARY**

#### DESCRIPTION

Environmental Data Resources, Inc.'s (EDR) City Directory Abstract is a screening tool designed to assist environmental professionals in evaluating potential liability on a target property resulting from past activities. EDR's City Directory Abstract includes a search and abstract of available city directory data. For each address, the directory lists the name of the corresponding occupant at five year intervals.

Business directories including city, cross reference and telephone directories were reviewed, if available, at approximately five year intervals for the years spanning 1920 through 2014. This report compiles information gathered in this review by geocoding the latitude and longitude of properties identified and gathering information about properties within 660 feet of the target property.

A summary of the information obtained is provided in the text of this report.

#### RECORD SOURCES

EDR's Digital Archive combines historical directory listings from sources such as Cole Information and Dun & Bradstreet. These standard sources of property information complement and enhance each other to provide a more comprehensive report.

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#### RESEARCH SUMMARY

The following research sources were consulted in the preparation of this report. An "X" indicates where information was identified in the source and provided in this report.

<u>Year</u>	Source	<u>TP</u>	<u>Adjoining</u>	Text Abstract	Source Image
2014	EDR Digital Archive	-	Χ	X	-
	EDR Digital Archive	X	X	X	
2010	EDR Digital Archive	-	X	X	-
	EDR Digital Archive	X	X	X	-
2005	EDR Digital Archive	u.	X	X	-
2004	Cole Publishing	-	X	X	-
	Cole Publishing	X	X	X	
1999	Hill-Donnelly Corporation	-	X	X	X
	Hill-Donnelly Corporation	X	X	X	X
1993	R. L. Polk Co.		X	X	X
	R. L. Polk Co.	X	X	X	X
1988	R. L. Polk Co.	-	X	X	Х

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EXECUTIVE SUMMARY					
<u>Year</u>	Source	IP	Adjoining	Text Abstract	Source Imag
1988	R. L. Polk Co.	X	×	×	×
1986	R. L. Polk & Co.			-	*
1983	R. L. Polk Co.	4	×	X	×
	R. L. Polk Co.	X	X	X	×
1980	R.L. POLK & CO.	-	*	40	-
1978	R. L. Polk Co.	5	×	×	×
	R. L. Polk Co.	X	×	X	X
1975	R.L. POLK & CO.	20	100	198	-0
1974	R. L. Polk Co.	-	×	X	X
	R. L. Polk Co.	X	×	X	×
1971	R.L. POLK & CO.		-	(2)	
1969	R. L. Polk & Co.	-	×	X	×
	R. L. Polk & Co.	X	×	X	X
1966	R.L POLK & CO.	-	÷.		-
1964	R.L. POLK & CO. PUBLISHERS	-	÷	÷<	4
1963	R.L. POLK & CO.	-	n	5	
1962	R L Polk Co	L	×	X	X
	R L Polk Co	X	X	X	X
1959	R L Polk Co	÷	×	×	×
1955	R L Polk Co	-	×	×	×
	R L Polk, Co	X	×	×	×
1949	R L Polk Co	- 40	×	×	X
	R L Polk Co	X	×	×	×
1944	R. L. Polk Co. Publishers	8	×	X	x
	R. L. Polk Co. Publishers	X	×	X	X
1939	R. L. Polk Co.	6	×	×	×
	R. L. Polk Co.	X	X	X	×
1934	R. L. Polk Co.	-	×	X	×
1930	R. L. Polk Co.	12	×	X	×
1925	R. L. Polk Co.	-	X	×	×
1920	R. L. Polk Co.	-	×	X	X

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### RECORD SOURCES

EDR's Digital Archive combines historical directory listings from sources such as Cole Information and Dun & Bradstreet. These standard sources of property information complement and enhance each other to provide a more comprehensive report.

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## FINDINGS

## TARGET PROPERTY INFORMATION

## ADDRESS

2317 North Nebraska Avenue Tampa, FL 33602

## FINDINGS DETAIL

Target Property research detail.

## N Nebraska Ave

### 2317 N Nebraska Ave

<u>Year</u>	<u>Uses</u>	Source
2014	GOLD STAR GAS INC	EDR Digital Archive
2010	ONE STAR INC	EDR Digital Archive
	RND BROTHERS INC	EDR Digital Archive

## NEBRASKA AVE

## 2317 NEBRASKA AVE

<u>Year</u>	<u>Uses</u>	Source	
2004	Goldstar Food Store	Cale Publishing	
	Star Gold	Cole Publishing	
1993	GOLD STAR FOODS gas & food	R. L. Polk Co.	Image pg. A14
1988	Citgo Food Mart gas & food mart	R. L. Polk Co.	Image pg. A24
1983	Ultra Tune CI Avana Mgr auto repr	R. L. Polk Co.	Image pg. A33
1978	V & V Auto Service gas sta	R. L. Polk Co.	Image pg. A44
1974	Thompsons Auto Service serv & gas	R. L. Polk Co.	image pg. A54
1969	THOMPSON SINCLAIR SERVICE STATION	R. L. Polk & Co	Image pg. A65
1962	Diaz Prod	R L Polk Co	Image pg A78
1955	Leos Serv Sta	R L Polk Co	Image pg. A98
1949	Romeo Alf fill sta	R L Polk Co	Image pg. A108
1944	Hermans Service Station filling sta	R. L. Polk Co, Publishers	Image pg. A121
1939	Fox Service Station filling sta	R. L. Polk Co.	Image pg. A143

## NEBRASKA AVE N

## 2317 NEBRASKA AVE N

<u>Year</u>	Uses	Source	
1999	GOLD STAR FOODS	Hill-Donnelly Corporation	Image pg. A1

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## **FINDINGS**

## ADJOINING PROPERTY DETAIL

The following Adjoining Property addresses were researched for this report. Detailed findings are provided for each address.

## 10TH ST

#### 2401 10TH ST

<u>Year</u>	Uses	Source	
1959	Hernandez John	R L Polk Co	Image pg; A89
	Martinez Sixto L	R L Polk Co	Image pg. A89
1955	Vacant	R L Polk Go	Image pg. A99
	Quintana Virgilio	R L Polk Co	Image pg. A99
1949	Bowers Philip A	R L Polk Co.	Image pg. A109
1944	Bowers Philip A	R. L. Polk Co. Publishers	Image pg. A122
1939	Sierra Antonio Jr	R. L. Polk Co.	Image pg A144
1934	Martinez Virginia	R. L. Polk Co.	Image pg. A160
1930	Blanco Alfonso	R. L. Polk Co.	linage pg. A169
1925	Arth Schleman jr	R. L. Polk Co	Image pg. A177
1920	Mrs I Dorman	R. L. Polk Co.	Image pg. A184
2402 40	THE		

## 2402 10TH ST

<u>Year</u>	Uses	Source	
1939	Chillura Anthony	R. L. Polk Co.	Image pg. A145

## 2403 10TH ST

Year	Uses	Source	
1944	Rodriguez Frank M	R. L. Polk Co. Publishers	Image pg. A122
1939	Lala Catalina Mrs	R L Polk Co.	Image pg. A146
1934	Lala Catalina Mrs	R. L. Polk Co.	Image pg. A160
1930	Lala Catalina Mrs	R. L. Polk Co.	Image pg. A169

#### 2405 10TH ST

<u>Year</u>	<u>Uses</u>	Source	
1959	Lala Martin	R L Polk Co	Image pg. A89
	Duran Julia Mrs	R L Polk Co	Image pg A89
1955	Lala Martin	R L Polk Co	Image pg. A99
1949	Pitisci I Chas	R L Polk Co	Image pg. A109
1944	Pitisci Ignazio C	R. L. Polk Co, Publishers	Image pg. A122

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## **ATTACHMENT VI**

Sanborn Map Report



Goldstar Foods 2317 North Nebraska Avenue Tampa, FL 33602

Inquiry Number: 5864597.3

November 11, 2019

# **Certified Sanborn® Map Report**



6 Armstrong Road, 4th floor Shelton, CT 06484 Toll Free: 800.352.0050 www.edrnet.com



## Certified Sanborn® Map Report

11/11/19

Site Name:

Client Name:

Goldstar Foods 2317 North Nebraska Avenue OHC Environmental Engineering 5420 Bay Center Drive Suite 100 Tampa, FL 33609-0000

Tampa, FL 33602 EDR Inquiry # 5864597.3 Contact: Thomas Martinelli



The Sanborn Library has been searched by EDR and maps covering the target property location as provided by OHC Environmental Engineering were identified for the years listed below. The Sanborn Library is the largest, most complete collection of fire insurance maps The collection includes maps from Sanborn, Bromley, Perris & Browne, Hopkins, Barlow, and others. Only Environmental Data Resources Inc. (EDR) is authorized to grant rights for commercial reproduction of maps by the Sanborn Library LLC, the copyright holder for the collection. Results can be authenticated by visiting www.edrnet.com/sanborn.

The Sanborn Library is continually enhanced with newly identified map archives. This report accesses all maps in the collection as of the day this report was generated

#### Certified Sanborn Results:

Certification # 8323-40A8-BB1E

PO#

Project 2317 North Nebraska Avenue

#### Maps Provided:

1979

1976

1950 1931

1915



Certification #: 8323-40A8-BB1E

The Sanborn Library includes more than 1.2 million fire insurance maps from Sanborn, Bromley, Perris & Browne, Hopkins, Barlow and others which track historical property usage in approximately 12,000 American cities and towns. Collections searched:

✓ Library of Congress

University Publications of America

✓ EDR Private Collection

The Sanborn Library LLC Since 1866™

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#### Sanborn Sheet Key

This Certified Sanborn Map Report is based upon the following Sanborn Fire Insurance map sheets.



#### 1979 Source Sheets







Volume 1, Sheet 67



Volume 3 & 6, Sheet 30



Volume 3 & 6, Sheet 308

### 1976 Source Sheets



Volume 1, Sheet 66



Volume 1, Sheet 67

## 1950 Source Sheets



Volume 1, Sheet 66



Volume 1, Sheet 67



Volume 3, Sheet 307



Volume 3, Sheet 308

#### 1931 Source Sheets



Volume 1, Sheet 66



Volume 1, Sheet 67



Volume 3, Sheet 307



Volume 3, Sheet 308

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## Sanborn Sheet Key

This Certified Sanborn Map Report is based upon the following Sanborn Fire Insurance map sheets.



#### 1915 Source Sheets



Volume 1. Sheet 6

OHC