
The Enclosed Document Is Provided For Your Convenience.

Please Email ALL Questions:

MailTo:ContractAdministration@TampaGov.net

Please Let Us Know If You Plan To Bid

City of Tampa
Contract Administration Department
306 E. Jackson St. #280A4N
Tampa, FL 33602
(813)274-8456

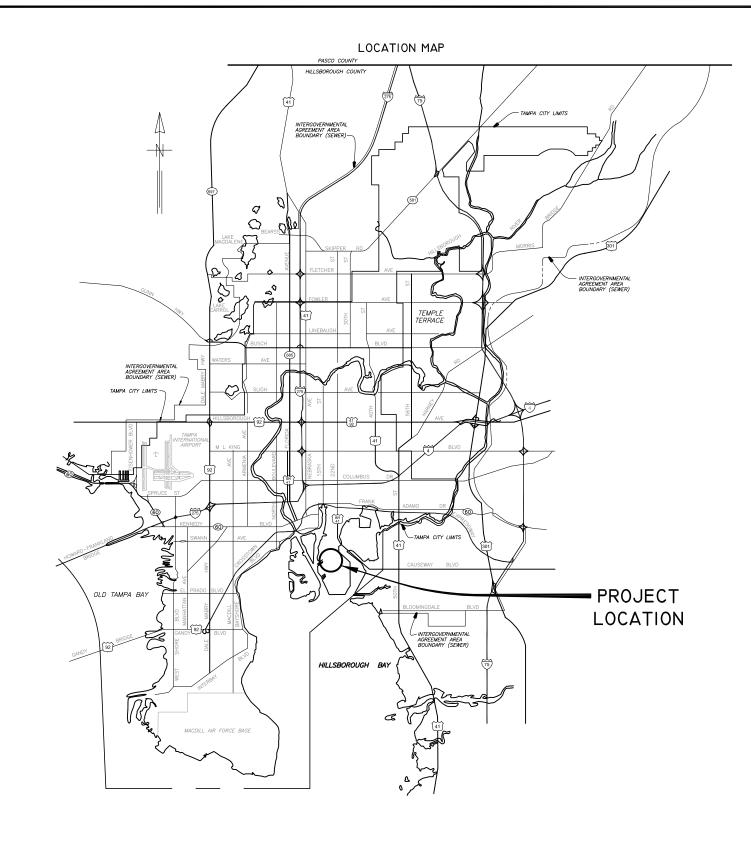

PLANS

FOR

CITY OF TAMPA FLORIDA WASTEWATER DEPRTMENT PHASE I

FOR
THE CONSTRUCTION OF THE

HOWARD F. CURREN AWTP LARGE MOTOR SOFTSTART ADDITIONS

> CONTRACT: 13-C-00035 AUGUST 2013





777 S. Harbour Island Blvd, Suite 870 Tampa, FL 33602 813.227.9190 Certificate of Authorization No. 8363

SHEET No.	SHEET TITLE
1	COVER SHEET
2	INDEX, SCHEDULES AND GENERAL NOTES
3	SITE PLAN FOR SOFTSTARTER ADDITIONS
E-1	ELECTRICAL LEGEND AND ABBREVIATIONS
E-2	JUNCTION CHAMBER NO. 1 : PARTIAL FLOOR PLAN
E-3	MAIN PUMPING STATION : PARTIAL FLOOR PLAN
E-4	FILTER BUILDING NO. 1 : PARTIAL FLOOR PLANS
E-5	FILTER BUILDING NO. 2 : PARTIAL FLOOR PLAN
E-6	JUNCTION CHAMBER NO. 1 : MCC-27A ELEVATION
E-7	JUNCTION CHAMBER NO. 1 : MCC-27B ELEVATION
E-8	MAIN PUMPING STATION : MCC-31 PARTIAL ELEVATION
E-9	FILTER BUILDING NO. 1 : MCC-57 ELEVATION
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E-11	JUNCTION CHAMBER NO. 1 : MCC-27A ONE-LINE DIAGRAM
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E-13	MAIN PUMPING STATION : MCC-31 ONE-LINE DIAGRAM
E-14	FILTER BUILDING NO. 1 : MCC-57 ONE-LINE DIAGRAM
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E-16	JUNCTION CHAMBER NO. 1 : JC-1-AB-1 & JC-1-AB-2 CONTROL SCHEMATICS
E-17	JUNCTION CHAMBER NO. 2 : JC-1-AB-3 & JC-1-AB-4 CONTROL SCHEMATICS
E-18	MAIN PUMPING STATION: MP-AB-2 & MP-AB-3 CONTROL SCHEMATICS
E-19	FILTER BUILDING NO. 1 : FB-BWB-1 & FB-BWB-2 CONTROL SCHEMATICS
E-20	FILTER BUILDING NO. 1 FB-BWB-1 & FB-BWB-2 MOTOR WIRING SCHEMATICS
E-21	FILTER BUILDING NO. 2 : FB-BWB-3, 4 & 5 CONTROL SCHEMATICS
E-22	JC-1-AB-1, JC-1-AB-2, JC-1-AB-3 & JC-1-AB-4 SOFTSTARTER DETAILS
E-23	MP-AB-2 AND MP-AB-3 SOFTSTARTER DETAILS
E-24	MOTOR FEEDER INFORMATION
	PROCESS AIR BLOWER CONTROL PANEL DETAILS

480V SOFTSTARTER ADDITION SCHEDULE							
MOTOR SIZE	VOLTAGE	FULL LOAD AMPS	TYPE OF LOAD	SERVICE	LOCATION	мсс	DESIGNATION
250	480	324	POSITIVE DISPLACEMENT	AIR BLOWER	JUNCTION CHAMBER NO. 1 - 002	MCC-27	JC-1-AB-1
250	480	324	POSITIVE DISPLACEMENT	AIR BLOWER	JUNCTION CHAMBER NO. 1 - 002	MCC-27	JC-1-AB-2
250	480	324	POSITIVE DISPLACEMENT	AIR BLOWER	JUNCTION CHAMBER NO. 1 - 002	MCC-27A	JC-1-AB-3
250	480	324	POSITIVE DISPLACEMENT	AIR BLOWER	JUNCTION CHAMBER NO. 1 - 002	MCC-27A	JC-1-AB-4
400	480	434	CENTRIFUGAL	MAIN PUMP AIR BLOWER	MAIN PUMPING STATION - 010	MCC-31	MP-AB-2
400	480	434	CENTRIFUGAL	MAIN PUMP AIR BLOWER	MAIN PUMPING STATION - 010	MCC-31	MP-AB-3
350	480	395	POSITIVE DISPLACEMENT	BACKWASH AIR BLOWER	FILTER BUILDING NO. 1 - 015	MCC-57	FB-BWB-1
350	480	395	POSITIVE DISPLACEMENT	BACKWASH AIR BLOWER	FILTER BUILDING NO. 1 - 015	MCC-57	FB-BWB-2
350	480	395	POSITIVE DISPLACEMENT	BACKWASH AIR BLOWER	FILTER BUILDING NO. 2 - 047	MCC-85	FB-BWB-3
350	480	395	POSITIVE DISPLACEMENT	BACKWASH AIR BLOWER	FILTER BUILDING NO. 2 - 047	MCC-85	FB-BWB-4
350	480	395	POSITIVE DISPLACEMENT	BACKWASH AIR BLOWER	FILTER BUILDING NO. 2 - 047	MCC-85	FB-BWB-5

GENERAL NOTES

SCALE

NOT TO SCALE

THE WORK CONSIST OF FURNISHING ALL LABOR, MATERIALS, EQUIPMENT, AND TECHNICAL SUPERVISION TO INSTALL NEW SOFTSTARTERS AND CAPACITORS AS INDICATED AND SHOWN. THE WORK INCLUDES, BUT IS NOT LIMITED TO, THE FOLLOWING:

- 1. CONTRACTOR SHALL SUBMIT SHOP DRAWINGS FOR APPROVAL PRIOR TO PURCHASING EQUIPMENT OR COMMENCING CONSTRUCTION.
- 2. CONTROL CONDUCTORS SHALL BE STRANDED COPPER, 14AWG MINIMUM, WITH XHHW INSULATION, UNLESS OTHERWISE NOTED.
- 3. ALL WIRING SHALL BE IDENTIFIED w/ NUMBERS AT ALL TERMINALS AND ON WIRING DIAGRAMS.
- 4. FIELD VERIFY ALL EQUIPMENT LOCATIONS AND CONNECTIONS PRIOR TO COMMENCING CONSTRUCTION.
- 5. ALL NEW EQUIPMENT SHALL BE PERMANENTLY IDENTIFIED WITH A BLACK ON WHITE LAMACOID TAG ENGRAVED WITH MINIMUM 3/16 INCH LETTERING.
- ALL CIRCUITS SHALL HAVE A GROUNDING CONDUCTOR ROUTED INSIDE EACH CONDUIT W/ POWER CONDUCTORS.
- . ALL CONDUCTOR LENGTHS SHALL BE CONTINUOUS, NO SPLICES OR CONDUCTOR TERMINATIONS SHALL BE PERMITTED UNLESS SPECIFICALLY DESIGNATED IN THE DRAWINGS.
- 8. ALL EXISTING INSTALLATIONS DENOTED ON THE DRAWINGS ARE FOR THE CONTRACTORS REFERENCE ONLY. ALL EXISTING INSTALLATIONS SHALL BE FIELD VERIFIED PRIOR TO SUBMITTING A BID AND PRIOR TO COMMENCING CONSTRUCTION.
- 9. CONDUITS SHALL BE RIGID HEAVY WALL ALUMINUM. FLEXIBLE CONDUITS SHALL BE NONMETALLIC LIQUID TIGHT.
- ALL MOTOR CONDUCTORS SHALL BE REPLACED (WITH THE EXCEPTION OF PROCESS BLOWER #1). THE EXISTING CONDUCTORS SHALL BE REMOVED, AND REPLACED WITH NEW COPPER DLO CONDUCTORS AS INDICATED. PRIOR TO PULLING THE NEW CONDUCTORS, CLEAN THE EXISTING CONDUITS USING A SWAB, AND RUN A PROPERLY SIZED RUBBER SLUG MANDREL THROUGH THEM TO PROVE INTEGRITY AND SPREAD WIRE LUBRICANT. PRIOR TO MAKING FINAL CONNECTIONS, THE CONTRACTOR SHALL USE A MEGGER TO TEST THE INSULATION RESISTANCE OF THE INSTALLED CONDUCTORS (PHASE TO PHASE & PHASE TO GROUND-1000V FOR ONE MINUTE) AND RECORD VALUES.
- 11. MAKE MODIFICATIONS TO THE EXISTING MOTOR CONTROL CENTERS AS SHOWN AND SPECIFIED.
- 12. MAKE MODIFICATIONS TO THE EXISTING PROCESS AIR BLOWERS CONTROL PANEL AS SHOWN AND SPECIFIED.
- 13. PROVIDE AND INSTALL SOFTSTARTER, CABINET, CAPACITORS AND ASSOCIATED HARDWARE AS SHOWN AND SPECIFIED.
- 14. MAKE REQUIRED INTERCONNECTIONS BETWEEN MOTOR CONTROL CENTER COMPONENTS AND NEW SOFTSTARTER AS SHOWN AND SPECIFIED.
- 15. MAKE FINAL CONNECTIONS TO MOTORS USING NEW POWER COMPRESSION FITTINGS AND NON-METALLIC LIQUID-TIGHT FLEXIBLE CONDUIT AS NECESSARY.
- 16. PROVIDE AND INSTALL STAINLESS STEEL CHANNEL ERECTOR SYSTEMS TO MOUNT AND SUPPORT ENCLOSURES, BOXES, CONDUITS AND OTHER EQUIPMENT. ALL MOUNTING HARDWARE SHALL BE 316 SS.
- 17. ALL ELECTRICAL WORK SHALL BE PERFORMED IN ACCORDANCE WITH THE 2008 NATIONAL ELECTRICAL CODE (NEC) AND CHAPTER 5 OF THE CITY OF TAMPA CODE.
- 18. CONTRACTOR SHALL USE THE MOTOR DATA PROVIDED IN THE SPECIFICATIONS TO ESTABLISH THE PROGRAMMABLE PARAMETERS FOR THE NEW SOFTSTARTER. CONTRACTOR SHALL FULLY PROGRAM THE SOFTSTARTER PRIOR TO INITIAL START—UP OF THE SYSTEM TO AVOID UNEXPECTED OR HARMFUL OPERATION OF THE SYSTEM.
- 19. AFTER COMPLETING THE EQUIPMENT INSTALLATION AND PROGRAMMING TASKS, THE SYSTEM SHALL BE TESTED TO SHOW FUNCTIONALITY. IF NECESSARY, SOFTSTARTER PROGRAM PARAMETERS SHALL BE ADJUSTED TO ACHIEVE THE PROPER MOTOR STARTING AND STOPPING CHARACTERISTICS.
- 20. TEST AND START-UP REPORTS FOR THE MOTOR STARTER SYSTEM AND WIRE SHALL BE INCLUDED IN THE OPERATION AND MAINTENANCE (O&M) MANUALS PROVIDED UNDER THIS CONTRACT. ALL RELAY AND SOFTSTARTER SETTINGS SHALL BE TABULATED AND INCLUDED IN THE O&M MANUAL.




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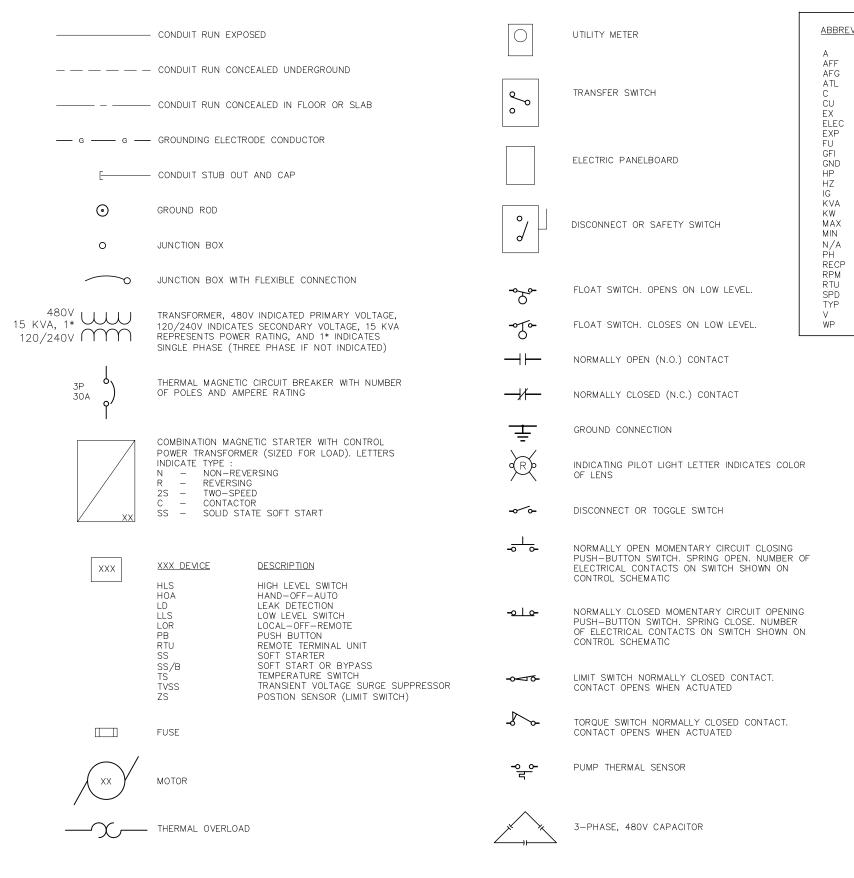
City of Tampa Wastewater Department
HOWARD F. CURREN AWTP

LARGE MOTOR SOFTSTART ADDITIONS

INDEX, SCHEDULES AND GENERAL NOTES


	SHEET NUMBER
	2
TIMOTHY THOMAS, P.E. No. 47079	FILE: 171301342E



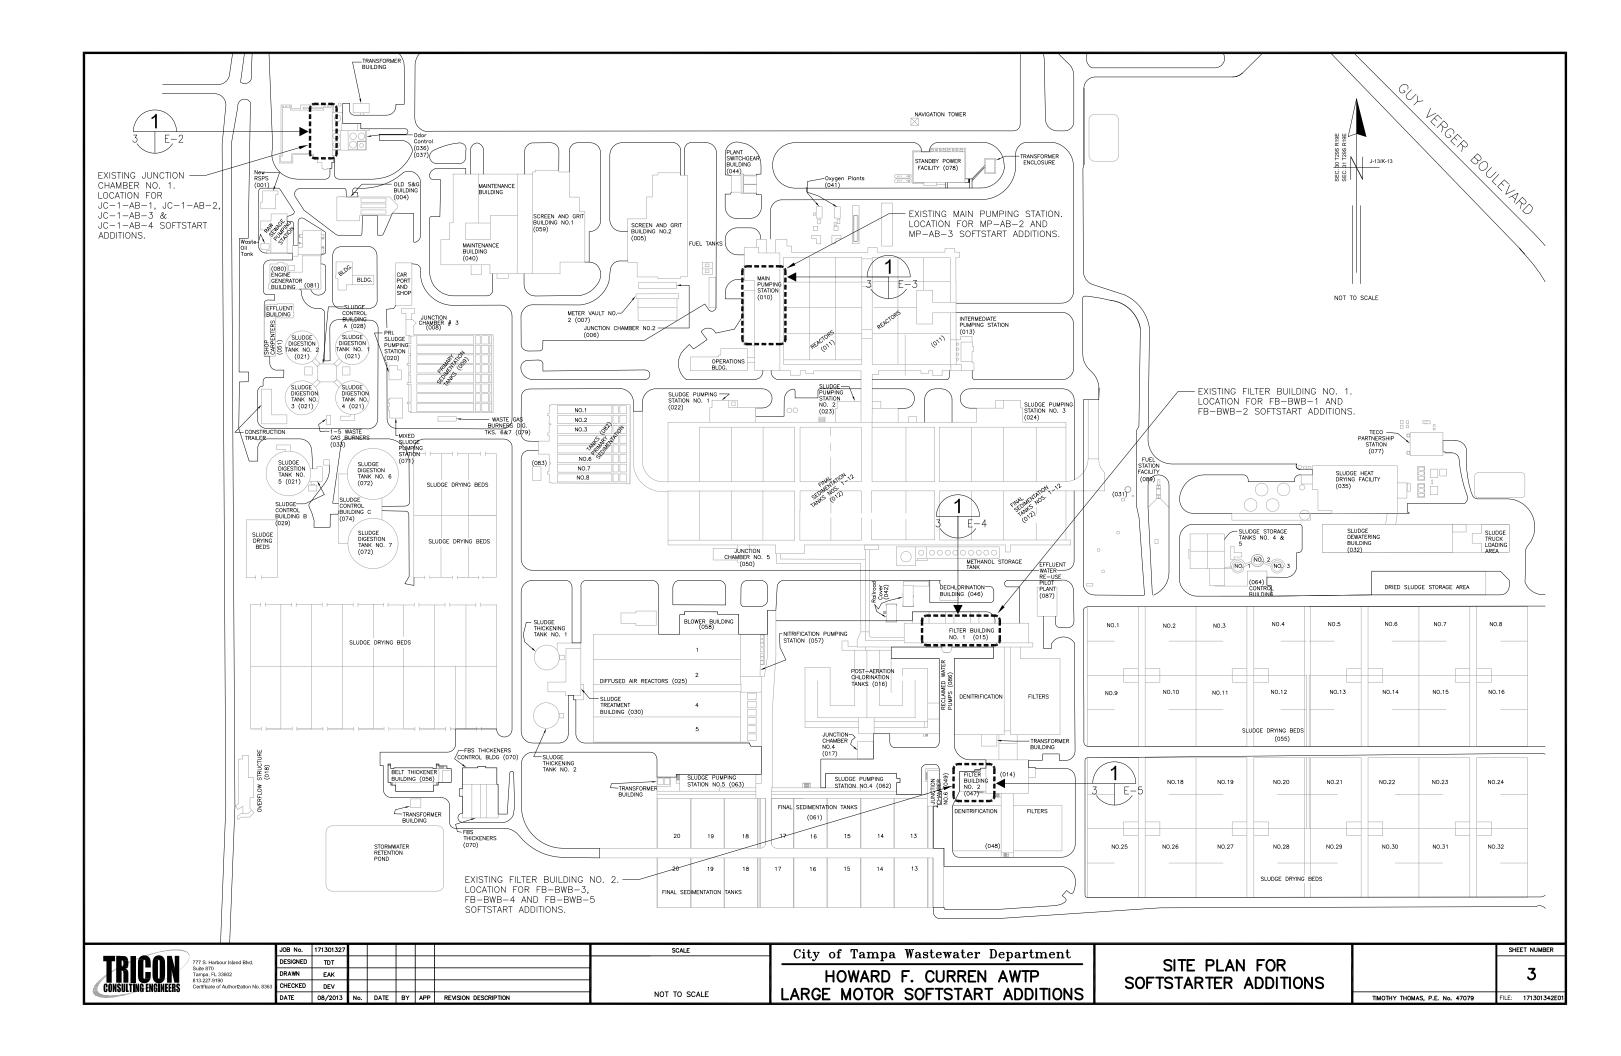

ABBREVIATIONS: ABOVE FINISHED FLOOR ABOVE FINISHED GRADE ACROSS-THE-LINE CONDUIT COPPER **EXISTING** FLECTRICAL EXPLOSION PROOF GROUND FAULT INTERRUPTER GROUNDING CONDUCTOR HORSEPOWER HFRT7 ISOLATED GROUND KILOVOLT AMPERES KILOWATTS MAXIMUM MINIMUM NOT APPLICABLE PHASE RECEPTACLE REVOLUTIONS PER MINUTE REMOTE TERMINAL UNIT SURGE PROTECTION DEVICE TYPICAL VOLTS

WEATHERPROOF

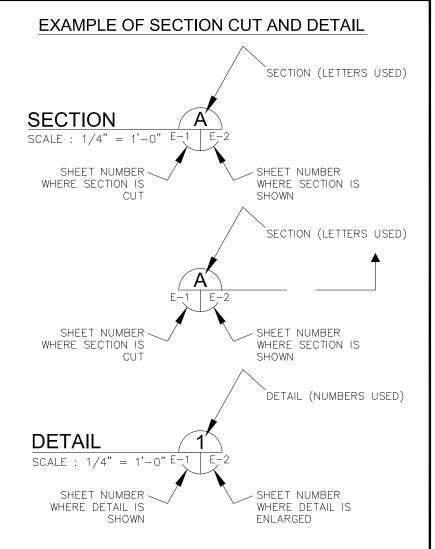



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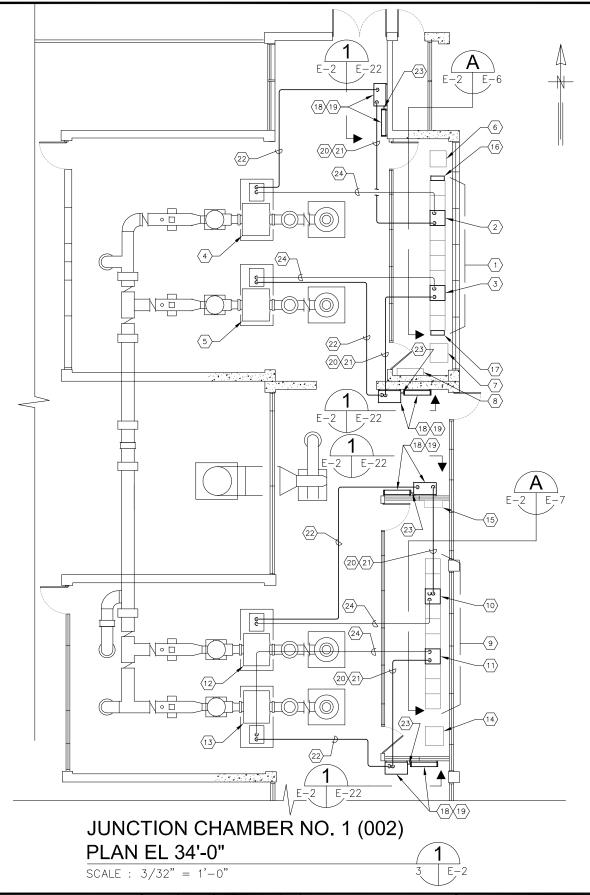
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HOWARD F. CURREN AWTP

SCALE

NOT TO SCALE

ELECTRICAL LEGE AND ABBREVIATION LARGE MOTOR SOFTSTART ADDITIONS

		SHEET NUMBER
END ONS		E-1
	TIMOTHY THOMAS, P.E. No. 47079	FILE: 171301342E01



KEYED NOTES:

- $| \hat{ } \rangle$ EXISTING MOTOR CONTROL CENTER : MCC-27A.
- 2 EXISTING SOFTSTARTER INSTALLED IN STARTER FOR AIR BLOWER JC-1-AB-4. EXISTING SOFTSTARTER TO BE REMOVED. REFER TO TYPICAL DETAILS ON SHEET E-6.
- (3) EXISTING ACROSS—THE—LINE STARTER FOR AIR BLOWER JC—1—AB—3. EXISTING ACROSS—THE—LINE STARTER TO BE REMOVED. REFER TO TYPICAL DETAILS ON SHEET E—6.
- $\overline{4}$ EXISTING 480V, 250 H.P. MOTOR FOR AIR BLOWER JC-1-AB-4.
- $\overline{5}$ EXISTING 480V, 250 H.P. MOTOR FOR AIR BLOWER JC-1-AB-3.
- (6) EXISTING H.V.A.C. EQUIPMENT. NO WORK REQUIRED.
- $\langle au
 angle$ existing combustible gas detector cabinet. No work required.
- 8) EXISTING CONTROL CABINET, JC-1-TCP-1. NO WORK REQUIRED.
- $\langle 9
 angle$ EXISTING MOTOR CONTROL CENTER : MCC-27.
- (10) EXISTING ACROSS—THE—LINE STARTER FOR AIR BLOWER JC—1—AB—2. EXISTING ACROSS—THE—LINE STARTER TO BE REMOVED. REFER TO TYPICAL DETAILS ON SHEET E—6.
- 11) EXISTING ACROSS—THE—LINE STARTER FOR AIR BLOWER JC—1—AB—1. EXISTING ACROSS—THE—LINE STARTER TO BE REMOVED. REFER TO TYPICAL DETAILS ON SHEET E—6.
- $\langle 12 \rangle$ EXISTING 480V, 250 H.P. MOTOR FOR AIR BLOWER JC-1-AB-2.
- $\langle 13 \rangle$ EXISTING 480V, 250 H.P. MOTOR FOR AIR BLOWER JC-1-AB-1.
- 14) EXISTING H.V.A.C. EQUIPMENT. NO WORK REQUIRED.
- 15) EXISTING CONTROL CABINET, JC-1-TCP-2. NO WORK REQUIRED.
- 16) EXISTING 480V, 30, 52.5 CAPACITOR FOR AIR BLOWER JC-1-AB-4. CAPACITOR TO BE REMOVED.
- (17) EXISTING 480V, 30, 52.5 KVAR CAPACITOR FOR AIR BLOWER JC-1-AB-3. CAPACITOR TO BE REMOVED.
- CONTRACTOR TO PROVIDE AND INSTALL NEW 480V, 590 AMPERE, 3—POLE SOFTSTARTER. REFER TO DETAIL ON SHEET E—22.
- CONTRACTOR TO PROVIDE AND INSTALL 480V, 3Ø, 65 KVAR CAPACITOR WITH INTEGRAL FUSING AND CONTACTOR. REFER TO DETAIL ON SHEET F-22
- CONTRACTOR TO PROVIDE AND INSTALL PARALLEL RUNS OF 3-#4/0 DLO CU + 1-#1/0 DLO CU IN 3" C. (WITH GROUND BUSHING) TO LINE SIDE OF SOFTSTARTER (FROM EXISTING CIRCUIT BREAKER).
- CONTRACTOR TO PROVIDE AND INSTALL 4-#12 XHHW CU + 1-#12 XHHW CU GND (2-#12 XHHW FROM STARTER CONTROL TRANSFORMER TO SOFTSTARTER FOR 120V POWER, 2-#12 XHHW FROM RESET PUSHBUTTON FOR SOFTSTARTER RESET) IN 3/4" C. (WITH GROUND BUSHING).
- 22) CONTRACTOR TO PROVIDE AND INSTALL PARALLEL RUNS OF 3-#4/O DLO CU + 1-#1/O DLO CU IN 3" C. (WITH GROUND BUSHING) FROM LOAD SIDE OF SOFTSTARTER TO EXISTING MOTOR.
- CONTRACTOR TO PROVIDE AND INSTALL 3-#1/O THWN CU + 1-#6 THWN CU GND IN 2" C. FOR POWER FACTOR CORRECTING CAPACITORS AND 2-#12 XHHW CU + 1-#12 XHHW CU GND IN 3/4" C. FOR CAPACITOR CONTACTOR CONTROL WIRING.
- 24) EXISTING MOTOR FEEDER (CONDUCTORS AND CONDUIT) TO BE REMOVED AND REPLACED. REFER TO SHEET E-24 FOR NEW CONDUCTOR/CONDUIT SIZES AND APPROXIMATE LENGTHS.

GENERAL NOTES:

 THE NEW 480V, 590 AMPERE, SOFTSTARTERS AND NEW 480V, 3Ø, 65 KVAR CAPACITORS SHALL BE PROVIDED IN NEMA 4X STAINLESS STEEL ENCLOSURES. (APPLIES ONLY TO SOFTSTARTERS AND CAPACITORS IN JUNCTION CHAMBER NO. 1)

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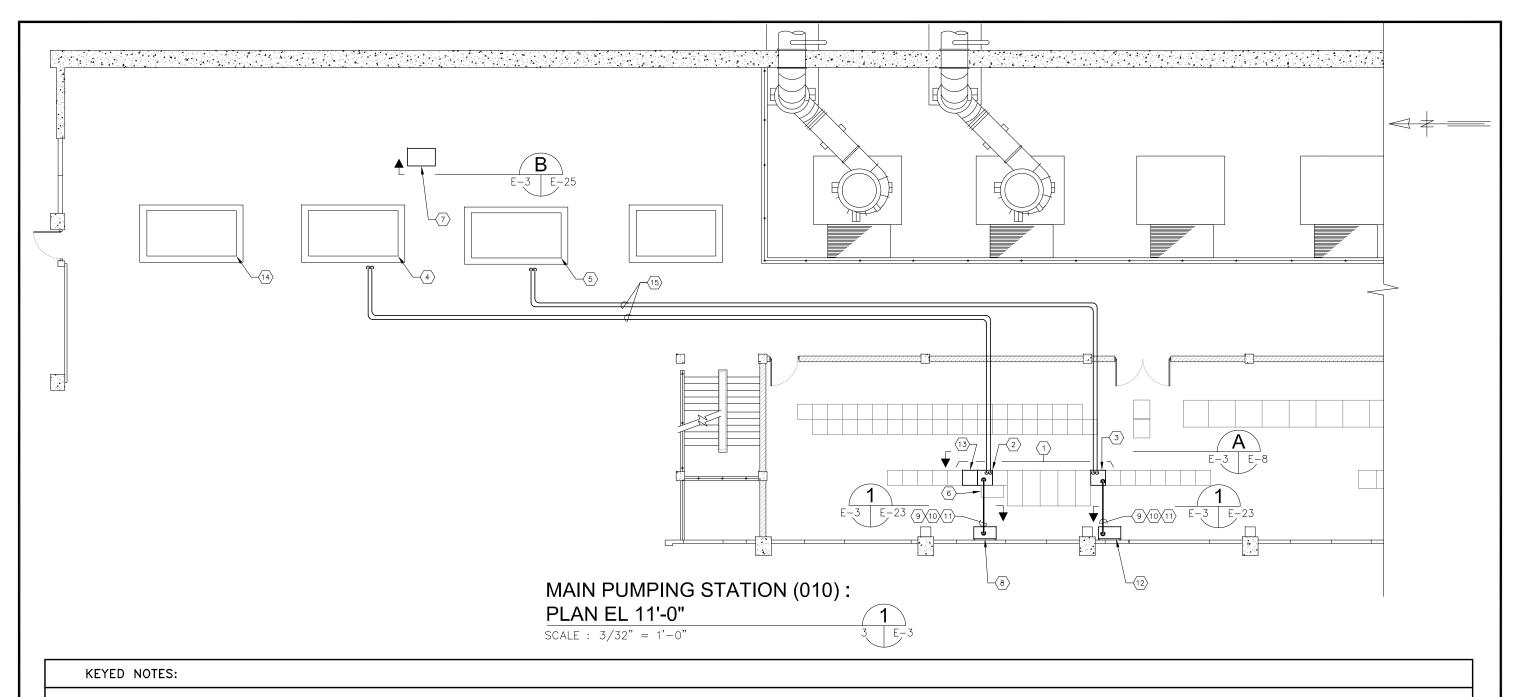
City of Tampa Wastewater Department

HOWARD F. CURREN AWTP
LARGE MOTOR SOFTSTART ADDITIONS

JUNCTION CHAMBER NO. 1
PARTIAL FLOOR PLAN

E-2

TIMOTHY THOMAS, P.E. No. 47079 FILE: 171301



- (1) EXISTING MOTOR CONTROL CENTER: MCC-31.
- (2) EXISTING ACROSS-THE-LINE STARTER FOR MAIN PUMP AIR BLOWER MP-AB-2. EXISTING ACROSS-THE-LINE STARTER TO BE REMOVED. REFER TO TYPICAL DETAILS ON SHEET E-8. (8)
- EXISTING ACROSS—THE—LINE STARTER FOR MAIN PUMP AIR BLOWER MP—AB—3. EXISTING ACROSS—THE—LINE STARTER TO BE REMOVED. REFER TO TYPICAL DETAILS ON SHEET E—8.
- $\overline{\langle 4 \rangle}$ EXISTING 480V, 400 H.P. MOTOR FOR AIR BLOWER MP-AB-2.
- $\langle 5 \rangle$ EXISTING 480V, 400 H.P. MOTOR FOR AIR BLOWER MP-AB-3.
- 6 EXISTING SOFTSTARTER FOR MAIN PUMP AIR BLOWER MP-AB-1. NEW CONDUCTORS TO BE INSTALLED FROM EXISTING CIRCUIT BREAKER. REFER ALSO TO SHEET E-8.
- (7) EXISTING PROCESS AIR BLOWER CONTROL PANEL. REFER TO SHEET E-25 FOR REQUIRED MODIFICATIONS.
- PROVIDE AND INSTALL NEW SOFTSTARTER FOR MP-AB-2. REFER TO DETAILS ON SHEET E-23.
- PROVIDE AND INSTALL PARALLEL RUNS OF: 3-373.7 KCMIL DLO CU + 1-#1/O DLO CU $\sqrt{14}$ EXISTING 480V, 400 H.P. MOTOR FOR AIR BLOWER MP-AB-1. GND IN 3-1/2" C. FROM CIRCUIT BREAKER TO LINE SIDE OF SOFTSTARTER.
- PROVIDE AND INSTALL PARALLEL RUNS OF : 3-373.7 KCMIL DLO CU + 1-#1/0 DLO CU GND IN 3-1/2" C. (SOFTSTARTER LOAD SIDE TO BLOWER MOTOR VIA MCC CUBICLE).
- CONTRACTOR TO PROVIDE AND INSTALL 4-#12 XHHW CU + 1-#12 XHHW CU GND (2-#12XHHW FROM STARTER CONTROL TRANSFORMER TO SOFTSTARTER FOR 120V POWER, 2-#12XHHW FROM RESET PUSHBUTTON FOR SOFTSTARTER RESET) IN 3/4" C. (WITH GROUND" BUSHING).
- 12 PROVIDE AND INSTALL NEW SOFTSTARTER FOR MP-AB-3. REFER TO DETAILS ON SHEET
- (13) EXISTING ACROSS—THE—LINE STARTER FOR MAIN PUMP AIR BLOWER MP—AB—1. EXISTING ACROSS-THE-LINE STARTER TO BE REMOVED. REFER TO TYPICAL DETAILS ON SHEET E-8.
- EXISTING MOTOR FEEDERS TO BE REPLACED. PROVIDE AND INSTALL PARALLEL RUNS OF 3-373.7 KCMIL DLO CU + 1-#1/0 DLO CU IN EXISTING 3-1/2" CONDUIT. EXISTING CONDUITS BELOW EL 11'-0" (HUNG ON CEILING OF EL 2'-0". REFER TO SHEET E-24 FOR CONDUCTOR/CONDUIT LENGTHS. (BLOWERS #2 AND #3 ONLY).

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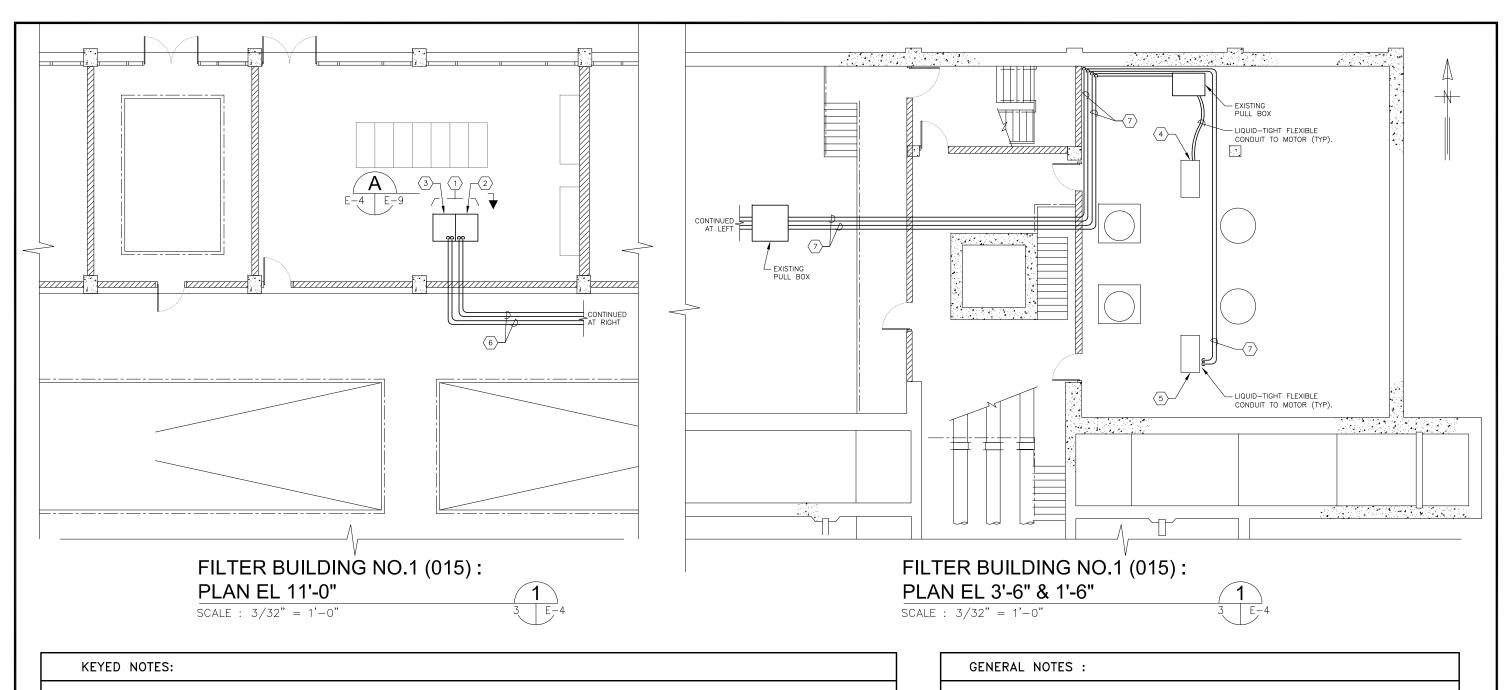
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HOWARD	F. CURREN	AWTP
LARGE MOTOR	SOFTSTART	ADDITIONS

MAIN	PUMPING	STATION
PAR	TIAL FLO	OR PLAN

	SHEET NUMBER
	E-3
MOTHY THOMAS DE No. 47070	CII C: 171301349E



- BACKWASH AIR BLOWER CONTROL CENTER: MCC-57. REFER ALSO TO SHEET E-9 FOR REQUIRED MODIFICATIONS.
- 2 EXISTING ACROSS—THE—LINE STARTER FOR FB—BWB—1 IN CUBICLE NO. 1. EXISTING ACROSS—THE—LINE STARTER TO BE REMOVED. PROVIDE AND INSTALL NEW SOFTSTARTER FOR FB—BWB—1. REFER TO TYPICAL DETAILS ON SHEET E—9.
- EXISTING ACROSS—THE—LINE STARTER FOR FB—BWB—2 IN CUBICLE NO. 2. EXISTING ACROSS—THE—LINE STARTER TO BE REMOVED. PROVIDE AND INSTALL NEW SOFTSTARTER FOR FB—BWB—2. REFER TO TYPICAL DETAILS ON SHEET E—9.
- 4 EXISTING 480V, 350 H.P. MOTOR FOR BACKWASH AIR BLOWER FB-BWB-1.

- $\fbox{5}$ EXISTING 480V, 350 H.P. MOTOR FOR BACKWASH AIR BLOWER FB-BWB-2.
- (6) EXISTING MOTOR FEEDERS TO BE REPLACED. PROVIDE AND INSTALL TWO (2) PARALLEL RUNS OF 3-313.3 KCMIL DLO CU + 1-#1/0 DLO CU IN EXISTING 3-1/2" CONDUIT. EXISTING CONDUITS BELOW EL 11'-0" (HUNG ON CEILING OF EL 3'-6". REFER TO SHEET E-24 FOR CONDUCTOR/CONDUIT LENGTHS.
- (2) EXISTING MOTOR FEEDERS TO BE REPLACED. PROVIDE AND INSTALL TWO
 (2) PARALLEL RUNS OF 3-313.3 KCMIL DLO CU + 1-#1/O DLO CU IN
 EXISTING 3-1/2" CONDUIT. CONDUITS SHOWN ARE AT EL 3'-6". REFER
 TO SHEET E-24 FOR CONDUCTOR/CONDUIT LENGTHS.
- 1. PROVIDE AND INSTALL THE FOLLOWING CONDUIT/CONDUCTORS FROM THE EXISTING CIRCUIT BREAKER TO THE NEW SOFTSTARTER:
 - a. PARALLEL RUNS OF : 3-313.3 KCMIL DLO CU (SOFTSTARTER LINE SIDE).
- 2. PROVIDE AND INSTALL THE FOLLOWING CONDUCTORS FROM THE NEW SOFTSTARTER TO THE EXISTING MOTOR (VIA EXISTING CUBICLE AND MOTOR FEEDER CONDUIT):
 - a. Parallel runs of : 3-313.3 kcmil dlo cu +1-#1/0 dlo cu gnd in existing 3-1/2" c. (contractor to field verify existing conduit size).

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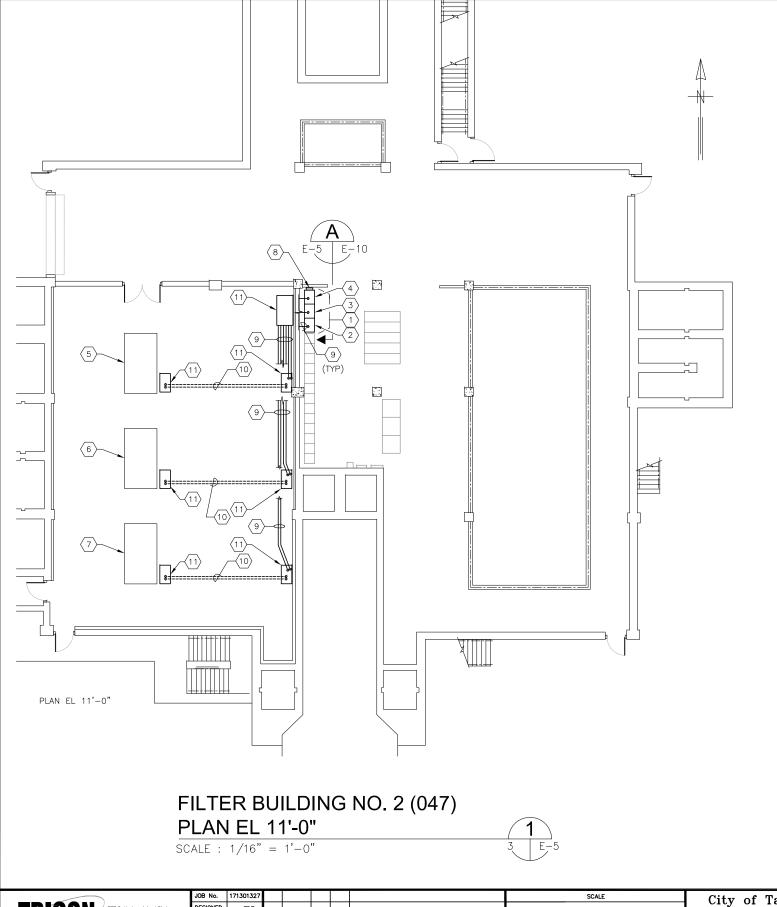
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City of Tampa Wastewater Department

HOWARD F. CURREN AWTP
LARGE MOTOR SOFTSTART ADDITIONS

FILTER BUILDING NO. 1 PARTIAL FLOOR PLANS

	SHEET NUMBER
	E-4
TIMOTHY THOMAS, P.E. No. 47079	FILE: 171301342E01



KEYED NOTES:


- 1) EXISTING MOTOR CONTROL CENTER: MCC-85.
- 2 EXISTING ACROSS—THE—LINE STARTER FOR AIR BLOWER FB—BWB—3. EXISTING ACROSS—THE—LINE STARTER TO BE REMOVED. PROVIDE AND INSTALL NEW SOFTSTARTER FOR FB—BWB—3. REFER TO TYPICAL DETAILS
- (3) EXISTING ACROSS—THE—LINE STARTER FOR AIR BLOWER FB—BWB—4. EXISTING ACROSS—THE—LINE STARTER TO BE REMOVED. PROVIDE AND INSTALL NEW SOFTSTARTER FOR FB—BWB—4. REFER TO TYPICAL DETAILS ON SHEET E-10.
- EXISTING ACROSS—THE—LINE STARTER FOR AIR BLOWER FB—BWB—5.
 EXISTING ACROSS—THE—LINE STARTER TO BE REMOVED. PROVIDE AND
 INSTALL NEW SOFTSTARTER FOR FB—BWB—5. REFER TO TYPICAL DETAILS ON SHEET E-10.
- $\left\langle \mathbf{5}\right\rangle$ EXISTING 480V, 350 H.P. MOTOR FOR AIR BLOWER FB-BWB-3.
- (6) EXISTING 480V, 350 H.P. MOTOR FOR AIR BLOWER FB-BWB-4.
- $\overline{\langle 7 \rangle}$ EXISTING 480V, 350 H.P. MOTOR FOR AIR BLOWER FB-BWB-5.
- (8) EXISTING CAPACITORS TO BE REMOVED.
- EXISTING MOTOR FEEDERS TO BE REPLACED. PROVIDE AND INSTALL TWO (2) PARALLEL RUNS OF 3-313.3 KCMIL DLO CU + 1-#1/0 DLO CU IN EXISTING 3" CONDUIT. REFER TO SHEET E-24 FOR CONDUCTOR/CONDUIT
- EXISTING MOTOR FEEDERS TO BE REPLACED. PROVIDE AND INSTALL TWO (2) PARALLEL RUNS OF 3-313.3 KCMIL DLO CU + 1-#1/0 DLO CU IN EXISTING 3" CONDUIT. EXISTING CONDUIT IS INSTALLED IN CONCRETE SLAB.
- (11) EXISTING PULL BOX.

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City of Tampa Wastewater Department

HOWARD F. CURREN AWTP LARGE MOTOR SOFTSTART ADDITIONS FILTER BUILDING NO. 2 PARTIAL FLOOR PLAN

SHEET NUMBER E-5 TIMOTHY THOMAS, P.E. No. 47079

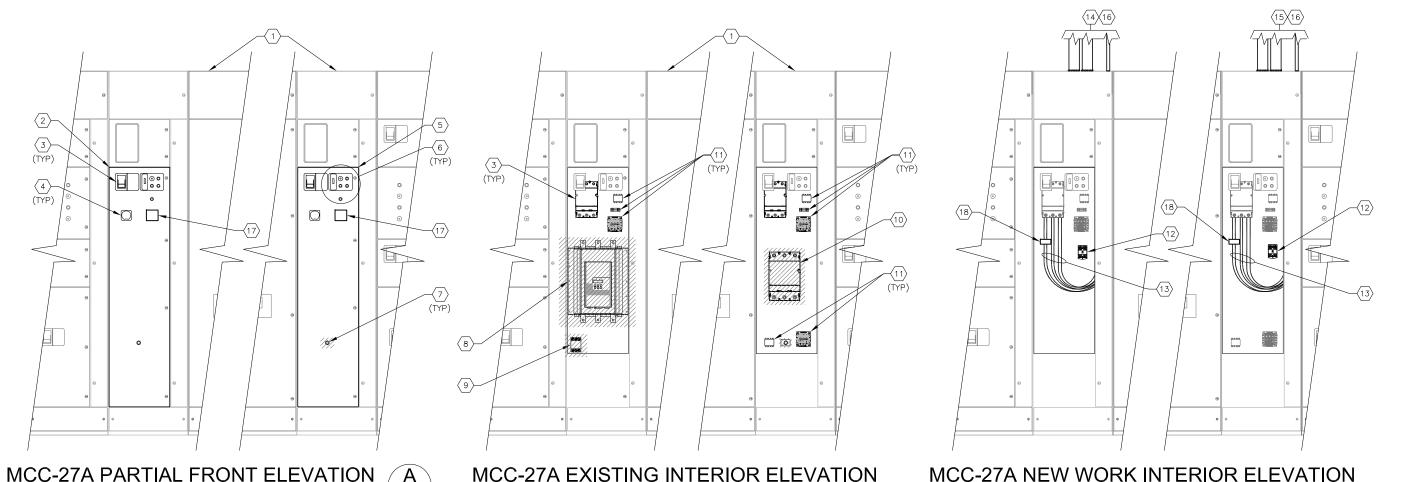

SCALE: N.T.S.

MCC-27A EXISTING INTERIOR ELEVATION

KEYED NOTES:

- EXISTING MOTOR CONTROL CENTER: MCC-27A.
- EXISTING STARTER CUBICLE FOR JC-1-AB-4. SOFTSTARTER SHALL BE REMOVED AND NEW SOFTSTARTER SHALL BE INSTALLED PER SHEET E-2.
- EXISTING 500A, 3-POLE CIRCUIT BREAKER. NO WORK REQUIRED.
- EXISTING ELAPSED TIME METER. NO WORK REQUIRED.
- $\langle 5 \rangle$ EXISTING STARTER CUBICLE FOR JC-1-AB-3.
- EXISTING PILOT LIGHTS FOR MOTOR ON AND LOCKOUT TRIPPED; LOCKOUT RELAY RESET PUSHBUTTON; MOTOR START PUSHBUTTON; MOTOR STOP PUSHBUTTON; AND GROUND FAULT RESET SWITCH. GROUND FAULT RESET SWITCH TO BE REMOVED. REFER TO SHEET E-16 FOR RESET PUSHBUTTON
- EXISTING RESET PUSHBUTTON FOR STARTER. PUSHBUTTON TO BE REMOVED. CONTRACTOR TO PROVIDE BLANK COVER.
- EXISTING SOFTSTARTER FOR JC-1-AB-4 TO BE REMOVED.
- $\langle 9 \rangle$ EXISTING CONTACTOR FOR JC-1-AB-4 CAPACITOR TO BE REMOVED.
- EXISTING ACROSS—THE—LINE STARTER FOR AIR BLOWER JC—1—AB—3 TO BE REMOVED.
- EXISTING CONTROL POWER TRANSFORMER, FUSES, TERMINAL BLOCKS, RELAYS, ETC., TO REMAIN (WITH THE EXCEPTION OF OVERLOAD RESET).

(12) CONTRACTOR TO PROVIDE AND INSTALL NEW INDUSTRIAL CONTROL RELAY (SQUARE-D CLASS 8501 TYPE X OR EQUAL). 120V COIL, NUMBER OF CONTACTS AS REQUIRED.

SCALE: N.T.S.

- CONTRACTOR TO PROVIDE AND INSTALL PARALLEL RUNS OF 3-#4/0 DLO CU + 1-#1/0 DLO CU FROM EXISTING CIRCUIT BREAKER TO LINE SIDE OF NEW SOFTSTARTER.
- (14) CONTRACTOR TO PROVIDE AND INSTALL PARALLEL RUNS OF 3-#4/0 DLO CU + 1-#1/0 DLO CU IN 3" C. (WITH GROUND BUSHING) FROM EXISTING JC-1-AB-4 CIRCUIT BREAKER TO LINE SIDE OF NEW SOFTSTARTER.
- (15) CONTRACTOR TO PROVIDE AND INSTALL PARALLEL RUNS OF 3-#4/0 DLO CU + 1-#1/0 DLO CU IN 3" C. (WITH GROUND BUSHING) FROM EXISTING JC-1-AB-3 CIRCUIT BREAKER TO LINE SIDE OF NEW SOFTSTARTER.
- $\langle 16 \rangle$ CONTRACTOR TO PROVIDE AND INSTALL 8-#12 XHHW CU + 1-#12 XHHW CU GND (2-#12 STARTER CONTROL TRANSFORMER TO SOFTSTARTER FOR 120V POWER, 2-#12 FROM RESET PUSHBUTTON FOR SOFTSTARTER RESET, 2-#12 RUN COMMAND, 2-#12 SOFTSTARTER FAULT) IN 3/4" C. (WITH GROUND BUSHING).
- CONTRACTOR TO PROVIDE AND INSTALL NEW AMMETER FOR MOTOR CIRCUIT. 0-5 AMP INPUT WITH 0-500 AMP SCALE. SIMPSON MODEL 01450-Z59MD. REFER ALSO TO SHEETS E-11 AND E-16.

CONTRACTOR TO PROVIDE AND INSTALL NEW CURRENT TRANSFORMER (CT) FOR NEW AMMETER IN NOTE 17. 500:5 CT RATIO TO ACCOMODATE NEW AMMETER PROVIDED. REFER ALSO TO SHEETS E-11 AND E-16.


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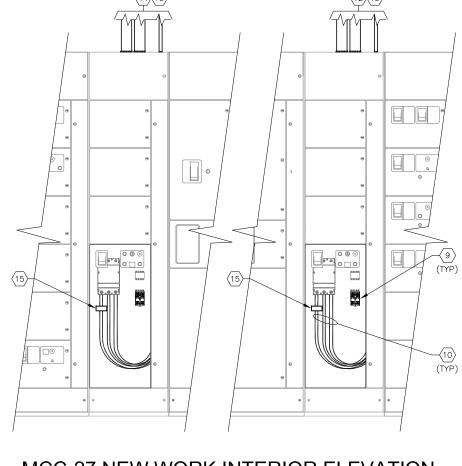
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City of Tampa Wastewater Department

HOWARD F. CURREN AWTP LARGE MOTOR SOFTSTART ADDITIONS JUNCTION CHAMBER NO. 1 MCC-27A ELEVATION

SHEET NUMBER E-6 FILE: 171301342E0 TIMOTHY THOMAS, P.E. No. 47079



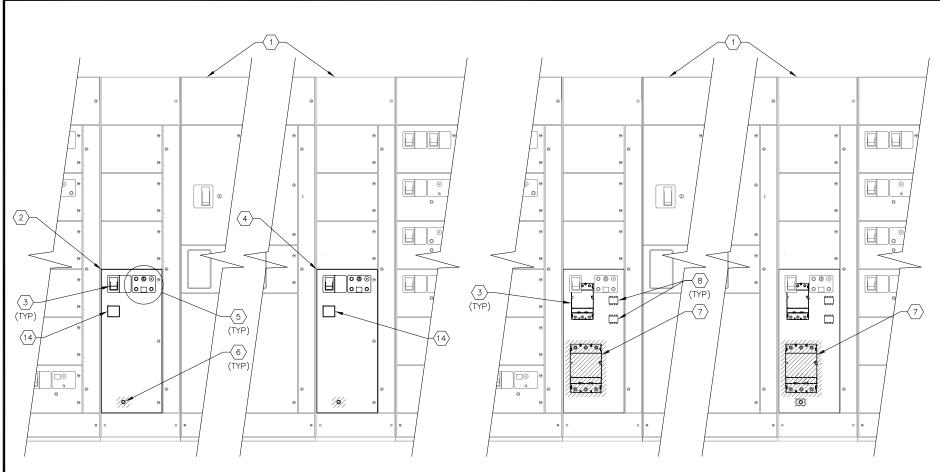

MCC-27 PARTIAL FRONT ELEVATION

SCALE : N.T.S.



MCC-27 EXISTING INTERIOR ELEVATION

SCALE : N.T.S.

MCC-27 NEW WORK INTERIOR ELEVATION

SCALE : N.T.S.

KEYED NOTES:

- $\langle 1 \rangle$ EXISTING MOTOR CONTROL CENTER : MCC-27.
- 2 EXISTING STARTER CUBICLE FOR JC-1-AB-2.
- (3) EXISTING 500A, 3-POLE CIRCUIT BREAKER. NO WORK REQUIRED.
- $\overline{4}$ EXISTING STARTER CUBICLE FOR JC-1-AB-1.
- (5) EXISTING PILOT LIGHTS FOR MOTOR ON AND LOCKOUT TRIPPED; LOCKOUT RELAY RESET PUSHBUTTON; MOTOR START PUSHBUTTON; MOTOR STOP PUSHBUTTON; AND GROUND FAULT RESET SWITCH. GROUND FAULT RESET SWITCH TO BE REMOVED. REFER TO SHEET E-17 FOR RESET PUSHBUTTON MODIFICATIONS.
- (6) EXISTING RESET PUSHBUTTON FOR STARTER. PUSHBUTTON TO BE REMOVED. CONTRACTOR TO PROVIDE BLANK COVER.
- (7) EXISTING ACROSS-THE-LINE STARTER FOR AIR BLOWER TO BE REMOVED.
- (8) EXISTING CONTROL POWER TRANSFORMER, FUSES, TERMINAL BLOCKS, RELAYS, ETC., TO REMAIN (WITH THE EXCEPTION OF OVERLOAD RESET).
- 9 CONTRACTOR TO PROVIDE AND INSTALL NEW INDUSTRIAL CONTROL RELAY (SQUARE-D CLASS 8501 TYPE X OR EQUAL). 120V COIL, NUMBER OF CONTACTS AS REQUIRED.

- (10) CONTRACTOR TO PROVIDE AND INSTALL PARALLEL RUNS OF 3-#4/0 DLO CU + 1-#1/0 DLO CU FROM EXISTING CIRCUIT BREAKER TO LINE SIDE OF NEW SOFTSTARTER
- (11) CONTRACTOR TO PROVIDE AND INSTALL PARALLEL RUNS OF 3-#4/0 DLO CU + 1-#1/0 DLO CU IN 3" C. (WITH GROUND BUSHING) FROM EXISTING JC-1-AB-2 CIRCUIT BREAKER TO LINE SIDE OF NEW SOFTSTARTER.
- (12) CONTRACTOR TO PROVIDE AND INSTALL PARALLEL RUNS OF 3-#4/0 DLO CU + 1-#1/0 DLO CU IN 3" C. (WITH GROUND BUSHING) FROM EXISTING JC-1-AB-1 CIRCUIT BREAKER TO LINE SIDE OF NEW SOFTSTARTER.
- CONTRACTOR TO PROVIDE AND INSTALL 8-#12 XHHW CU + 1-#12 XHHW CU GND (2-#12 STARTER CONTROL TRANSFORMER TO SOFTSTARTER FOR 120V POWER, 2-#12 FROM RESET PUSHBUTTON FOR SOFTSTARTER RESET, 2-#12 RUN COMMAND, 2-#12 SOFTSTARTER FAULT) IN 3/4° C. (WITH GROUND BUSHING).
- CONTRACTOR TO PROVIDE AND INSTALL NEW AMMETER FOR MOTOR CIRCUIT. 0-5 AMP INPUT WITH 0-500 AMP SCALE. SIMPSON MODEL 01450-Z59MD. REFER ALSO TO SHEETS E-12 AND E-17.
- CONTRACTOR TO PROVIDE AND INSTALL NEW CURRENT TRANSFORMER (CT) FOR NEW AMMETER IN NOTE 14. 500:5 CT RATIO TO ACCOMODATE NEW AMMETER PROVIDED. REFER ALSO TO SHEETS E-12 AND E-17.

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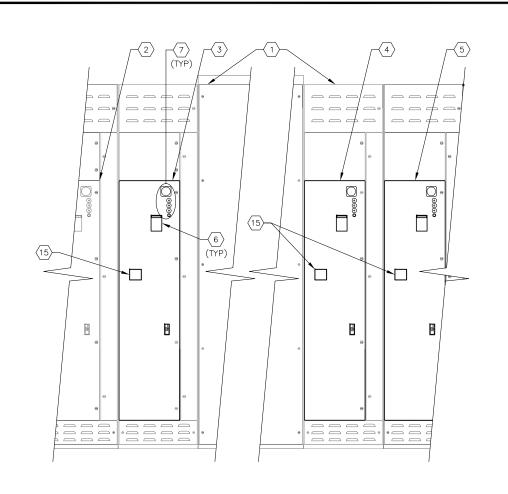
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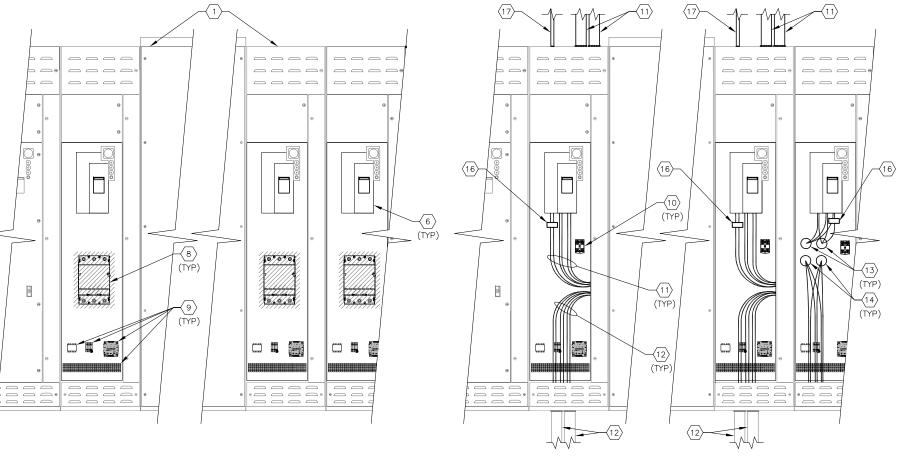
City of Tampa Wastewater Department

HOWARD F. CURREN AWTP
LARGE MOTOR SOFTSTART ADDITIONS

JUNCTION CHAMBER NO. 1 MCC-27 ELEVATION

	Sheet Number
	E-7
TIMOTHY THOMAS, P.E. No. 47079	FILE: 171301342E01





MCC-31 PARTIAL FRONT ELEVATION

SCALE · NITS



MCC-31 EXISTING INTERIOR ELEVATION

SCALE: N.T.S.

MCC-31 NEW WORK INTERIOR ELEVATION

SCALE: N.T.S.

KEYED NOTES:

- $\langle 1 \rangle$ EXISTING MOTOR CONTROL CENTER: MCC-31.
- \$\langle 2 \rangle SPACE FOR FUTURE MP-AB-4 STARTER.
- 3 EXISTING ACROSS-THE-LINE STARTER FOR MP-AB-3 TO BE REMOVED.
- $\langle 4 \rangle$ EXISTING ACROSS-THE-LINE STARTER FOR MP-AB-2 TO BE REMOVED.
- (5) EXISTING ACROSS-THE-LINE STARTER FOR MP-AB-1. SOFTSTARTER FOR MP-AB-1 HAS PREVIOUSLY BEEN INSTALLED. CONTRACTOR SHALL REMOVE EXISITING ACROSS-THE-LINE STARTER FOR MP-AB-1.
- (6) EXISTING 600A, 3-POLE CIRCUIT BREAKER. NO WORK REQUIRED.
- 7) EXISTING PILOT LIGHTS FOR MOTOR OFF, MOTOR RUNNING AND LOR TRIPPED; LOCKOUT RELAY RESET PUSHBUTTON AND ELAPSED TIME METER. REFER TO SHEET E-18 FOR LOR RESET PUSHBUTTON MODIFICATIONS REQUIRED.
- $\langle 8 \rangle$ EXISTING ACROSS-THE-LINE STARTER FOR AIR BLOWER TO BE REMOVED.
- 9 EXISTING CONTROL POWER TRANSFORMER, FUSES, TERMINAL BLOCKS, RELAYS, ETC., TO REMAIN (WITH THE EXCEPTION OF OVERLOAD RESET AND GROUND SENSING RELAY).

- CONTRACTOR TO PROVIDE AND INSTALL NEW INDUSTRIAL CONTROL RELAY (SQUARE-D CLASS 8501 TYPE X OR EQUAL). 120V COIL, NUMBER OF CONTACTS AS REQUIRED.
- (11) CONTRACTOR TO PROVIDE AND INSTALL TWO (2) NEW PARALLEL RUNS OF 3-373.7 KCMIL DLO CU + 1-#1/O DLO CU GND IN 3-1/2" CONDUIT (WITH GROUND BUSHING) FROM EXISTING CIRCUIT BREAKER TO NEW SOFTSTARTER (STARTERS MP-AB-2 AND MP-AB-3).
- CONTRACTOR TO PROVIDE AND INSTALL TWO (2) NEW PARALLEL RUNS OF 3-373.7 KCMIL DLO CU + 1-#1/O DLO CU GND IN EXISTING CONDUIT FROM NEW SOFTSTARTER (STARTERS MP-AB-2 AND MP-AB-3) TO ASSOCIATED AIR BLOWER MOTOR VIA EXISTING CUBICLE.
- CONTRACTOR TO PROVIDE AND INSTALL TWO (2) NEW PARALLEL RUNS OF 3-373.7 KCMIL DLO CU + 1-#1/O DLO CU GND IN EXISTING CONDUIT FROM EXISTING CIRCUIT BREAKER TO EXISTING SOFTSTARTER (STARTER MP-AB-1).
- EXISTING PARALLEL RUNS OF 3-373.7 KCMIL DLO CU + 1-#1/0 DLO CU GND IN EXISTING CONDUIT TO MP-AB-1 BLOWER MOTOR. NO WORK REQUIRED.

- CONTRACTOR TO PROVIDE AND INSTALL NEW AMMETER FOR MOTOR CIRCUIT. 0-5 AMP INPUT WITH 0-500 AMP SCALE. SIMPSON MODEL 01450-Z59MD. REFER ALSO TO SHEETS E-13, E-18 AND E-25.
- CONTRACTOR TO PROVIDE AND INSTALL NEW CURRENT TRANSFORMER (CT) FOR NEW AMMETER IN NOTE 15. 500:5 CT RATIO TO ACCOMODATE NEW AMMETER PROVIDED. REFER ALSO TO SHEETS E-13, E-18 AND E-25.
- CONTRACTOR TO PROVIDE AND INSTALL 8-#12 XHHW CU + 1-#12 XHHW CU GND (2-#12 STARTER CONTROL TRANSFORMER TO SOFTSTARTER FOR 120V POWER, 2-#12 FROM RESET PUSHBUTTON FOR SOFTSTARTER RESET, 2-#12 RUN COMMAND, 2-#12 SOFTSTARTER FAULT) IN 3/4" C. (WITH GROUND BUSHING). STARTERS MP-AB-2 AND MP-AB-3 ONLY.

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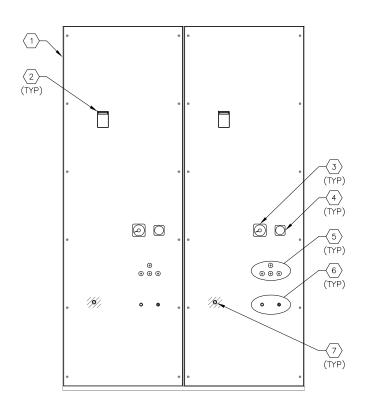
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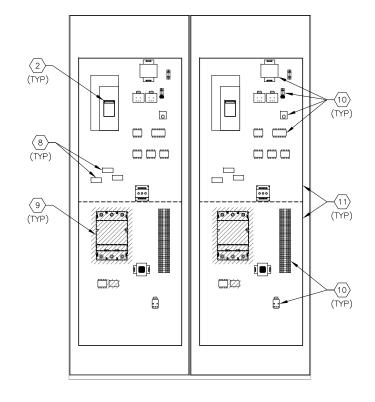
City of Tampa Wastewater Department


HOWARD F. CURREN AWTP LARGE MOTOR SOFTSTART ADDITIONS

MAIN PUMPING STATION MCC-31 PARTIAL ELEVATION

	SHEET NUMBER
	E-8
TIMOTHY THOMAS, P.E. No. 47079	FILE: 171301342E01





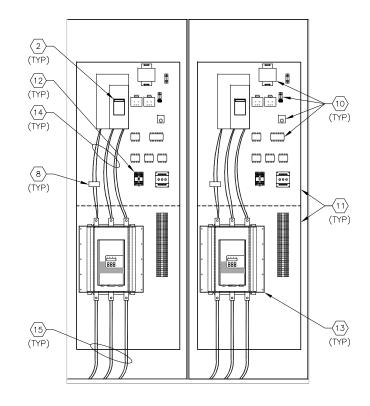

MCC-57 FRONT ELEVATION SCALE: N.T.S.

MCC-57 EXISTING INTERIOR ELEVATION

SCALE: N.T.S.

MCC-57 NEW WORK INTERIOR ELEVATION

SCALE: N.T.S.

KEYED NOTES:

- $\langle 1 \rangle$ EXISTING MOTOR CONTROL CENTER: MCC-57.
- EXISTING 1200A, 3-POLE CIRCUIT BREAKER. NO WORK REQUIRED.
- EXISTING AMPERE METER. NO WORK REQUIRED.
- EXISTING ELAPSED TIME METER. NO WORK REQUIRED.
- EXISTING PILOT LIGHTS FOR MOTOR ON, MOTOR OFF, LOR TRIPPED AND MOTOR IN SERVICE. NO WORK REQUIRED.
- EXISTING PUSHBUTTON FOR LOCKOUT RELAY RESET AND SELECTOR SWITCH FOR OFF-TEST-AUTO. REFER TO SHEET E-19 FOR LOR RESET PUSHBUTTON MODIFICATIONS REQUIRED.
- EXISTING RESET PUSHBUTTON FOR STARTER. PUSHBUTTON TO BE REMOVED. CONTRACTOR TO PROVIDE BLANK COVER.
- CONTRACTOR TO REUSE ONE (1) OF THE EXISTING CT'S IN NOTE #8 FOR THE EXISTING AMMETER IN NOTE #3. REMAINING CT'S SHALL BE SHORTED
- EXISTING ACROSS-THE-LINE STARTER FOR BACKWASH AIR BLOWER TO BE

- EXISTING CONTROL POWER TRANSFORMER, FUSES, TERMINAL BLOCKS, RELAYS, ETC., TO BE RELOCATED AS REQUIRED TO ACCOMMODATE NEW
- EXISTING BACKPLATE FOR MOTOR STARTER. BACKPLATE SHALL BE MODIFIED TO ALLOW NEW SOFTSTARTER TO BE INSTALLED AT APPROPRIATE DEPTH.
- CONTRACTOR TO PROVIDE AND INSTALL NEW INDUSTRIAL CONTROL RELAY (SQUARE-D CLASS 8501 TYPE X OR EQUAL). 120V COIL, NUMBER OF
- (13) CONTRACTOR TO PROVIDE AND INSTALL NEW 480V, 590 AMPERE, 3-POLE SOFTSTARTER.
- CONTRACTOR TO PROVIDE AND INSTALL TWO PARALLEL RUNS OF 3-313.3 KCMIL DLO CU FROM EXISTING CIRCUIT BREAKER TO NEW SOFTSTARTER.
- CONTRACTOR TO PROVIDE AND INSTALL TWO PARALLEL RUNS OF 3-313.3 KCMIL DLO CU + 1-#1/O DLO CU GND IN EXISTING CONDUIT TO EXISTING BACKWASH AIR BLOWER

GENERAL NOTES:

SOFTSTARTER DIMENSIONS ARE BASED ON A SPECIFIC MANUFACTURER USED FOR THE BASIS OF DESIGN. THE CONTRACTOR SHALL BE RESPONSIBLE FOR VERIFYING ADAQUATE SPACE IS AVAILABLE WITHIN MCC-57 TO ACCOMMODATE THE SOFTSTARTER SELECTED/PROVIDED PRIOR TO COMMENCING CONSTRUCTION. IF THE CONTRACTOR DETERMINES THAT THE SOFTSTARTER TO BE PROVIDED CANNOT BE INSTALLED WITHIN MCC-57, THE CONTRACTOR SHALL PROVIDE THE SOFTSTARTER WITHIN AN EXTERIOR ENCLOSURE AS DETAILED ON SHEET E-23. THE CONTRACTOR SHALL COORDINATE THE LOCATION OF THE EXTERIOR ENCLOSURE WITH THE CITY AND PROVIDE ALL NECESSARY CONDUIT AND CONDUCTORS REQUIRED FOR THE EXTERIOR ENCLOSURE AT NO COST TO THE CITY.


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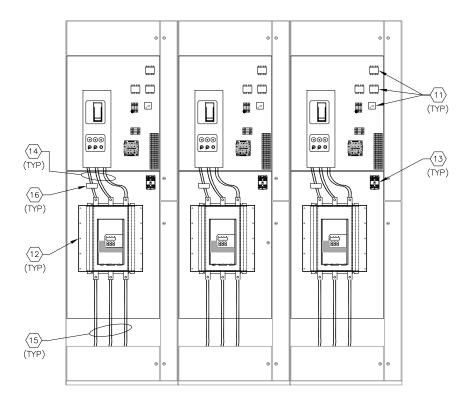
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City of Tampa Wastewater Department

HOWARD F. CURREN AWTP LARGE MOTOR SOFTSTART ADDITIONS FILTER BUILDING NO. 1 MCC-57 ELEVATION

SHEET NUMBER E-9 TIMOTHY THOMAS, P.E. No. 47079 FILE: 171301342E0



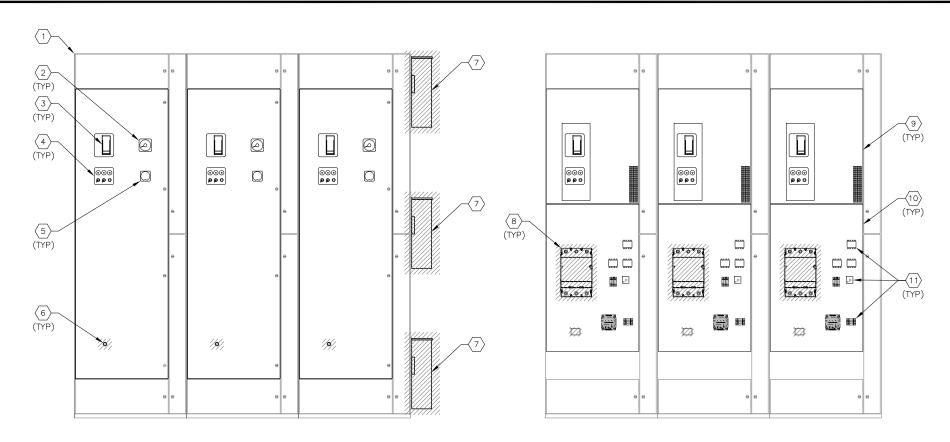

MCC-85 FRONT ELEVATION A SCALE : N.T.S. E-5 E-10

MCC-85 EXISTING INTERIOR ELEVATION

SCALE · NITS

KEYED NOTES:

- (1) EXISTING MOTOR CONTROL CENTER: MCC-85.
- $\langle 2 \rangle$ EXISTING AMMETER. CONNECT TO NEW CT (NOTE #16).
- (3) EXISTING 600A, 3-POLE CIRCUIT BREAKER. NO WORK REQUIRED.
- EXISTING PILOT LIGHTS FOR MOTOR ON, MOTOR OFF, LOR TRIPPED; LOCKOUT RELAY RESET PUSHBUTTON; AND SELECTOR SWITCHES FOR OFF-TEST-AUTO AND MOTOR START/STOP. REFER TO SHEET E-21 FOR LOR RESET PUSHBUTTON MODIFICATIONS REQUIRED.
- $\left\langle 5\right\rangle$ EXISTING ELAPSED TIME METER. NO WORK REQUIRED.
- 6) EXISTING RESET PUSHBUTTON FOR STARTER. PUSHBUTTON TO BE REMOVED. CONTRACTOR TO PROVIDE BLANK COVER.
- (7) EXISTING CAPACITOR FOR BACKWASH AIR BLOWER TO BE REMOVED.
- (8) EXISTING ACROSS—THE—LINE STARTER FOR BACKWASH AIR BLOWER TO BE REMOVED.
- EXISTING BACKPLATE FOR BACKWASH AIR BLOWER CIRCUIT BREAKER. NO WORK REQUIRED.
- (10) EXISTING BACKPLATE FOR MOTOR STARTER. BACKPLATE SHALL BE MODIFIED TO ALLOW NEW SOFTSTARTER TO BE INSTALLED AT APPROPRIATE DEPTH.

- 11) EXISTING CONTROL POWER TRANSFORMER, FUSES, TERMINAL BLOCKS, RELAYS, ETC., TO BE RELOCATED AS REQUIRED TO ACCOMMODATE NEW SOFTSTARTER
- CONTRACTOR TO PROVIDE AND INSTALL NEW 480V, 590 AMPERE, 3-POLE SOFTSTARTER.
- CONTRACTOR TO PROVIDE AND INSTALL NEW INDUSTRIAL CONTROL RELAY

 (SQUARE-D CLASS 8501 TYPE X OR EQUAL). 120V COIL, NUMBER OF
 CONTACTS AS REQUIRED.
- CONTRACTOR TO PROVIDE AND INSTALL TWO PARALLEL RUNS OF 3-313.3 KCMIL DLO CU FROM EXISTING CIRCUIT BREAKER TO NEW SOFTSTARTER.
- 15) CONTRACTOR TO PROVIDE AND INSTALL TWO PARALLEL RUNS OF 3-313.3 KCMIL DLO CU + 1-#1/O THWN CU GND. IN EXISTING CONDUIT TO EXISTING BACKWASH AIR BLOWER.
- 16) CONTRACTOR TO PROVIDE AND INSTALL NEW CURRENT TRANSFORMER (CT) FOR EXISTING AMMETER SHOWN IN NOTE #2. CT RATIO SHALL ACCOMMODATE EXISTING AMMETER.

MCC-85 NEW WORK INTERIOR ELEVATION

SCALE: N.T.S.

GENERAL NOTES:

1. SOFTSTARTER DIMENSIONS ARE BASED ON A SPECIFIC MANUFACTURER USED FOR THE BASIS OF DESIGN. THE CONTRACTOR SHALL BE RESPONSIBLE FOR VERIFYING ADAQUATE SPACE IS AVAILABLE WITHIN MCC-85 TO ACCOMMODATE THE SOFTSTARTER SELECTED/PROVIDED PRIOR TO COMMENCING CONSTRUCTION. IF THE CONTRACTOR DETERMINES THAT THE SOFTSTARTER TO BE PROVIDED CANNOT BE INSTALLED WITHIN MCC-85, THE CONTRACTOR SHALL PROVIDE THE SOFTSTARTER WITHIN AN EXTERIOR ENCLOSURE AS DETAILED ON SHEET E-23. THE CONTRACTOR SHALL COORDINATE THE LOCATION OF THE EXTERIOR ENCLOSURE WITH THE CITY AND PROVIDE ALL NECESSARY CONDUIT AND CONDUCTORS REQUIRED FOR THE EXTERIOR ENCLOSURE AT NO COST TO THE CITY.

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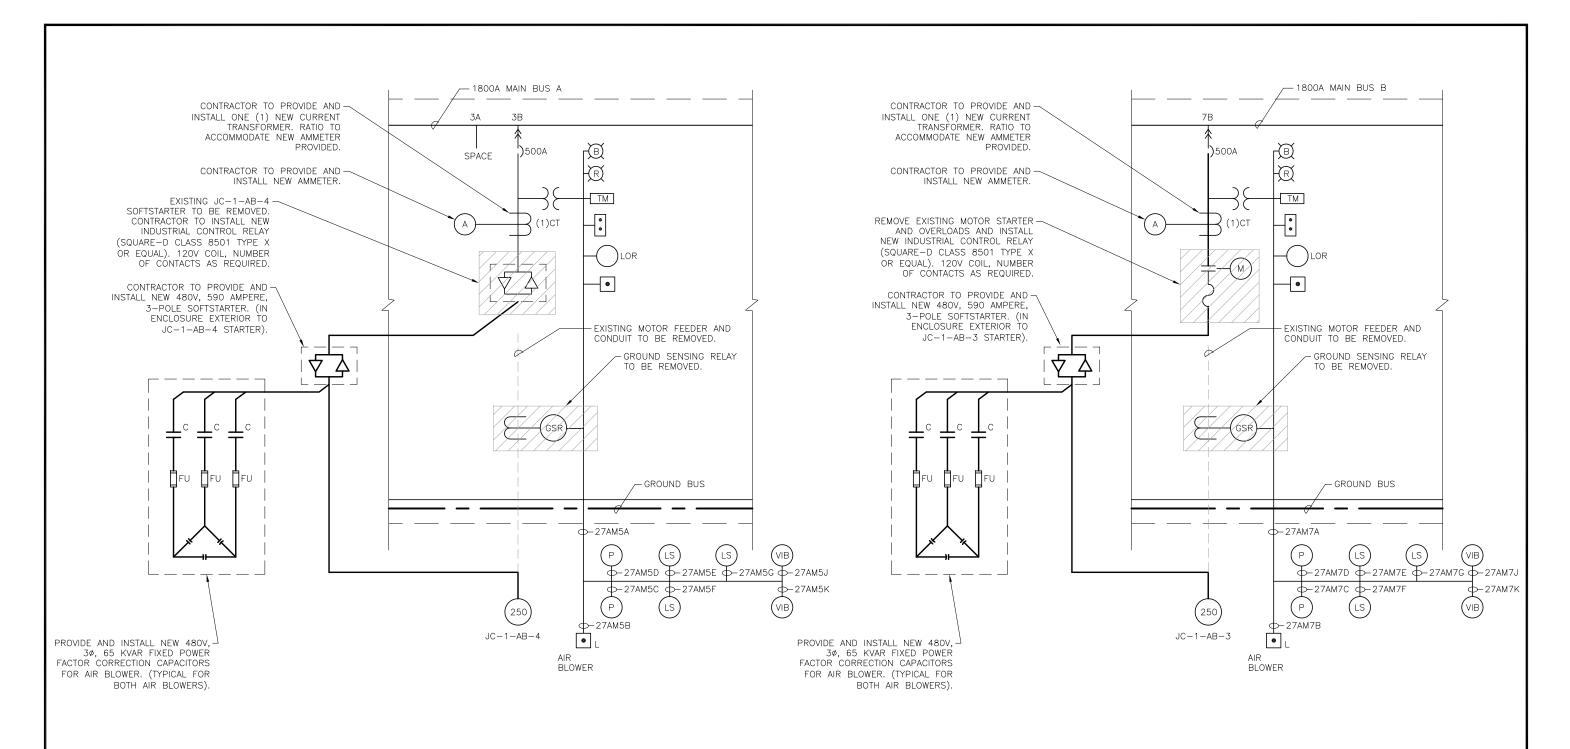
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City of Tampa Wastewater Department

HOWARD F. CURREN AWTP
LARGE MOTOR SOFTSTART ADDITIONS

FILTER BUILDING NO. 2 MCC-85 ELEVATION E-10

TIMOTHY THOMAS. P.E. No. 47079 FILE: 171301342E0



MCC-27A: PARTIAL ONE-LINE DIAGRAM

SCALE: N.T.S.


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HOWARD F. CURREN AWTP	
LARGE MOTOR SOFTSTART ADDITIONS	

JUNCTION CHAMBER NO. 1	
MCC-27A	
ONE-LINE DIAGRAM	

	SHEET NUMBER
	E-11
TIMOTHY THOMAS, P.E. No. 47079	FILE: 171301342E0



MCC-27: ONE-LINE DIAGRAM

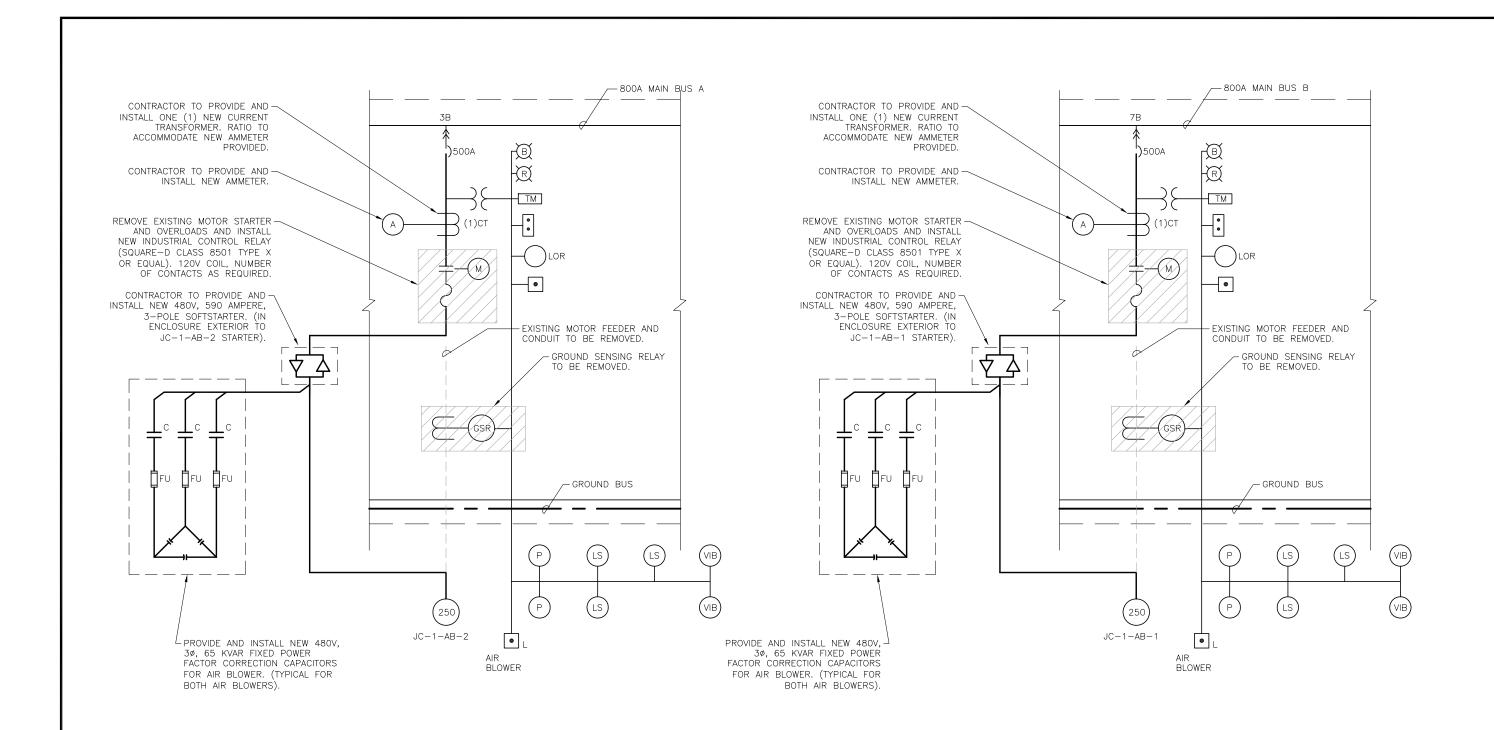SCALE: N.T.S.


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City of Tampa Wastewater Department
HOWARD F. CURREN AWTP
LARGE MOTOR SOFTSTART ADDITIONS

JUNCTION CHAMBER NO.	1
MCC-27B	
ONE-LINE DIAGRAM	

	SHEET NOMBER
	E-12
TIMOTHY THOMAS, P.E. No. 47079	FILE: 171301342E01



MCC-31 PARTIAL ONE-LINE DIAGRAM

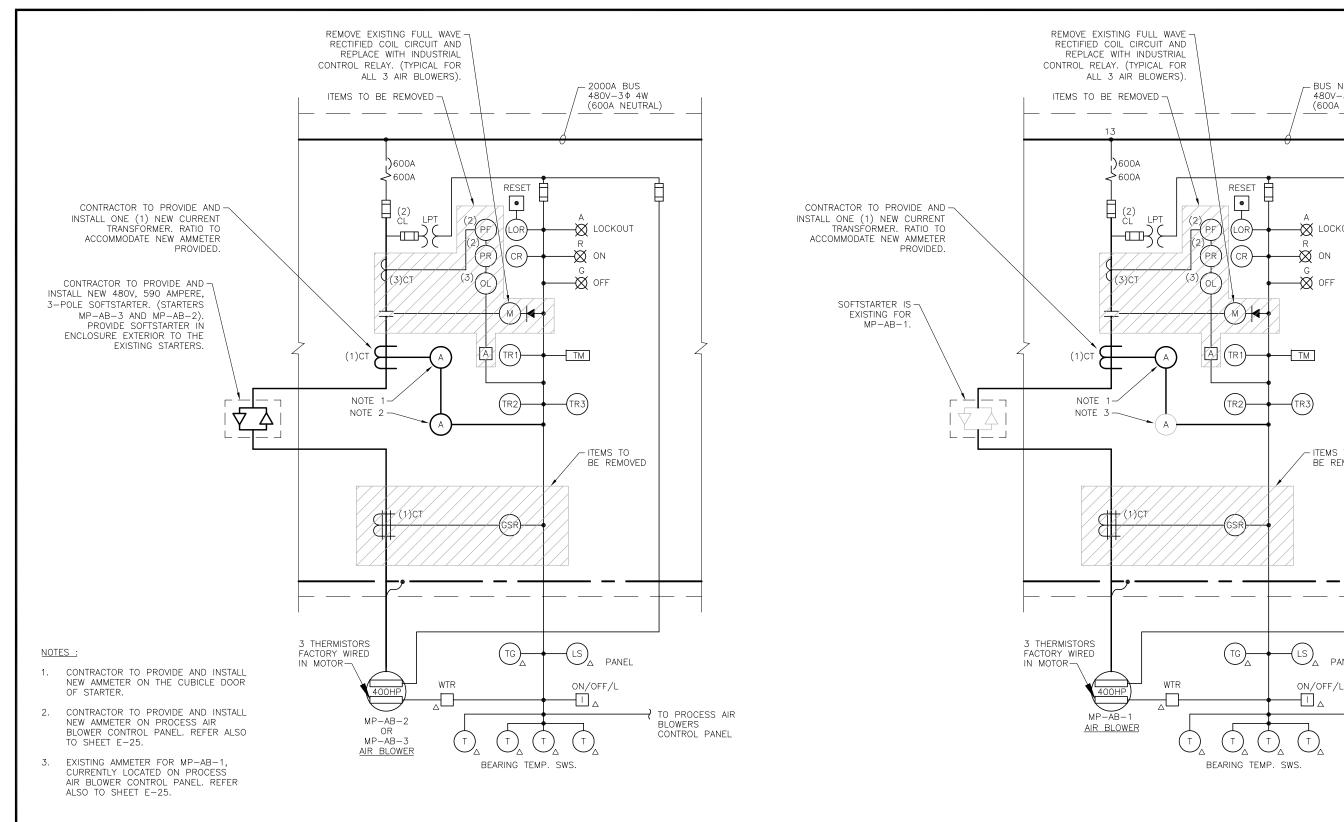TYPICAL FOR STARTERS MP-AB-2 AND MP-AB-3

MCC-31 PARTIAL ONE-LINE DIAGRAM

FOR STARTER MP-AB-1



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City of Tampa Wastewater Department HOWARD F. CURREN AWTP LARGE MOTOR SOFTSTART ADDITIONS

MAIN PUMPING STATION MCC-31PARTIAL ONE-LINE DIAGRAM

SHEET NUMBER E-13 TIMOTHY THOMAS, P.E. No. 47079 FILE: 171301342E0

TO PROCESS AIR

CONTROL PANEL

-BUS NO 2, 2000A 480V-3 4W


(600A NEUTRAL)

₩ LOCKOUT

ITEMS TO

BE REMOVED

₩ OFF

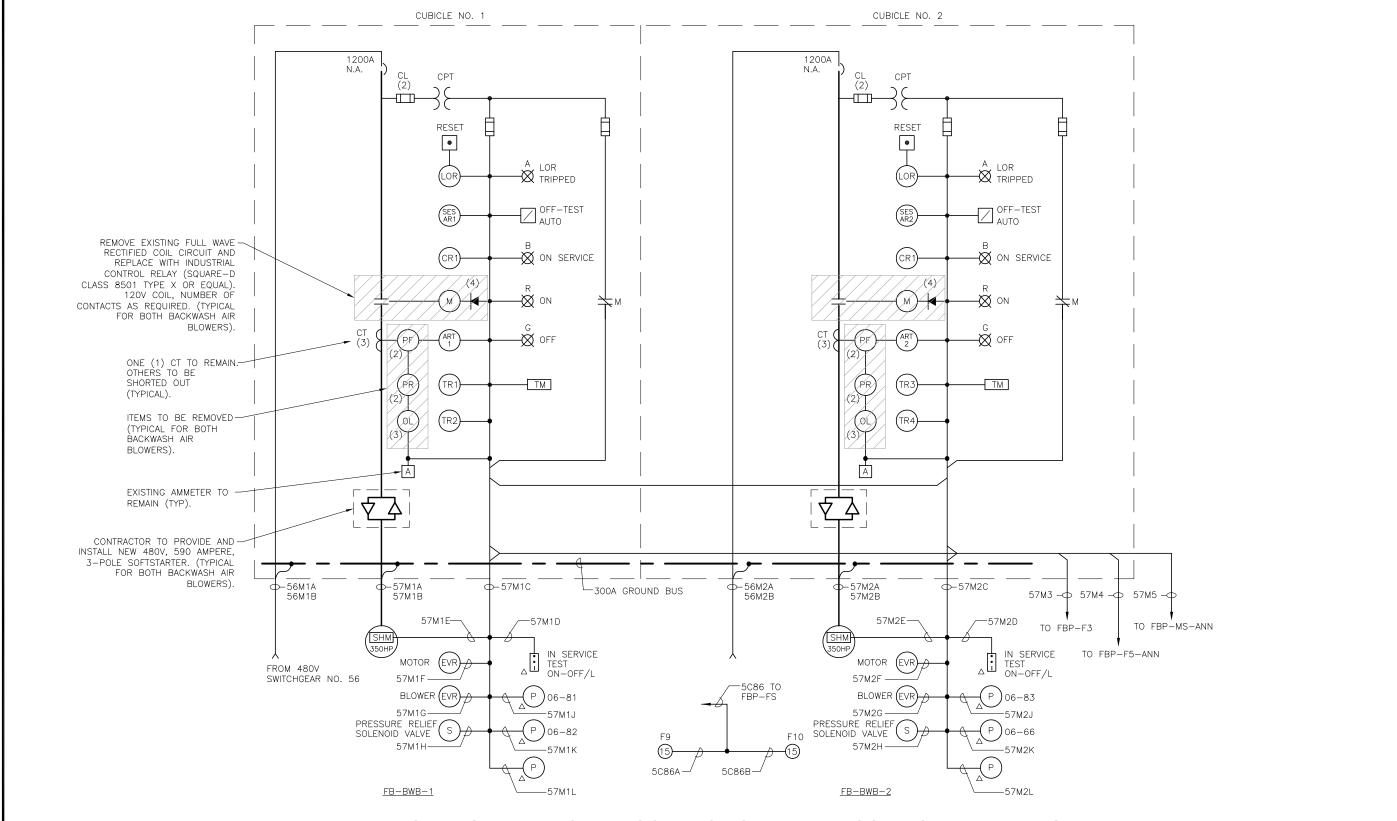

BACKWASH AIR BLOWER CONTROL CENTER: MCC-57 ONE-LINE DIAGRAM

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City of Tampa Wastewater Department
HOWARD F. CURREN AWTP
LARGE MOTOR SOFTSTART ADDITIONS

FILTER BUILDING NO. 1

MCC-57


ONE-LINE DIAGRAM

SHEET NUMBER

E-14


TIMOTHY THOMAS, P.E. No. 47079


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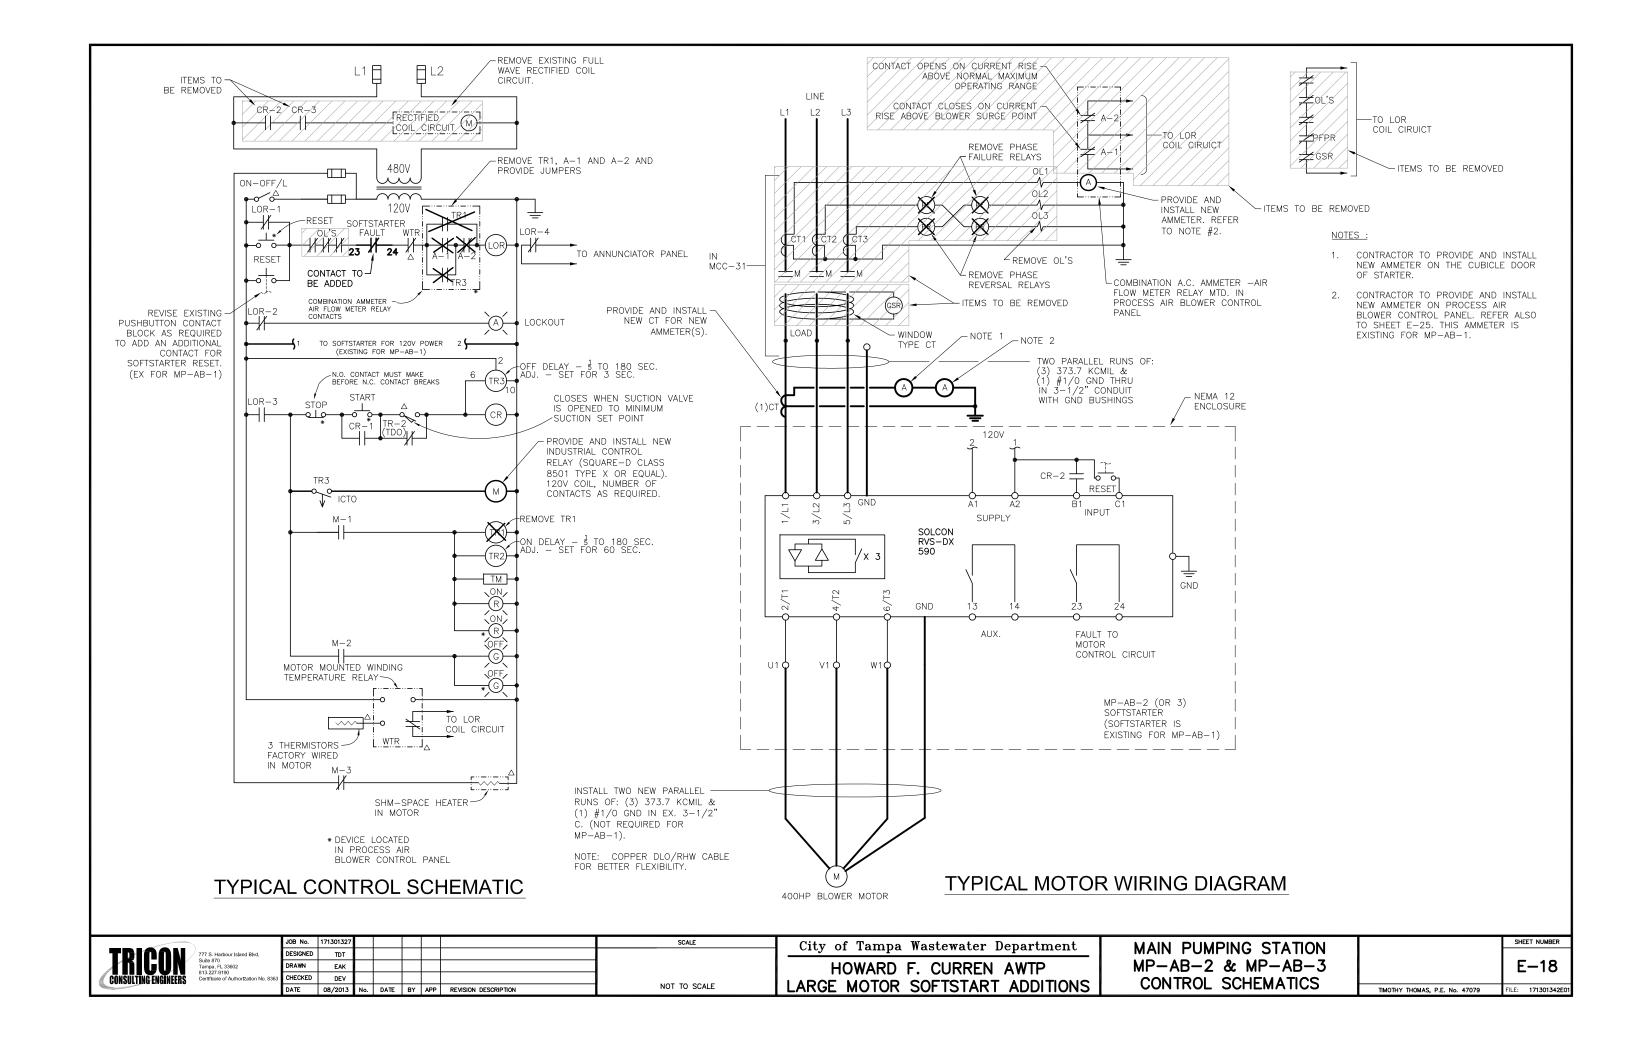


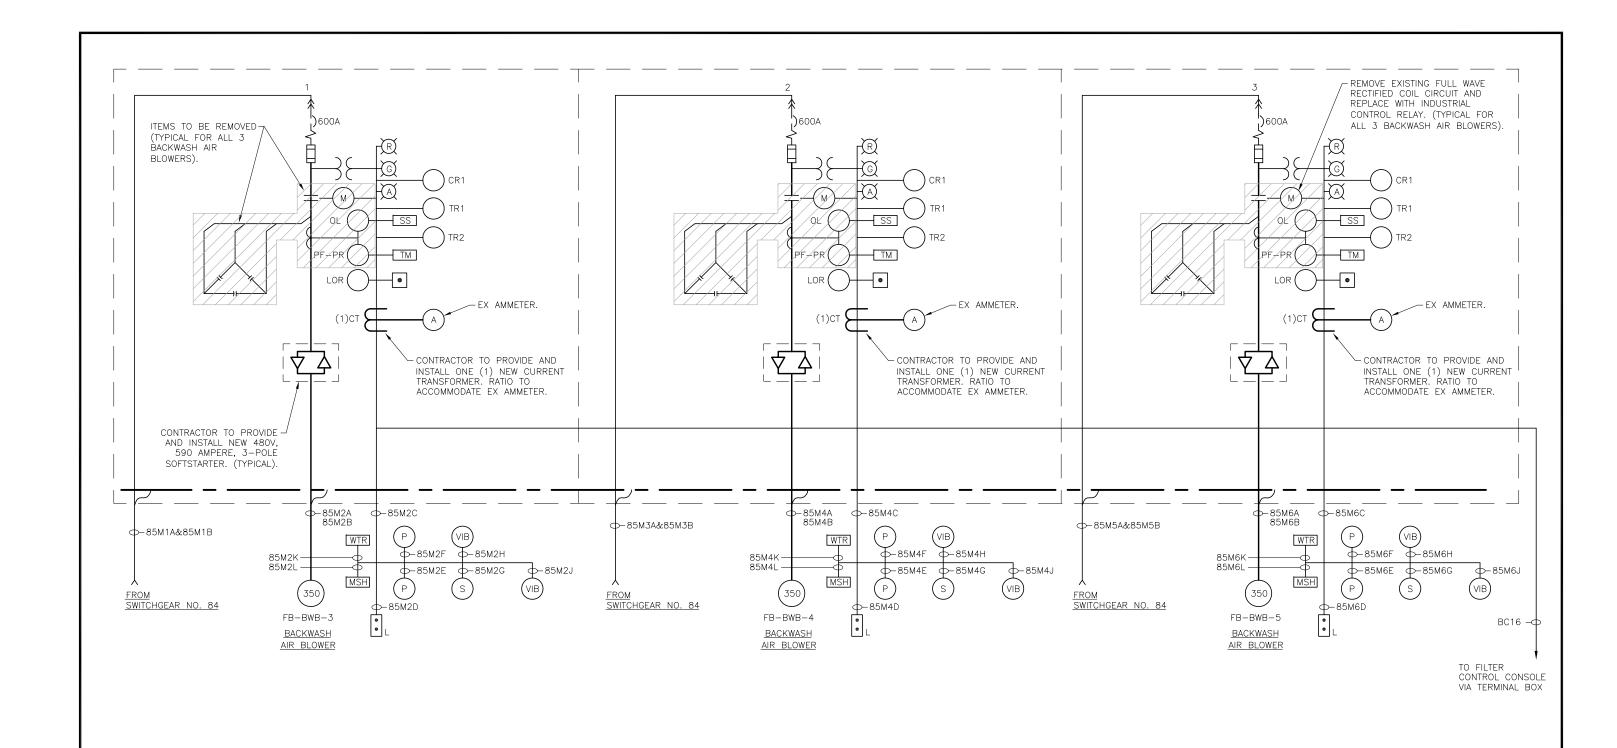
MCC-85 ONE-LINE DIAGRAM


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TYPICAL MOTOR WIRING


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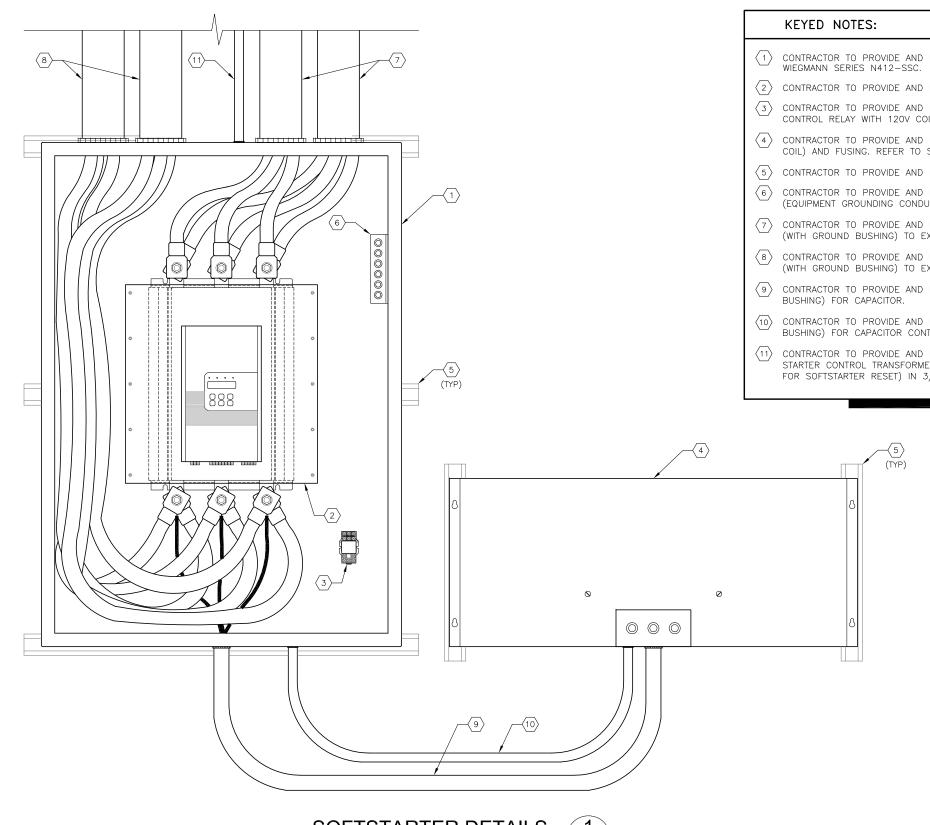
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City of Tampa Wastewater Department
HOWARD F. CURREN AWTP
LARGE MOTOR SOFTSTART ADDITIONS

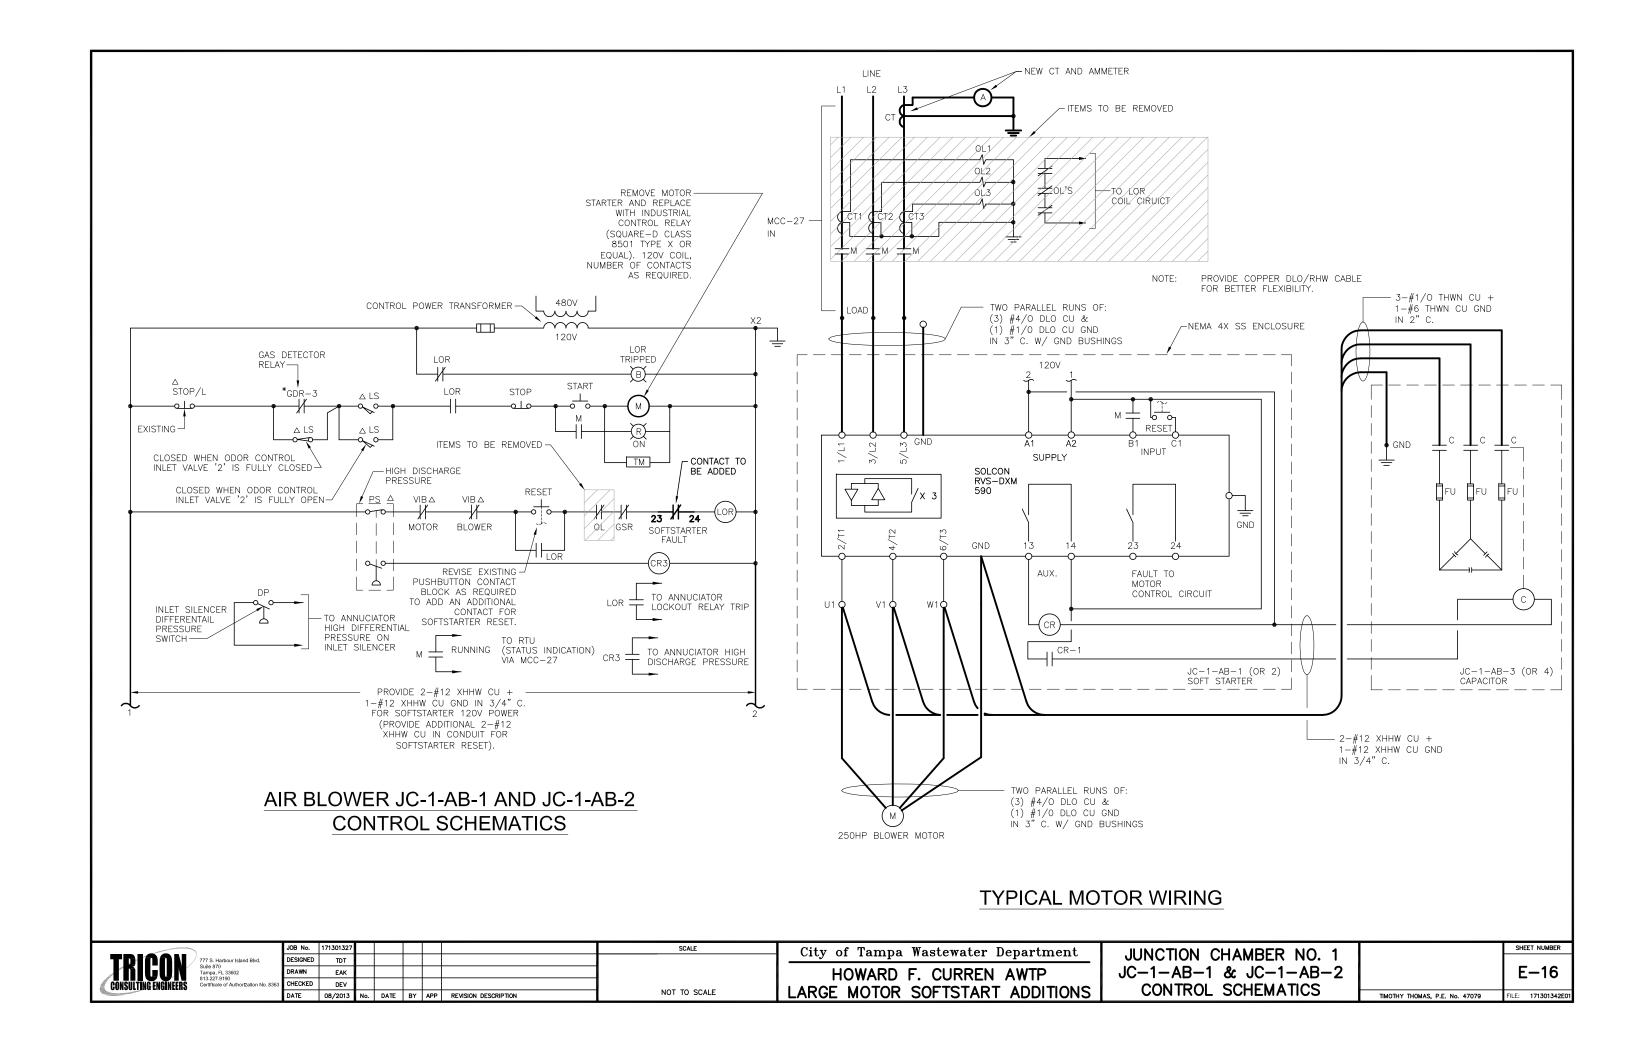FILTER BUIL	DING NO. 1	
FB-BWB-1 &	FB-BWB-2	
MOTOR WIRING	SCHEMATICS	

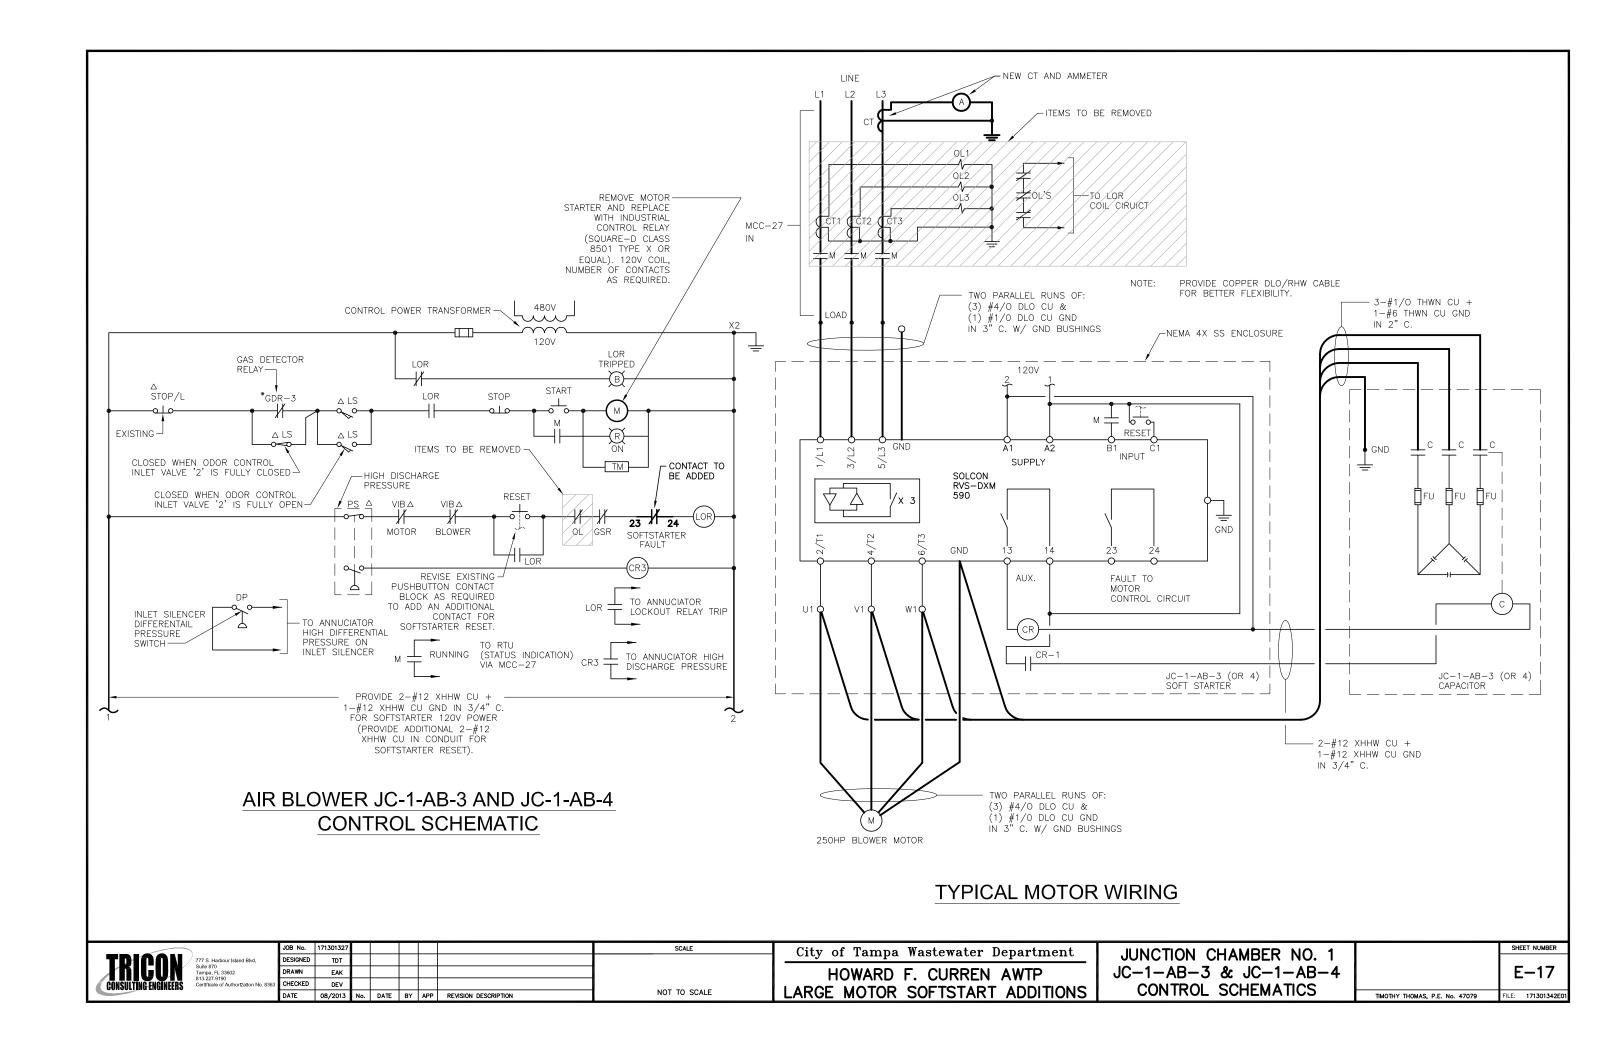	SHEET NUMBER
	E-20
TIMOTHY THOMAS, P.E. No. 47079	FILE: 171301342E01

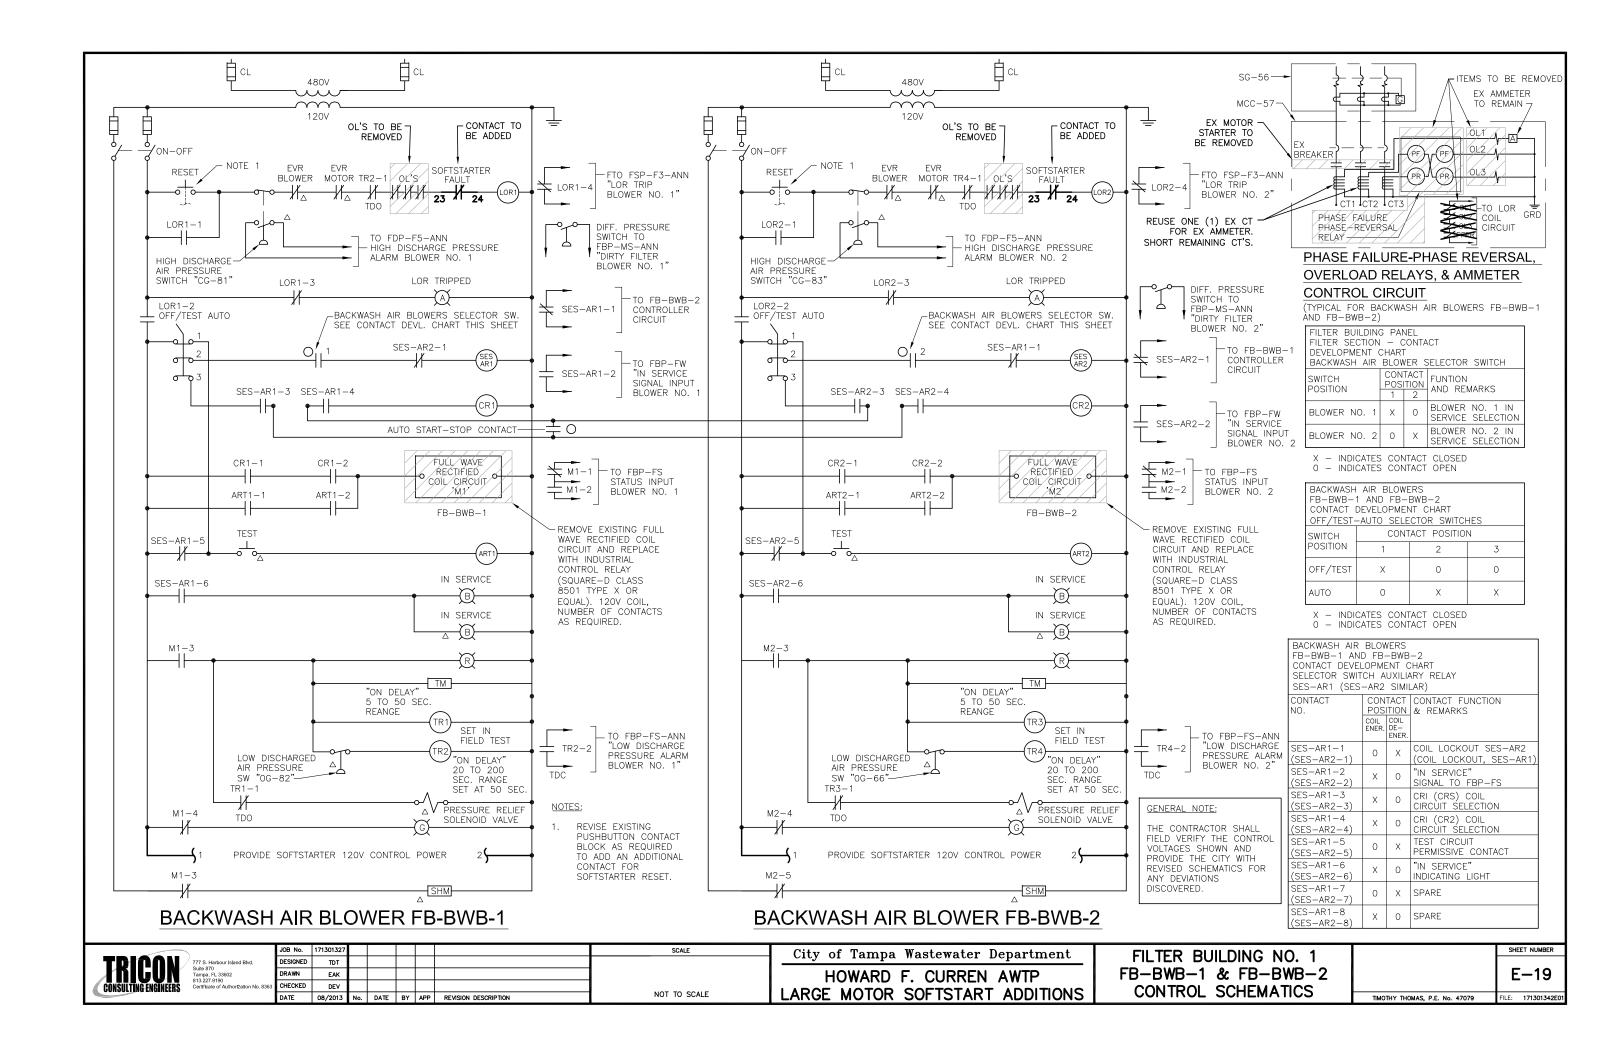

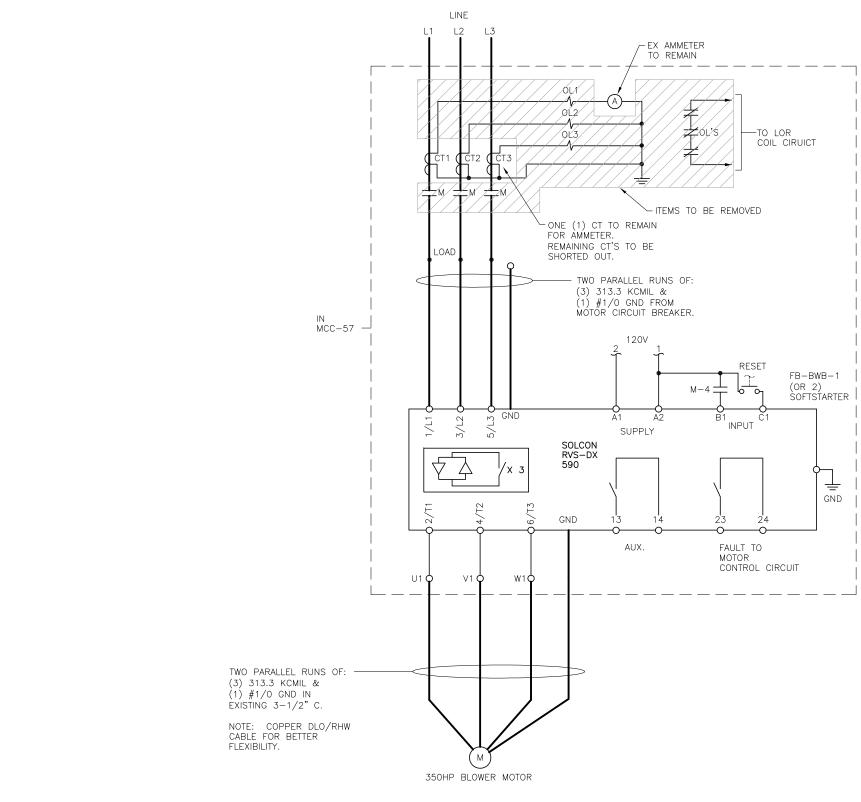

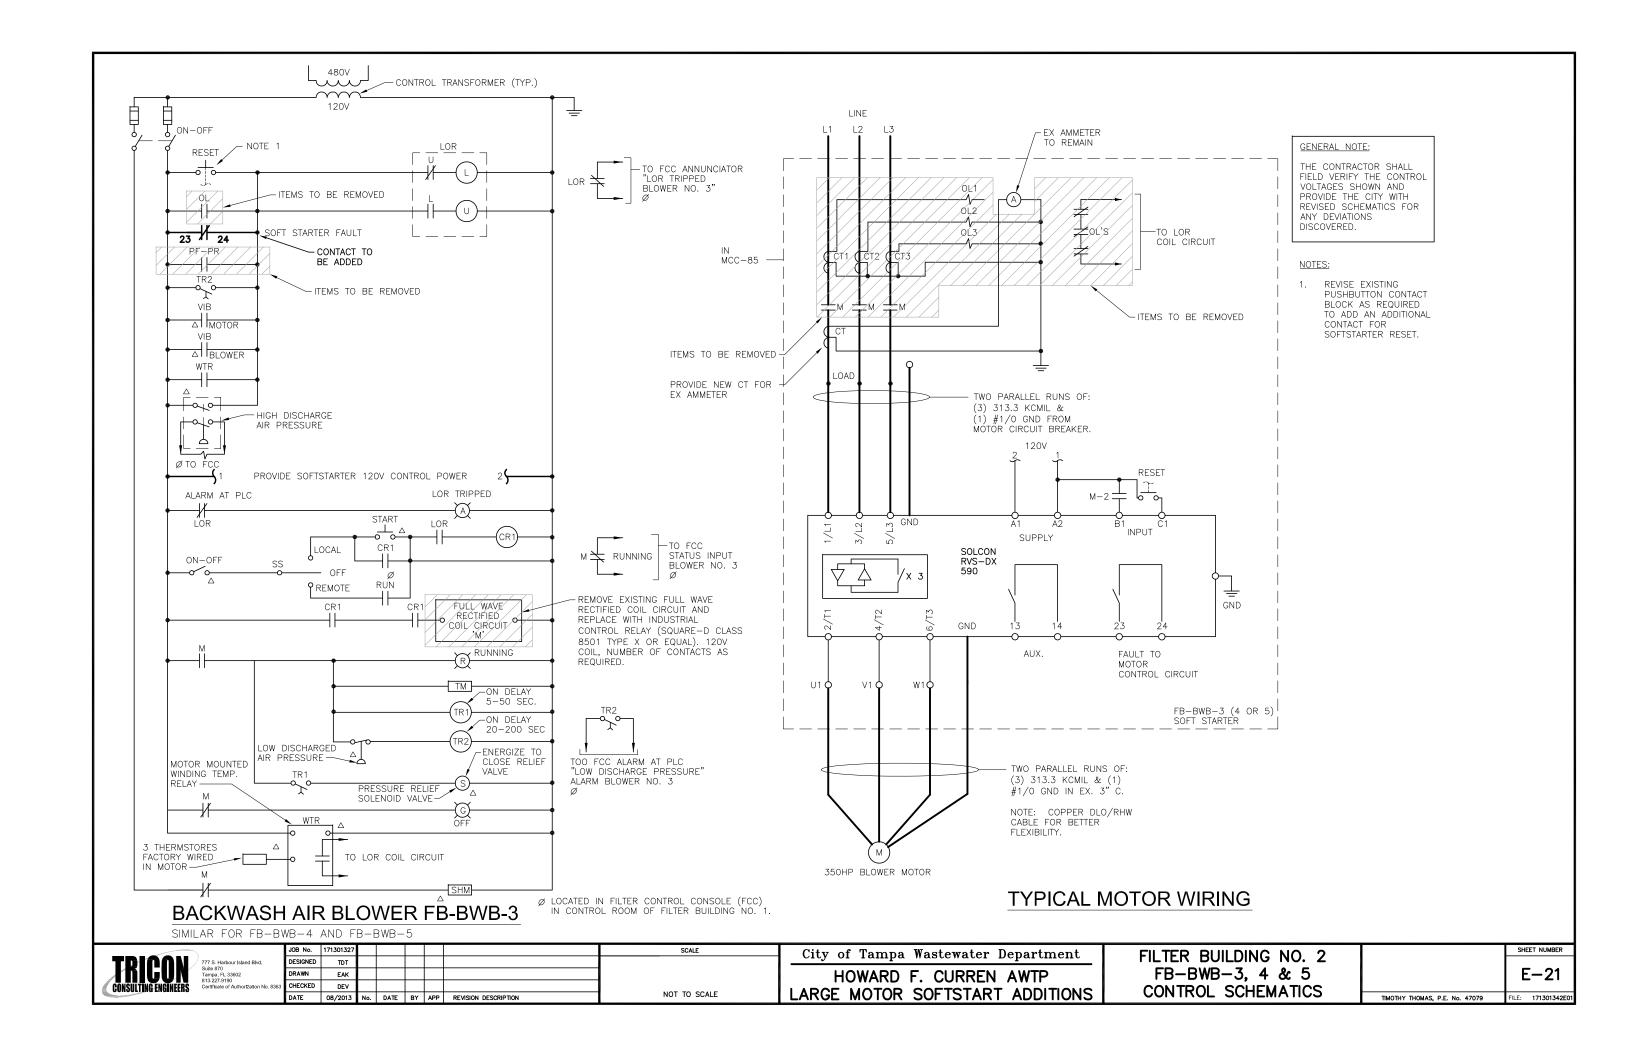
- ONTRACTOR TO PROVIDE AND INSTALL NEW 42"H x 30"W x 16"D NEMA 4X STAINLESS STEEL ENCLOSURE. WIEGMANN SERIES N412-SSC.
- $\langle 2
 angle$ contractor to provide and install new solcon softstarter. Solcon model number RVS-DXM 590-8.
- 3) CONTRACTOR TO PROVIDE AND INSTALL NEW INTERPOSING RELAY FOR CAPACITOR CONTACTOR COIL. 2—PDT, 10A, CONTROL RELAY WITH 120V COIL. SQUARE—D CAT# 8501 KU12 V20 OR EQUAL.
- (4) CONTRACTOR TO PROVIDE AND INSTALL NEW CAPACITOR. 480V, 30, 65 KVAR WITH INTEGRAL CONTACTOR (120V COIL) AND FUSING. REFER TO SPECIFICATIONS.
- $\langle exttt{5}
 angle$ contractor to provide and install new 1-5/8" x 1-5/8" aluminum unistrut with aluminum hardware.
- 6 CONTRACTOR TO PROVIDE AND INSTALL GROUND LUGS TO ACCOMMODATE EQUIPMENT GROUNDING CONDUCTORS (EQUIPMENT GROUNDING CONDUCTORS NOT SHOWN FOR CLARITY.
- CONTRACTOR TO PROVIDE AND INSTALL TWO PARALLEL RUNS OF 3-#4/O DLO CU + 1-#1/O DLO CU IN 3" C. (WITH GROUND BUSHING) TO EXISTING MOTOR CIRCUIT BREAKER.
- (8) CONTRACTOR TO PROVIDE AND INSTALL TWO PARALLEL RUNS OF 3-#4/O DLO CU + 1-#1/O DLO CU IN 3" C. (WITH GROUND BUSHING) TO EXISTING MOTOR.
- (9) CONTRACTOR TO PROVIDE AND INSTALL 3-#1/O THWN CU + 1-#6 THWN CU GND IN 2" C. (WITH GROUND BUSHING) FOR CAPACITOR.
- (10) CONTRACTOR TO PROVIDE AND INSTALL 2-#12 XHHW CU + 1-#12 XHHW CU GND IN 3/4" C. (WITH GROUND BUSHING) FOR CAPACITOR CONTACTOR CONTROL.
- CONTRACTOR TO PROVIDE AND INSTALL 4-#12 XHHW CU + 1-#12 XHHW CU GND (2-#12 XHHW FROM STARTER CONTROL TRANSFORMER TO SOFTSTARTER FOR 120V POWER, 2-#12 XHHW FROM RESET PUSHBUTTON FOR SOFTSTARTER RESET) IN 3/4" C. (WITH GROUND BUSHING).

GENERAL NOTES:

- THE NEW 480V, 590 AMPERE, SOFTSTARTERS AND NEW 480V, 3ø, 65 KVAR CAPACITORS SHALL BE PROVIDED IN NEMA 4X STAINLESS STEEL ENCLOSURES. (APPLIES ONLY TO SOFTSTARTERS AND CAPACITORS IN JUNCTION CHAMBER NO. 1).
- 2. SOFTSTARTER DIMENSIONS, SOFTSTARTER ENCLOSURE DIMENSIONS AND CAPACITOR DIMENSIONS SHOWN ARE BASED ON SPECIFIC MANUFACTURERS USED FOR THE BASIS OF DESIGN. THE CONTRACTOR SHALL BE RESPONSIBLE FOR SIZNG OF ENCLOSURES BASED ON THE FINAL EQUIPMENT SELECTED/PROVIDED.
- THE DETAIL DEPICTS INSTALLATION OF THE SOFTSTARTER/CAPACITOR ON MASONRY WALLS ONLY. FOR INSTALLATION OF THE SOFTSTARTER/CAPACITOR ON OTHER THAN MASONRY WALL THE CONTRACTOR SHALL: PROVIDE AND INSTALL 4" SQUARE ALUMINUM POST WITH 1/2" WALL THICKNESS. WELD 1/4" TOP TO EACH POST. PROVIDE FULL FILLET WELD TO BASE PLATE. PROVIDE AND INSTALL 1-5/8" X 1-5/8" ALUMINUM UNISTRUT. ALL MOUNTING HARÓWARE SHALL BE ALUMINUM. UNISTRUT BOLTS SHALL BE INSTALLED THROUGH POST. PROVIDE AND INSTALL 10" X 10" X 3/4" ALUMINUM BASE PLATE. SECURE EACH BASE PLATE TO CONCRETE W/(4) STAINLESS STEEL 1/2" DIA. X 4" BOLTS & STAINLESS STEEL HEX NUTS WITH LOCKWASKER. DRILL CONCRETE & EMBED BOLTS AND ANCHORS IN EPOXY. COAT BOTTOM OF BASE PLATE WITH ASPHALT PAINT.

SOFTSTARTER DETAILS
SCALE: N.T.S.

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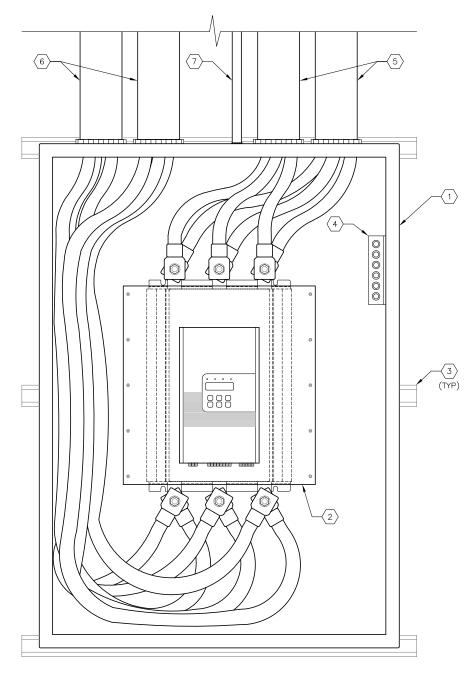


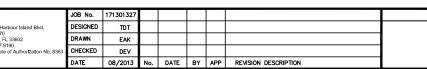City of Tampa Wastewater Department
HOWARD F. CURREN AWTP
LARGE MOTOR SOFTSTART ADDITIONS

JC-1-AB-1, JC-1-AB-2, JC-1-AB-3 & JC-1-AB-4 SOFTSTARTER DETAILS E-22

TIMOTHY THOMAS, P.E. No. 47079

FILE: 171301342E



KEYED NOTES:

- CONTRACTOR TO PROVIDE AND INSTALL NEW 42"H x 30"W x 16"D NEMA 12 ENCLOSURE. WIEGMANN MODEL NUMBER N12423016.
- 2 CONTRACTOR TO PROVIDE AND INSTALL NEW SOLCON SOFTSTARTER. SOLCON MODEL NUMBER RVS-DXM 590-8.
- 3 CONTRACTOR TO PROVIDE AND INSTALL NEW 1-5/8" X 1-5/8" ALUMINUM STEEL UNISTRUT WITH ALUMINUM HARDWARE.
- CONTRACTOR TO PROVIDE AND INSTALL GROUND LUGS TO ACCOMMODATE EQUIPMENT GROUNDING CONDUCTORS (EQUIPMENT GROUNDING CONDUCTORS NOT SHOWN FOR CLARITY.
- CONTRACTOR TO PROVIDE AND INSTALL TWO PARALLEL RUNS OF 3-373.7 KCMIL DLO CU + 1-#1/0 DLO CU IN 3-1/2" C. (WITH GROUND BUSHING) TO EXISTING CIRCUIT BREAKER.
- 6 CONTRACTOR TO PROVIDE AND INSTALL TWO PARALLEL RUNS OF 3-373.7 KCMIL DLO CU + 1-#1/0 DLO CU IN 3-1/2" C. (WITH GROUND BUSHING) TO EXISTING MOTOR (VIA MCC CUBICLE).
- (7) CONTRACTOR TO PROVIDE AND INSTALL 4-#12 XHHW CU + 1-#12 XHHW CU GND (2-#12 XHHW FROM STARTER CONTROL TRANSFORMER TO SOFTSTARTER FOR 120V POWER, 2-#12 XHHW FROM RESET PUSHBUTTON FOR SOFTSTARTER RESET) IN 3/4" C. (WITH GROUND BUSHING).

GENERAL NOTES:

1. SOFTSTARTER DIMENSIONS AND SOFTSTARTER ENCLOSURE DIMENSIONS SHOWN ARE BASED ON SPECIFIC MANUFACTURERS USED FOR THE BASIS OF DESIGN. THE CONTRACTOR SHALL BE RESPONSIBLE FOR SIZNG OF ENCLOSURES BASED ON THE FINAL EQUIPMENT SELECTED/PROVIDED.

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City of Tampa Wastewater Department

HOWARD F CURREN AWTP

HOWARD F. CURREN AWTP LARGE MOTOR SOFTSTART ADDITIONS MP-AB-2 & MP-AB-3 SOFTSTARTER DETAILS E-23

TIMOTHY THOMAS, P.E. No. 47079 FIL

MOTOR FEEDER INFORMATION (LENGTHS ARE APPROXIMATIONS)

1. AIR BLOWERS JC-1-AB-1, JC-1-AB-2, JC-1-AB-3 AND JC-1-AB-4.

EXISTING MOTOR FEEDERS AND CONDUIT TO BE REPLACED WITH PARALLEL RUNS OF 3-#4/O DLO CU + 1-#1/O DLO CU IN 3" C. (WITH GROUND BUSHING). PROVIDE LIQUID-TIGHT FLEXIBLE CONDUIT CONNECTION TO MOTOR.

APPROXIMATE CONDUIT LENGTHS :

JC-1-AB-1 :: 75 FEET JC-1-AB-2 :: 85 FEET JC-1-AB-3 :: 90 FEET JC-1-AB-4 :: 90 FEET

APPROXIMATE CONDUCTOR LENGTHS :

JC-1-AB-1 :: 105 FEET JC-1-AB-2 :: 115 FEET JC-1-AB-3 :: 120 FEET

ASSOCIATED MOTOR.

JC-1-AB-4 :: 120 FEET NOTE THAT CONDUIT/CONDUCTOR LENGTHS ARE FROM MCC CUBICLE TO NEW SOFTSTARTER ENCLOSURE AND FROM NEW SOFTSTARTER ENCLOSURE TO

2. MAIN PUMP AIR BLOWERS MP-AB-2 AND MP-AB-3.

EXISTING MOTOR FEEDERS TO BE REPLACED WITH TWO (2) PARALLEL RUNS OF 3-373.7 KCMIL DLO CU + 1-#1/0 DLO CU IN EXISTING 3-1/2" CONDUIT. PROVIDE NEW LIQUID-TIGHT FLEXIBLE CONDUIT CONNECTION TO MOTOR.

NOTE THAT CONDUIT LENGTHS ARE FROM MOTOR STARTER CUBICLE TO MOTOR, HOWEVER CONDUCTOR LENGTHS ARE FROM SOFTSTARTER (THROUGH EXISTING STARTER CUBICLE) TO MOTOR.

APPROXIMATE CONDUCTOR LENGTHS:

MP-AB-2 :: 170 FEET MP-AB-3 :: 155 FEET

3. BACKWASH AIR BLOWERS FB-BWB-1 AND FB-BWB-2.

EXISTING MOTOR FEEDERS TO BE REPLACED WITH 3-313.3 KCMIL DLO CU +1-#1/0 DLO CU IN EXISTING 3" CONDUIT. PROVIDE NEW LIQUID-TIGHT FLEXIBLE CONDUIT CONNECTION TO MOTOR.

APPROXIMATE CONDUCTOR LENGTHS:

FB-BWB-1 :: 275 FEET FB-BWB-2 :: 305 FEET

4. BACKWASH AIR BLOWERS FB-BWB-3, FB-BWB-4 AND FB-BWB-5.

EXISTING MOTOR FEEDERS TO BE REPLACED WITH TWO (2) PARALLEL RUNS OF 3-313.3 KCMIL DLO CU + 1-#1/O DLO CU IN EXISTING 3-1/2" CONDUIT. PROVIDE NEW LIQUID-TIGHT FLEXIBLE CONDUIT CONNECTION TO MOTOR.

APPROXIMATE CONDUCTOR LENGTHS:

FB-BWB-3 :: 115 FEET FB-BWB-4 :: 140 FEET FB-BWB-5 :: 165 FEET

NOTE :

CONTRACTOR TO FIELD VERIFY CONDUIT LENGTHS AND SIZES PRIOR TO COMMENCING CONSTRUCTION.

SOFTSTARTER SET UP PARAMETERS

UPON START-UP OF EACH SOFTSTARTER, THE CONTRACTOR SHALL DOCUMENT THE INITIAL CONTROL PARAMETERS AND SETTING UTILIZED.

THE SETTINGS FOR EACH SOFTSTARTER SHALL BE PROVIDED ON AN $8"\ X\ 11"$ LAMINATED DOCUMENT AND SHALL BE PLACED ON THE INNER DOOR OF THE ASSOCIATED SOFTSTARTER (OR MOTOR STARTER CUBICLE).

THE MINIMUM PARAMETERS TO BE DOCUMENTED SHALL INCLUDE:

- SOFTSTARTER FULL LOAD CURRENT
- MOTOR FULL LOAD CURRENT
- SOFTSTARTER RATED POWER
- CONNECTION TYPE (LINE OR INSIDE DELTA)
- RATED LINE VOLTAGE
- OVERCURRENT TRIP AS A FUNCTION OF FULL LOAD AMPERES
- UNDERCURRENT DELAY (IN SECONDS)
- OVERCURRENT SHEAR PIN (% OF FULL LOAD CURRENT)
- OVERCURRENT TIME DELAY
- 10. OVERLOAD CLASS
 11. OVERLOAD PROTECT ENABLE WHILE RUN
- 12. UNDERVOLT TRIP (% OF LINE VOLTAGE)
- 13. UNDERVOLTAGE TRIP DELAY (IN SECONDS)
- 14. OVERVOLTAGE TRIP (% OF LINE VOLTAGE)
- 15. OVERVOLTAGE TRIP DELAY (IN SECONDS)
- 16. SOFTSTART CURVE
- 17. PULSE TIME (IN SECONDS)
- 18. INITIAL VOLTAGE (% OF LINE VOLTAGE)
- 19. INITIAL CURRENT (% OF FULL LOAD CURRENT)
- 20. CURRENT LIMIT OF FULL LOAD (% OF FULL LOAD CURRENT)
- 21. ACCELERATION TIME (IN SECONDS)
- 22. MAX START TIME (IN SECONDS)
- 23. NUMBER OF STARTS (NUMBER OF STARTS PERMITTED IN START PERIOD)
- 24. STARTS PERIOD (1-60 MINUTE PERIOD)
- 25. START INHIBIT (1-60 MINUTES)
- 26. SOFT STOP CURVE
- 27. DECELERATION TIME (IN SECONDS)
- 28. FINAL TORQUE

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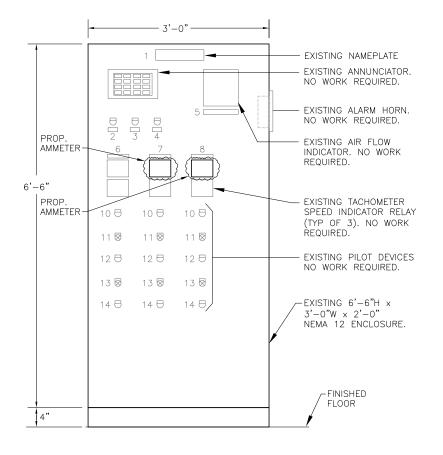
City of Tampa Wastewater Department HOWARD F. CURREN AWTP

LARGE MOTOR SOFTSTART ADDITIONS

MOTOR FEEDER INFORMATION

SHEET NUMBER E-24 FILE: 171301342E

TIMOTHY THOMAS, P.E. No. 47079



	NAME PLATE LEGEND						
ITEM	DEVICE						
1	PROCESS AIR BLOWERS CONTROL PANEL						
2	SILENCE						
3	TEST						
4	RESET						
5	TOTAL AIR FLOW						
6	BLOWER NO. 1 - MP-AB-1						
7	BLOWER NO. 2 - MP-AB-2						
8	BLOWER NO. 3 - MP-AB-3						
9	BLOWER NO. 4 - MP-AB-4						
10	RESET						
11	ON						
12	START						
13	OFF						
14	STOP						

PRO	CESS AIR BLOWERS CONTROL PANEL ANNUNCIATOR LEGEND
STYL	LE — 4 HIGH x 4 WIDE DULARM
WINDOW	ENGRAVING
1A	BLOWER NO. 1 - LOCKOUT RELAY TRIP
2A	BLOWER NO. 2 - LOCKOUT RELAY TRIP
3A	BLOWER NO. 3 - LOCKOUT RELAY TRIP
4A	BLOWER NO. 4 - LOCKOUT RELAY TRIP
1B	BLOWER NO. 1 - BEARING HIGH TEMP.
2B	BLOWER NO. 2 - BEARING HIGH TEMP.
3B	BLOWER NO. 3 - BEARING HIGH TEMP.
4B	BLOWER NO. 4 - BEARING HIGH TEMP.
1C	BLOWER NO. 1 - CHECK VALVE OPEN
2C	BLOWER NO. 2 - CHECK VALVE OPEN
3C	BLOWER NO. 3 - CHECK VALVE OPEN
4C	BLOWER NO. 4 - CHECK VALVE OPEN
1D	BLOWER NO. 1 - AIR INTAKE FILTER DIRTY
2D	BLOWER NO. 2 - AIR INTAKE FILTER DIRTY
3D	BLOWER NO. 3 - AIR INTAKE FILTER DIRTY
4D	BLOWER NO. 4 - AIR INTAKE FILTER DIRTY

PROCESS AIR BLOWER ELEVATION	1 B
SCALE : N.T.S.	E-3 E-25

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City of Tampa Wastewater Department
HOWARD F. CURREN AWTP
LARGE MOTOR SOFTSTART ADDITIONS

PROCESS AIR BLOWER CONTROL PANEL DETAILS

	SHEET NUMBER
	E-25
TIMOTHY THOMAS, P.E. No. 47079	FILE: 171301342E0