The Enclosed Document Is Provided For Your Convenience.

Please Email ALL Questions:

MailTo:ContractAdministration@TampaGov.net

Please Let Us Know If You Plan To Bid

City of Tampa
Contract Administration Department
306 E. Jackson St. #280A4N
Tampa, FL 33602
(813)274-8456

EXISTING SURFACES (WALLS, CEILINGS, ETC. DURING CONSTRUCTION. THE CONTRACTOR SAFTER CONSTRUCTION. REPAIR, PAINT AND COAMAGED AS A RESULT OF PERFORMANCE

ETC.) SHALL BE PROTECTED IN SHALL CLEAN SURFACES ID ON REPLACE AREAS CE OF THE WORK.

WORK CAN NOT INTERFERE WITH ONGOING OPERATIONS OF EACH STATION.
COORDINATE EXTERIOR STORAGE/STAGING AREAS WITH C.O.T. REPRESENTATIVE.

CONTRACT

ADMIN.

FILE

NUMBER

IN GENERAL, ON SITE WORK SHALL NOT START UNTIL ALL MATERIAL IS AVAILABLE FOR INSTALLATION, ONLY LIMITED WORK (NOT INTERFERING WITH THE USE OF THE KITCHEN) WILL BE ALLOWED PRIOR TO ALL MATERIAL BEING AVAILABLE TO MINIMIZE THE LENGTH OF TIME THE KITCHENS ARE OUT OF SERVICE.

MULDING CATEGORY .

HADORAL OF HADORAL

NFPA# | & 101 (2009)

INSTALLATION OF AIR-CONDITIONING AND VENTILATION SYSTEMS,

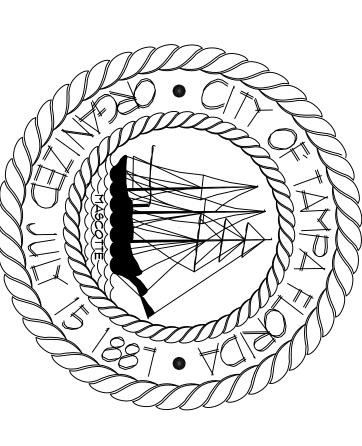
NATIONAL ELECTRICAL CODE, 2008
NEPA* 13, INSTALLATION OF SPRINKLER SYSTEMS

NFPA# 20, INSTALLATION OF SECONDARY NFPA# 24, PRIVATE FIRE SERVICE MAINS.

MORK SHALL BE

COORDINATED RESENTATIVE.

WITH THE



LEA(PGRADES

2101 E. M.L.K. BLVD. TAMPA, FLORIDA 33610

ABBREVIATIONS equalexisting existing expansion joint exterior finished floor elevation finished floor line flashing flooring above finished f adjustable air conditioning alternate anchor bolt oituminous olocking ouilt up roofing sast-in-place co ceiling ceramic tile ownspout awing inking fountain sctrical water con yation ual vinyl asbestos title vinyl base water closet water heater water proofing wood reinforced vinyl title reference return air roof drain roofing rough opening service sink similar solid core epecification(s) square stainless steel structural to be removed telephone thick(ness) tongue * groove unless noted otherwise vapor barrier vertical SYMBOL TO III OF I অ ⟨ ॹ ⟩ <u></u> ACC≡66 S elevation mark sheet number SECTION CUT MULTI-ELEVATION BINDOM TYPE 105 (a) —∨iew mark (on same sheet) -sheet number **PROJECT** COMMUNITY-PANEL NUMBER FIRM NOTE FLOOD TO THE BEST OF OUR KNOWLEDGE, INFORMATION AND BELIEF, THESE DOCUMEN COMPLY WITH CURRENTLY ADOPTED COMPLY WITH CURRENTLY ADOPTED COMPLY WITH CURRENTLY ADOPTED COSTANDARDS AND ACTS, WHICH INCLUDE, BUT ARE NOT LIMITED TO: CLASSIFICATION: • OCCUPANCY: GROUP B EXIT REQUIREMENTS: MINIMUM CORRIDOR WIDTH - 44" MAXIMUM TRAVEL DISTANCE - 200 FT. COMMON PATH OF TRAVEL - 75 FT. DEAD END CORRIDOR - 20 FT. ONSTRUCTION TYPE: TYPE || A, SPRINKLERED NTERIOR FINISHES: • ALL SPACES: CLASS "C" MATERIALS MINIMUM • FLAME SPREAD: 16 - 200 • SMOKE DEVELOPED: 0 - 450 FLORIDA BUILDING CODE 2010 FLORIDA STATUTE *633, WHICH INCLUDES: STATE FIRE MARSHALL'S RULES AND REGULATIONS RE RATING/CONSTRUCTION OF: INTERIOR BEARING WALLS - NO ROOF & ROOF/CEILING - NO FLOOR - NO **NOTES** ZONE **A9** ODES,

CONSULTANTS

THOMAS A. HESTER, A.I.A. - PROJECT ARCHIT DPR *ARSI143 306 E. JACKSON ST. - 4N TAMPA, FL 33602 PHONE (813) 274-5678 / FAX (813) 274-8080

ARCHITECT

ARCHITECT

NDEX

LOC, ATION MAP

COVER SHEET / GENERAL INFORMATION SITE PLAN
INFORMATION PLANS & ELEVATIONS
ELECTRICAL RISER & NOTES

ST

AVENIDA A A A A A A A A A A A A A A A A A A	29TH 29TH 28TH 27TH	JBA P	13TH 14TH	ST. ST.	ST.
SANCHEZ \$\frac{n}{2} ST.	AVE. 6TH	33RD 32ND 31ST	STATE 16TH	CHELSE A	
ST. 17TH ST.		TH ST.	774 19TH	ST.	
AVE ST.	<u>19TH</u>	ST.	20TH	ST.	ST.
AVE. AVE.	AVE.	32N	BL 21ST STST.	ST.	
23RII 25TH 25TH 23RII 23RII 24TH 23RII AVE.	AVE 23RD1 ST AVE 2	STATE ROAD 585	NORTH BAY	CHELSEA	CAYUGA
ANITA MACHATIO			38TH 26TH 26TH	25TH ST	2
25TH 25TH 25TH 23RD 23RD 22ND	11. ST. 28TH H H ST. CHIPCO ST. 27TH AVE 27TH	33RD 5 5 5 5 5 5 5 5 5 5 5 5 5 5 5 5 5 5 5	ST.	ST. EMMA CHELSEA GENESSE	STICAYUGA
21. 2007H	THI	AVE AVE AVE	IDA	вотн	
			TAMDA, FLORIDA 33610	BELMONT HEIGHTS BASEBALL FEILD 2101 E. M.L. KING AVENUE	

PROJECT

NOTES

ALL CONSTRUCTION SHALL COMPLY WITH APPLICABLE CODES AND STANDARDS, INCLUDING BUT NOT LIMITED TO ALL STATE LAWS, LOCAL ORDINANCES, UTILITY COMPANY, FLORIDA ACCESSIBILITY CODE FOR BUILDING CONSTRUCTION, THE STANDARD MECHANICAL CODE, THE STANDARD PLUMBING CODE, THE OCCUPATIONAL SAFETY AND HEALTH ACT, NEPA AND THE CURRENTLY ADOPTED STANDARD BUILDING CODE.

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ITEMS OR AREAS DAMAGED BY THE CONTRACTOR OR SUBCONTRACTORS SHALL BE REPAIRED OR REPLACED AT THE CONTRACTOR'S EXPENSE.

SHALL SECURE ALL OPENINGS UNDER CONSTRUCTION

GENERAL CONTRACTOR SHALL YERIFY ALL DIMENSIONS AND EXISTING CONDITIONS PRIOR TO AND DURING CONSTRUCTION.

DEMOLITION WORK SHALL NOT BE LIMITED TO THESE DI COMPLETE PROJECT AS ILLUSTRATED, REMOVE ITEMS N ALLOW FOR NEW CONSTRUCTION.

NO STORAGE

 $\overline{\omega}$

AILABLE INSIDE STATIONS FOR CONTRACTOR USE.

CONTRACTOR SHALL REMOVE ALL DEBRIS FROM THE PROJECT SITE AS REQUIRED TO MAINTAIN A SAFE AND ORDERLY WORK ENVIRONMENT.

SQUARE FOOTAGE

SEC 7, 1295, ATLAS SHEET

, O

201

<u>70</u> 9 11

LEGAL

DESCRIPTION

ISSUE

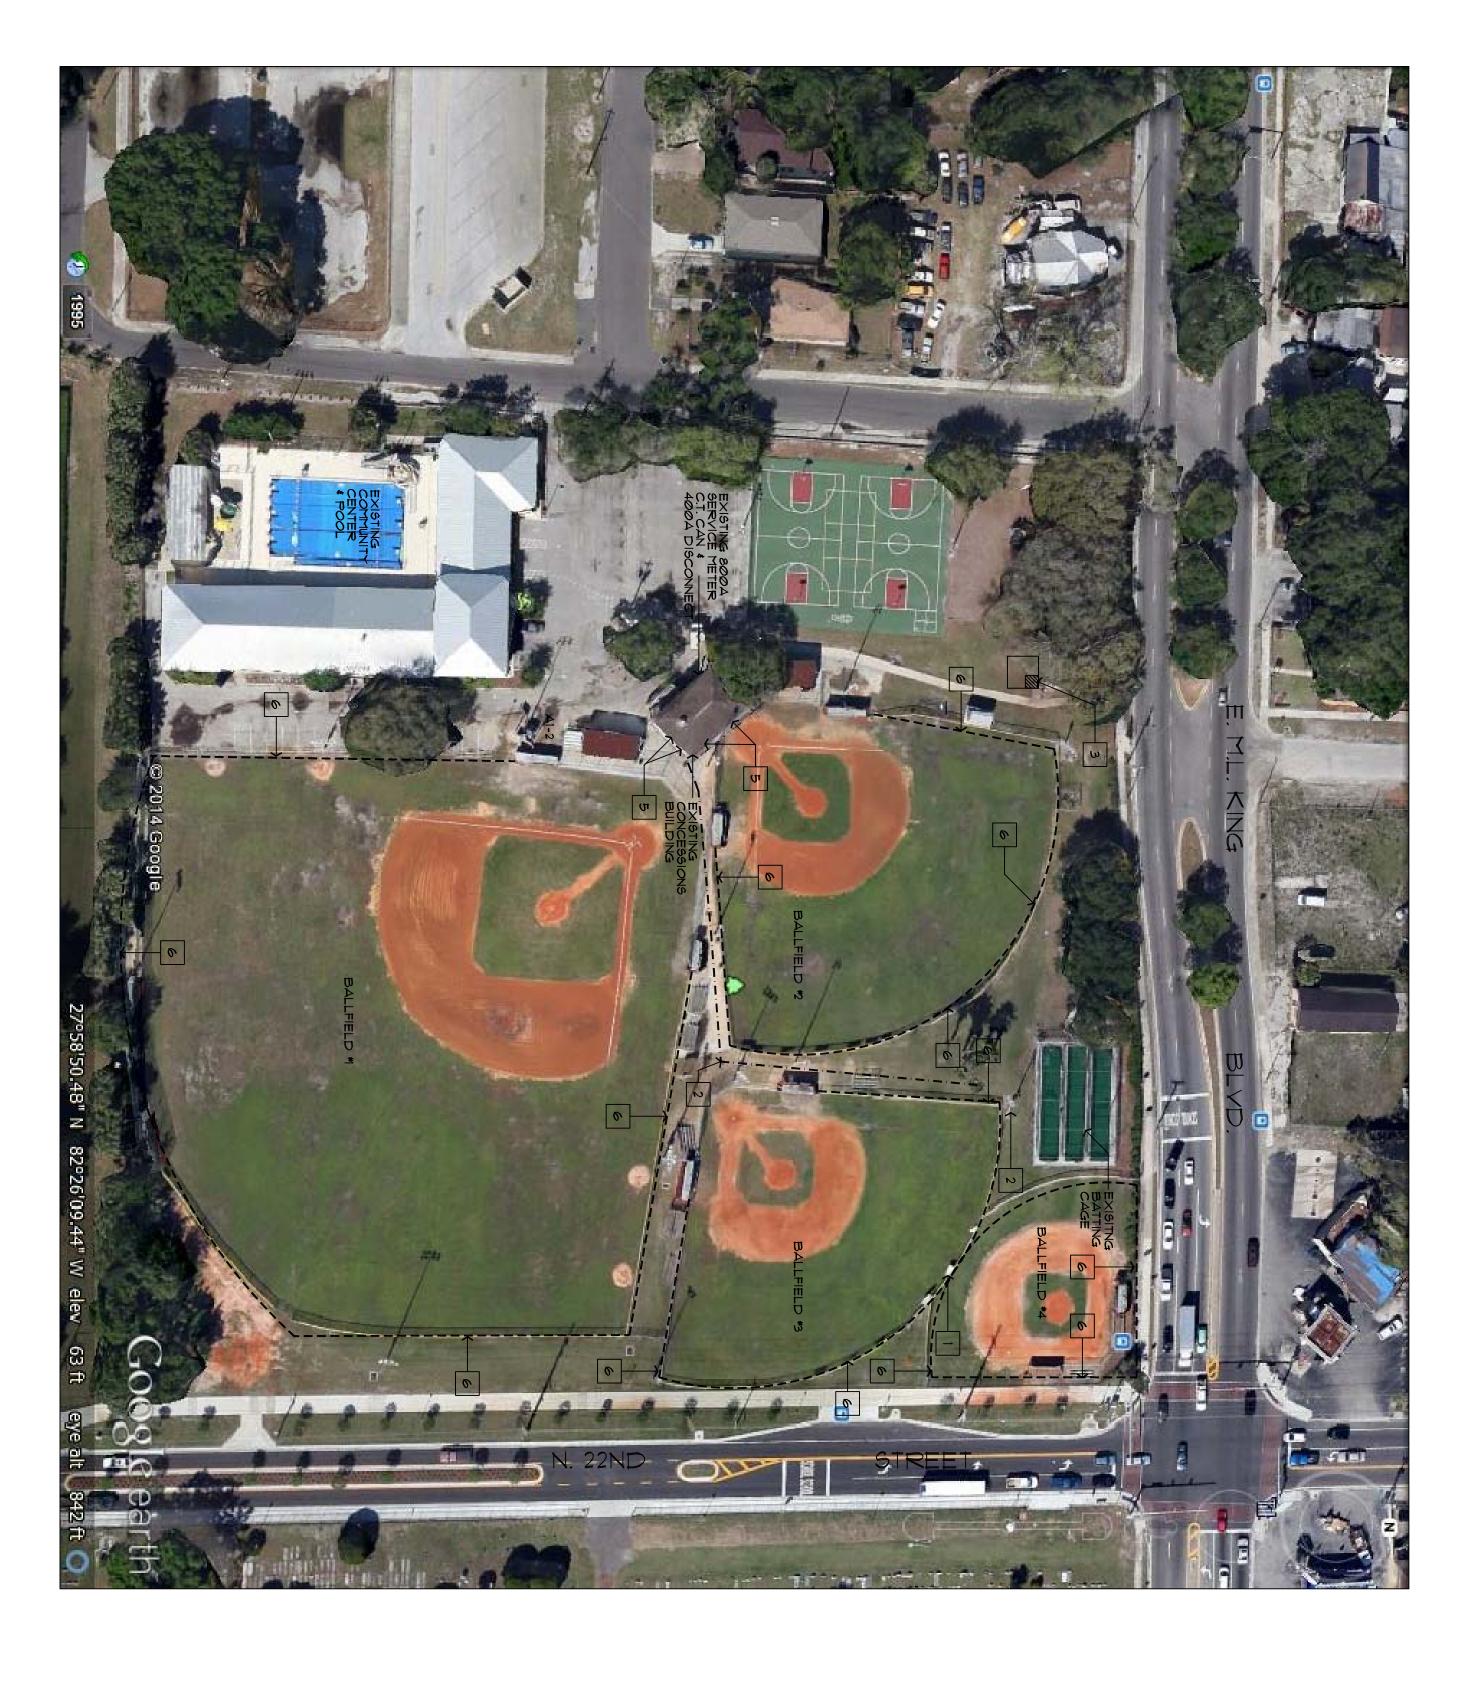
DATE

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NUMBER

CONTRACT ADMIN.

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FIELD * WILL THESE TOP DRESSING
OF CLAY WITH GRADING, SO ALLOWANCE
SECTION FOR INCLUDED IN BID PRICING
ACTUAL SCOPE TO BE CONFINED DURING
CONSTRUCTION

GENERAL NOTES

CITY OF TAMPA
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NEW 150W LUMARK NIGHTHAWK III LAMPS
OR EQUAL OR EXISTING POLE
APPROXIMATELY 20' ABOVE GROUND.
REMOVE EXISTING LIGHT.
DIRECTIONAL BORE NEW I" SCH.
40 PVC CONDUIT FOR NEW CIRCUIT IN CONCESSION BUILDING. CONTRACTOR TO CONFIRM CIRCUIT IDENTIFIED AND ROUTING OF CONDUIT. ALL BLDG.
PENETRATIONS TO BE CAULKED LIGHT FIXTURE AIM SHALL BE CLOSELY COORDINATED TO PREVENT SPILL ONTO TRAFFIC LANES.

EXISTING CANOPY / ELECTRICAL ROOM

CONSULTANT

N

NEW LITTLE LEAGUE SCOREBOARD TO REPLACE EXISTING SCOREBOARD ELECTRIC MECH MODEL NO. LX160 OR EQUAL FIELD VERIFY LOCATION. UTILIZE EXISTING ELECTRIC CONNECTION POINT.

KEY

NOTES

James E. Jackson, Jr. AIA, NOMA
City Architect
Edward D. Rice, AIA
Project Architect
Kevin L. Henika, AIA
Project Architect
Thomas A. Hester, Sr., AIA, NOMA
Project Architect
David R. Pagitt
Supervisor, Architectural Drafting
Kinsey C. Tillman
Drafting Technician
Jerry P. Sanders
Drafting Technician
Byron K. Thomas, LEED AP
Drafting Technician

STRUCTURAL CONSULTANT

ω 4 m

CIVIL CONSULTANT

LANDSCAPE CONSULTANT

NOT USED

PROVIDE 4' NEW LOUDSPEAKER IN EXISITNG BRACKETS AND PROTECTIVE ENCLOSURES MOUNTED TO EXTERIOR OF CONCESSIONS BUILDINGS,
LOUD SPEAKERS SHALL BE AMERICAN AUDIO DLS - 15P 15-INCH. 2-WAY SPEAKER OR EQUAL.

BELMONT HEIGHTS LITTLE LEAGUE UPGRADES 2101 E. M.L. KING BLVD. TAMPA, FLORDA 33610

ALL BALL FIELD FENCING AS SHOWN.
SCREENS SHALL BE OPEN MESH
5.5 OZ./SQ YD. WOVEN POLYPROPYLENE
FABRIC. ALL EDGES SHALL BE
REINFORCED WITH * BRASS
GRAMMENTS EVERY 12". WEIGHT SHALL
GREATER THAN Ø.60 OZ./S.F. WIND
POCKETS SHALL BE PROVIDED BY
COLORS TO BE SELECTED BY OWNER
OWNER, FROM MANUFACTURER STANDARD
WINDSCREEN IS LOCATED FROM
DUGOUT TO DUGOUT AROUND OUTFIELD
FOR FIELD *4

DPW FILE NUMBER DPW NUMBER

ISSUE DATE
SEPTEMBER 5, 2014

DRAWN BY
JERRY P. SANDERS

REVISIONS

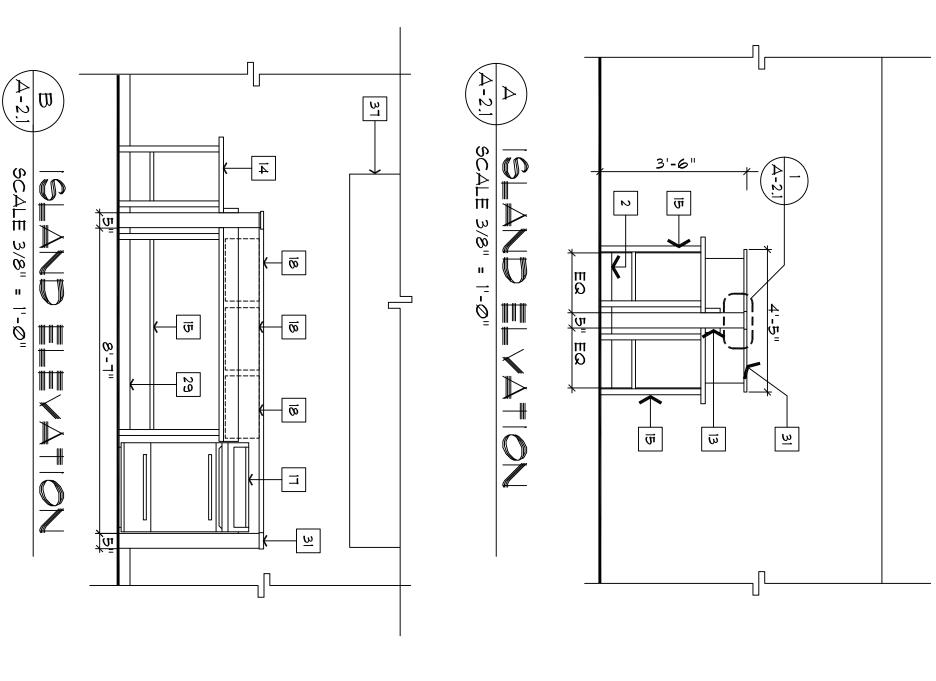
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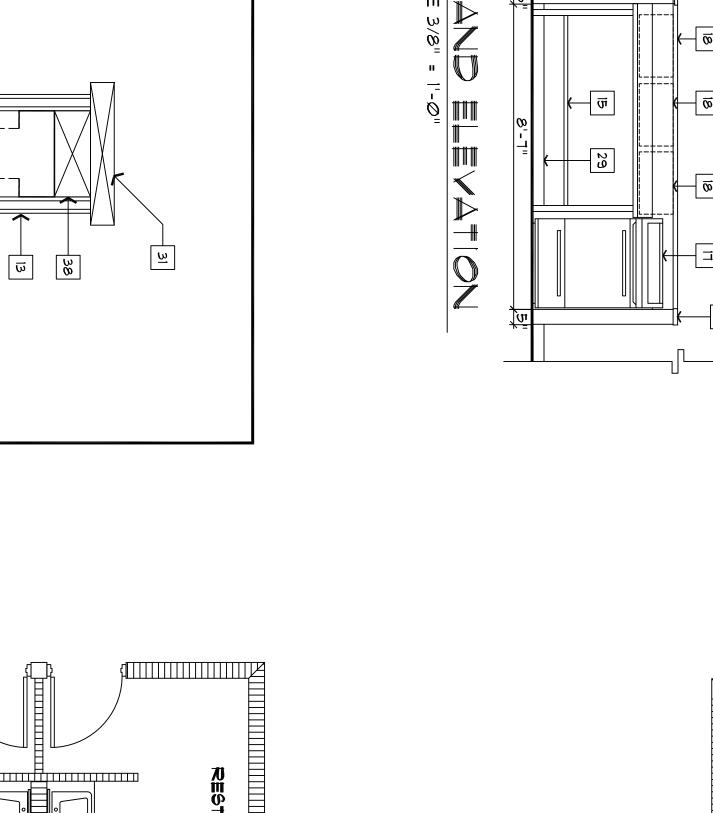
SITE PLAN

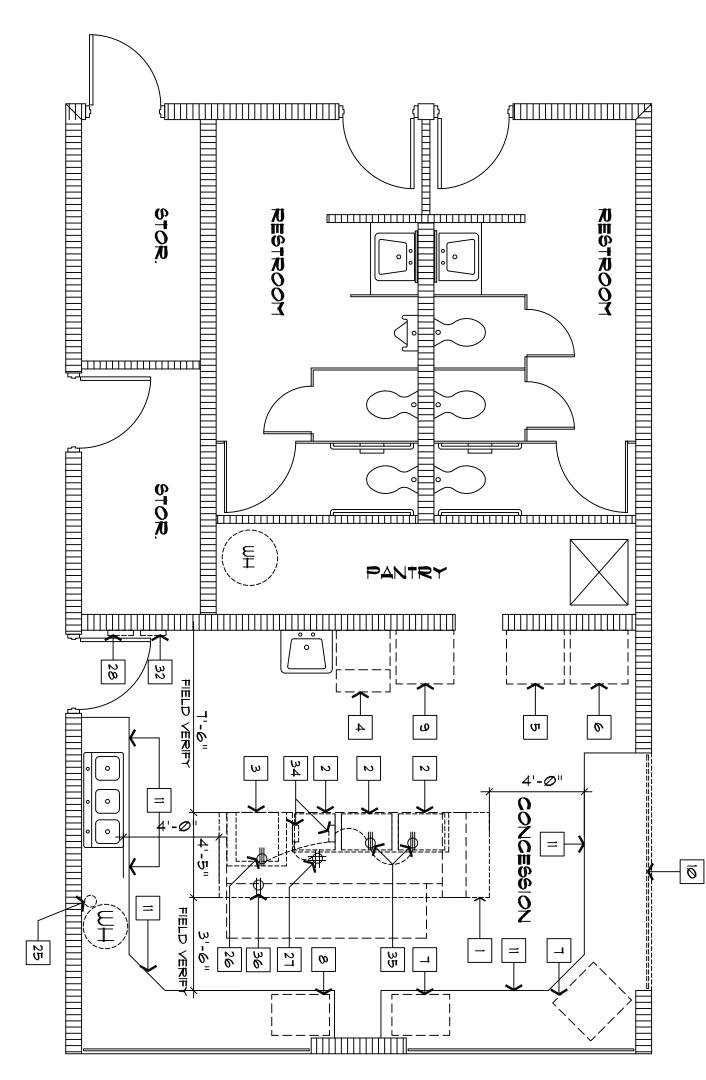
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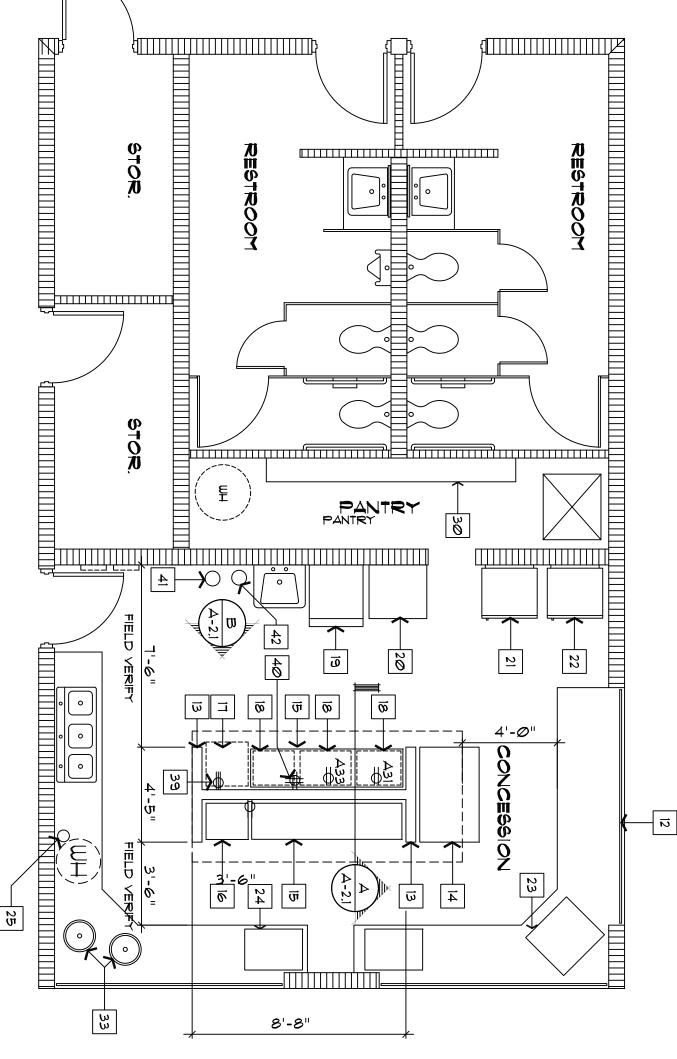
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GENERAL NOTES

CONTRACTOR TO PROVIDE SHOP DRAWINGS FOR ALL ITEMS OF WORK 2ND FLOOR OF CONCESSION BUILDING NOT IN CONTRACT. COLOR FOR ALL APPLIANCES TO BE SELECTED FOR STANDARD RANGE OF COLORS.

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Jerry P. Sanders
Drafting Technician

KEY

NOTES

Byron K. Thomas, LEED AP Drafting Technician

MP CONSULTANT

REMOVE EXISTING COUNTER AND STORAGE
REMOVE EXISTING DOUBLE FRYERS (3)
REMOVE EXISTING STOVE
REMOVE EXISTING ICE MACHINE
REMOVE EXISTING STAND - UP
BEVERAGE COOLER

STRUCTURAL

REMOVE EXISTING REFRIGERATOR
REMOVE EXISTING COUNTER TOP DRINK
REFRIGERATOR (2)

REMOVE EXISTING COUNTER TOP FOOD
WARMER.
REMOVE EXISTING CHEST FREEZER
TO BE REMOVED.
REMOVE EXISTING CABINET DOORS
TYP.

CONSULTANT

PROVIDE NEW SHUTTER 10'W × 4'H (VERNEY)

CIVIL CONSULTANT

LANDSCAPE CONSULTANT

13 NEW 42" HIGH PARTITION WITH 20 GAUGE 35%" STUDS 16" O.C. W/ 5%" TYPE 'X' GYPBD. EA. SIDE PAINTED.

14 NEW 30" x 48" STAINLESS STEEL WORK TABLE WITH UNDER SHELF AND 5"
BACK SPLASH ADVANCE TABCO MODEL NO. KSS - 304 OR EQUAL.

NEW 24" × 30' STAINLESS STEEL TABLE ADVANCE TABCO MODEL NO. KSS -240 OR EQUAL

NEW ELECTRIC STOVE GE MODEL JB 1000N OR EQUAL.

NEW ELECTRIC DOUBLE FRYERS. (3)
ADCRAFT MODEL DF / 6L/ 2 OR EQUAL

NEW 24" x 12" STAINLESS STEEL WOTTABLE WITH UNDER SHELF AND 5" BACK SPLASH, ADVANCE TABCO MODEL NO. KSS - 246 OR EQUAL

BELMONT HEIGHTS LITTLE LEAGUE UPGRADES 2101 E. M.L. KING BLVD. TAMPA, FLORIDA 33610

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NEW COUNTER TOP FOOD WARMER ADCRAFT MODEL NO. HD - 36 OR OR EQUAL.

NEW REFRIGERATOR GE MODEL

NEW COUNTER TOP DRINK COOLER.

NEW UPRIGHT BEVERAGE REFRIGERATOR HABCO MODEL NO. SE24M OR EQUAL.

NEW UPRIGHT FREEZER GE MODEL NO. FUM216VRWW OR EQUAL.

NEW AUTOMATIC ICE MACHINE . MANITOWOC INDIGO SERIES MODEL 322 OR EQUAL.

EXISTING WALL MOUNTED ANSUL SYSTEM TO REMAIN.

REVISIONS

RELOCATED IN NEW WALL

TO BE RELOCATED IN NEW WALL.

30 PROVIDE VINYL COATING WIRE SHELVES (5) ROWS. WITH HEAVY DUTY BRACKET.

I" THICK BY 5" GRANITE SILL CONTINUES. SET IN MASTIC. EXISTING PANEL "K"

28 EXISTING PANEL "A".

FLOOR PLANS SCALE: VARIOUS

33 NEW 4-QUART COMMERCIAL CROCK POT WEST BEND MODEL NO. 84384
34 REMOVE EXISITING UNDER COUNTER ELECTRICAL JUNCTION BOXES
TERMINATE CONDUIT AND CAP.
35 REMOVE EXISTING OUTLET AND COUDUITS FROM UNDER COUNTER, CAP CIRCUIT AT PANEL.

SHET NUMBER

31 EXISTING HOOD

38 P.T. 2X NAILER CONTINUOUS

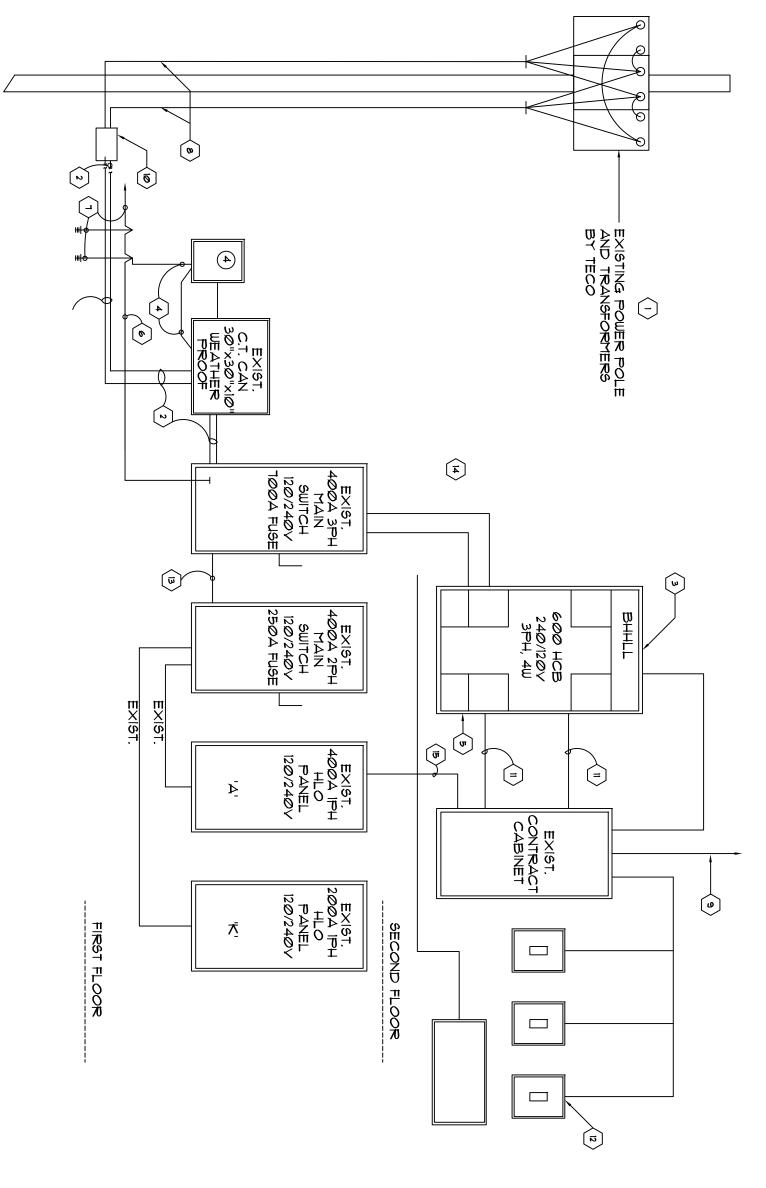
39 RELOCATED 220Y OUTLET

40 RELOCATED 120Y QUAD OUTLET

EXISTING 120Y DUPLEX RECEPTACLE TO BE RELOCATED IN NEW WALL.

41 PROVIDE NEW TYPE 'K' EXSTINGUISHER UL RATED K, 1516 IN STAINLESS STEEL CERTAI CONTAINER BY LARSEN OR EQUAL WITH WALL MAUNTED BRACKETS.
42 EXISTING FIRE EXSTINGUISHER.

A2.1



EXISTING TAMPA ELECTRIC COMPANY POLE MOUNTED TRANSFORMER (SECONDA AVAILABLE SHORT CIRCUIT CURRENT ON SECONDARY SIDE BUSHING OF TRANSFORMERS 31 221 AMPS. SYMMETRICAL. CALCULATED AVAILABLE SHORT CIRCUIT CURRENT AT LINE SIDE OF SERVICE ENTRANCE MAIN CIRCUIT BREAKER 26, 913 AMPS. SYMMETRICAL MAXIMUM LET-THROUGH CURRENT ON LOAD SIDE OF SYMMETRICAL MAXIMUM LET-THROUGH CURRENT ON LOAD SIDE OF SYMMETRICAL. RECONFIRM AVAILABLE SHORT CIRCUIT BREAKER = 26, 913 AMPS SYMMETRICAL. RECONFIRM AVAILABLE SHORT CIRCUIT BREAKER = 26, 913 AMPS SYMMETRICAL. RECONFIRM AVAILABLE SHORT CIRCUIT CURRENT FOR ACTUAL TRANSFORMER BEING INSTALLED WITH UTILITY COMPANY PRIOR TO ORDERING EQUIPMENT OR COMMENCING WORK. TRANSFORMER (SECONDARY: 600

EXISTING SERVICE ENTRANCE CONDUCTORS 2 SET EACH 4 *500 KCM THUN IN 3" CONDUIT.

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4

- aEXISTING MAIN DISTRIBUTION PANEL, "BMHLL" SEE SCHEDULES (42,00 AMPS AIC SYMM RATING)
 PROVIDE SERIES CONNECTION RATING BETWEEN MAIN BREAKERS, SUB-MAIN BREAKERS AND
 BRANCH CIRCUIT BREAKERS DOWNSTREAM PER UL OR OTHER TESTING LAB. TESTING PROCEDURES
 EXISTING METER BY TECO PROVIDE 11/4" RGS CONDUIT, SURFACE MOUNTED ON BLDG NIPPLED TO C.T.
 CAN. GROUND METER CAN & C.T. CAN TO BUILDING SERVICE GROUND WITH *4 SOLID COPPER.
 EXISTING LIGHTING SURGE ARRESTORS AND SURGE PROTECTORS, 80 KA PER PHASE, 500Y CLAMP VOLTAGE SINGLE IMPULSE LINE TO GROUND, LINE TO NEUTRAL AND NEUTRAL TO GROUNDING RATING. CAPABLE OF PROTECTING AGAINST AND SURVIVING 2000 TRANSIENTS PER ANSI / 1 EEE C62.41 CATEGORY C, WITHOUT FAILUF OR DEGRADDATION OF UL 1449 CLAMP VOLTAGE BY MORE THAN 10% FAILURE
- EXISTING *3/0 IN 3/4" C (RGS) MAIN BUILDING SERVICE GROUND WIRE, MAKE GROUND CONNECTION AS SHOWN, FIELD COORDINATE EXACT LOCATION.
- EXISTING 3/4' x20'-0" LONG COPPER CLAD STEEL (SEE SPECS) GROUND RODS DRIVEN INTO GROUND AT 10'-0" (MIN.) APART, MAKE GROUND CONNECTIONS TO MAIN BUILDING GROUND CONDUCTOR,, AS SHOWN AND TO MAIN COLD WATER STEEL PIPE AND TO BUILDING STRUCTURAL REINFORCED RE-BARS.
- EXISTING POLE, CONDUIT, & WIRING BY . 1⊞CO.
- EXISTING (2) 3" CONDUITS TO 30" imes 30" imes 8" WP PULL BOX ON OUTSIDE WALL

W

- IØ EXISTING HANDHOLE WITH TRAFFIC COVER, FOR CONNECTION OF TECO WIREING BY TECO. FINAL CONNECTIONS BY TECO. TO CUSTOMER WIRING
- EXISTING 2" CONDUIT FOR LIGHTING & CONTROL CONDUCTORS

=

- EXISTING LIGHTING "ON OFF" SWITCHES AS SHOWN ON PLAN WITH 2*10 THWN CONDUCTORS PER SWITCH.
- EXISTING (4) 500 KCM THWN CU & (1) #3 THWN IN 3" RGS CONDUIT NIPPLE, COMPLY WITH 10' TAP RULE, ARTICLE 240-21 (6), NEC, NEPA 10.

 EXISTING 2 SET (4) 500 KCM THWN CU 7 (1) #1/0 THHN CU IN 3' RGS CONDUIT.

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PANEL ' A ' 120/24 +V., 1+., PANEL -3W, 400 A. M.L.C. W/ 1-125A/ 2 SCHEDULE WIRE SIZE #12 -LIGHT KIT, & OVERHANG LIGHTS - 2ND FL OVERHNG LIGHTS - GEN. PUP. RM LIGHTS - 2ND FL FILM RM. REC. 2ND FL GN. P. RM SCORE BOARD SR. REC. KITCHEN DISPENSER ICE MAKER POP CORN MACHINE. TOILETS - EXPAN. NO.! MAJOR SCORE BOARD SPACE SPACE NEW FRYER PHASE <u>ш</u> 70 O C C C D D D D D D D Ω ∀ ⊞ Τ 30 125 <u>ø</u> 0 *Ö*. LIGHTS - MEN TOILET LIGHTS - WOMEN TOILET REC. 2ND FL. FILM PM. REC. 2ND FL. GNP R.M. REC. 1ST FL B RM & WP REFRIGERATOR FREEZER DISPENSER REC. KITCHEN REC. P.A. SYSTEM HOOD SPARE Z III E BATTING CAGE REMARKS LIGHTING

7 0 ≤4	NEL - K - 120	3/24Ø ¢V., 14	°., 3W 200 A.1	PANEL 'K' 120/240 +V., 1+., 3W 200 A. M.L.C 10,000 A.I.C. W/2 POLE, 1+240 V	U/2 POLI	≣, 1¢24Ø	<		
<u>\(\frac{2}{2} \)</u>	100 CHII &	\\\\\\\\\\\\\\\\\\\\\\\\\\\\\\\\\\\\\	CONDUIT &	ZETARX6	<u>V</u>	О О N	AMPS	CONDUIT SIZE *	NET ARKG
_	_	20	#12 - 1/2" C	BATH HAND DRYER	2	2	30	#12 - 1/2" C	* T70 / H 70
W	ı	200	#12 - 1/2" C	BATH HAND DRYER	4	2			
(JI					0	2	50	#6 - 1/2" C	AND THE
7	2	30	#6 - 1 = C	HEAT LAMPS	8				
9					Ø	2	30	-	SPARE
=	2	30	*6 - · C	#2 FRYER	12				

ISSUE DATE
SEPTEMBER 5, 2014

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DRAWN BY
JERRY P. SANDERS

REVISIONS

SEAL

SHEET NUMBER

A2.2

EXISITNG ELECTRICAL INFO.

SCALE: N.T.S.

					KEY NOTES			TELECTRICAL DRAWING FOR INFORMATIONAL AND COORDINATION PURPOSES. DRAWEING DOCUMENTS	
BELMONT HEIGHTS LITTLE LEAGUE UPGRADES 2101 E. M.L.K. BLVD. TAMPA, FLORDA 33610	LANDSCAPE CONSULTANT	CIVIL CONSULTANT	STRUCTURAL CONSULTANT	MEP CONSULTANT	Project Architect David R. Pagitt Supervisor, Architectural Drafting Kinsey C. Tillman Drafting Technician Jerry P. Sanders Drafting Technician Byron K. Thomas, LEED AP Drafting Technician	Jackson, Jr. AIA, N litect D. Rice, AIA rchitect Henika, AIA rchitect	CITY OF TAMPA CONTRACT ADMINISTRATION DEPARTMENT PLANNING AND DESIGN DIVISION 306 E. JACKSON STREET 4 NORTH TAMPA, FLORIDA 33602 p: 813. 274. 8456 - f: 813. 274. 8080 urt www.tampagov.net		

KEY