
The Enclosed Document Is Provided For Your Convenience.

Please Email ALL Questions:

MailTo:ContractAdministration@TampaGov.net

Please Let Us Know If You Plan To Bid

City of Tampa
Contract Administration Department
306 E. Jackson St. #280A4N
Tampa, FL 33602
(813)274-8456

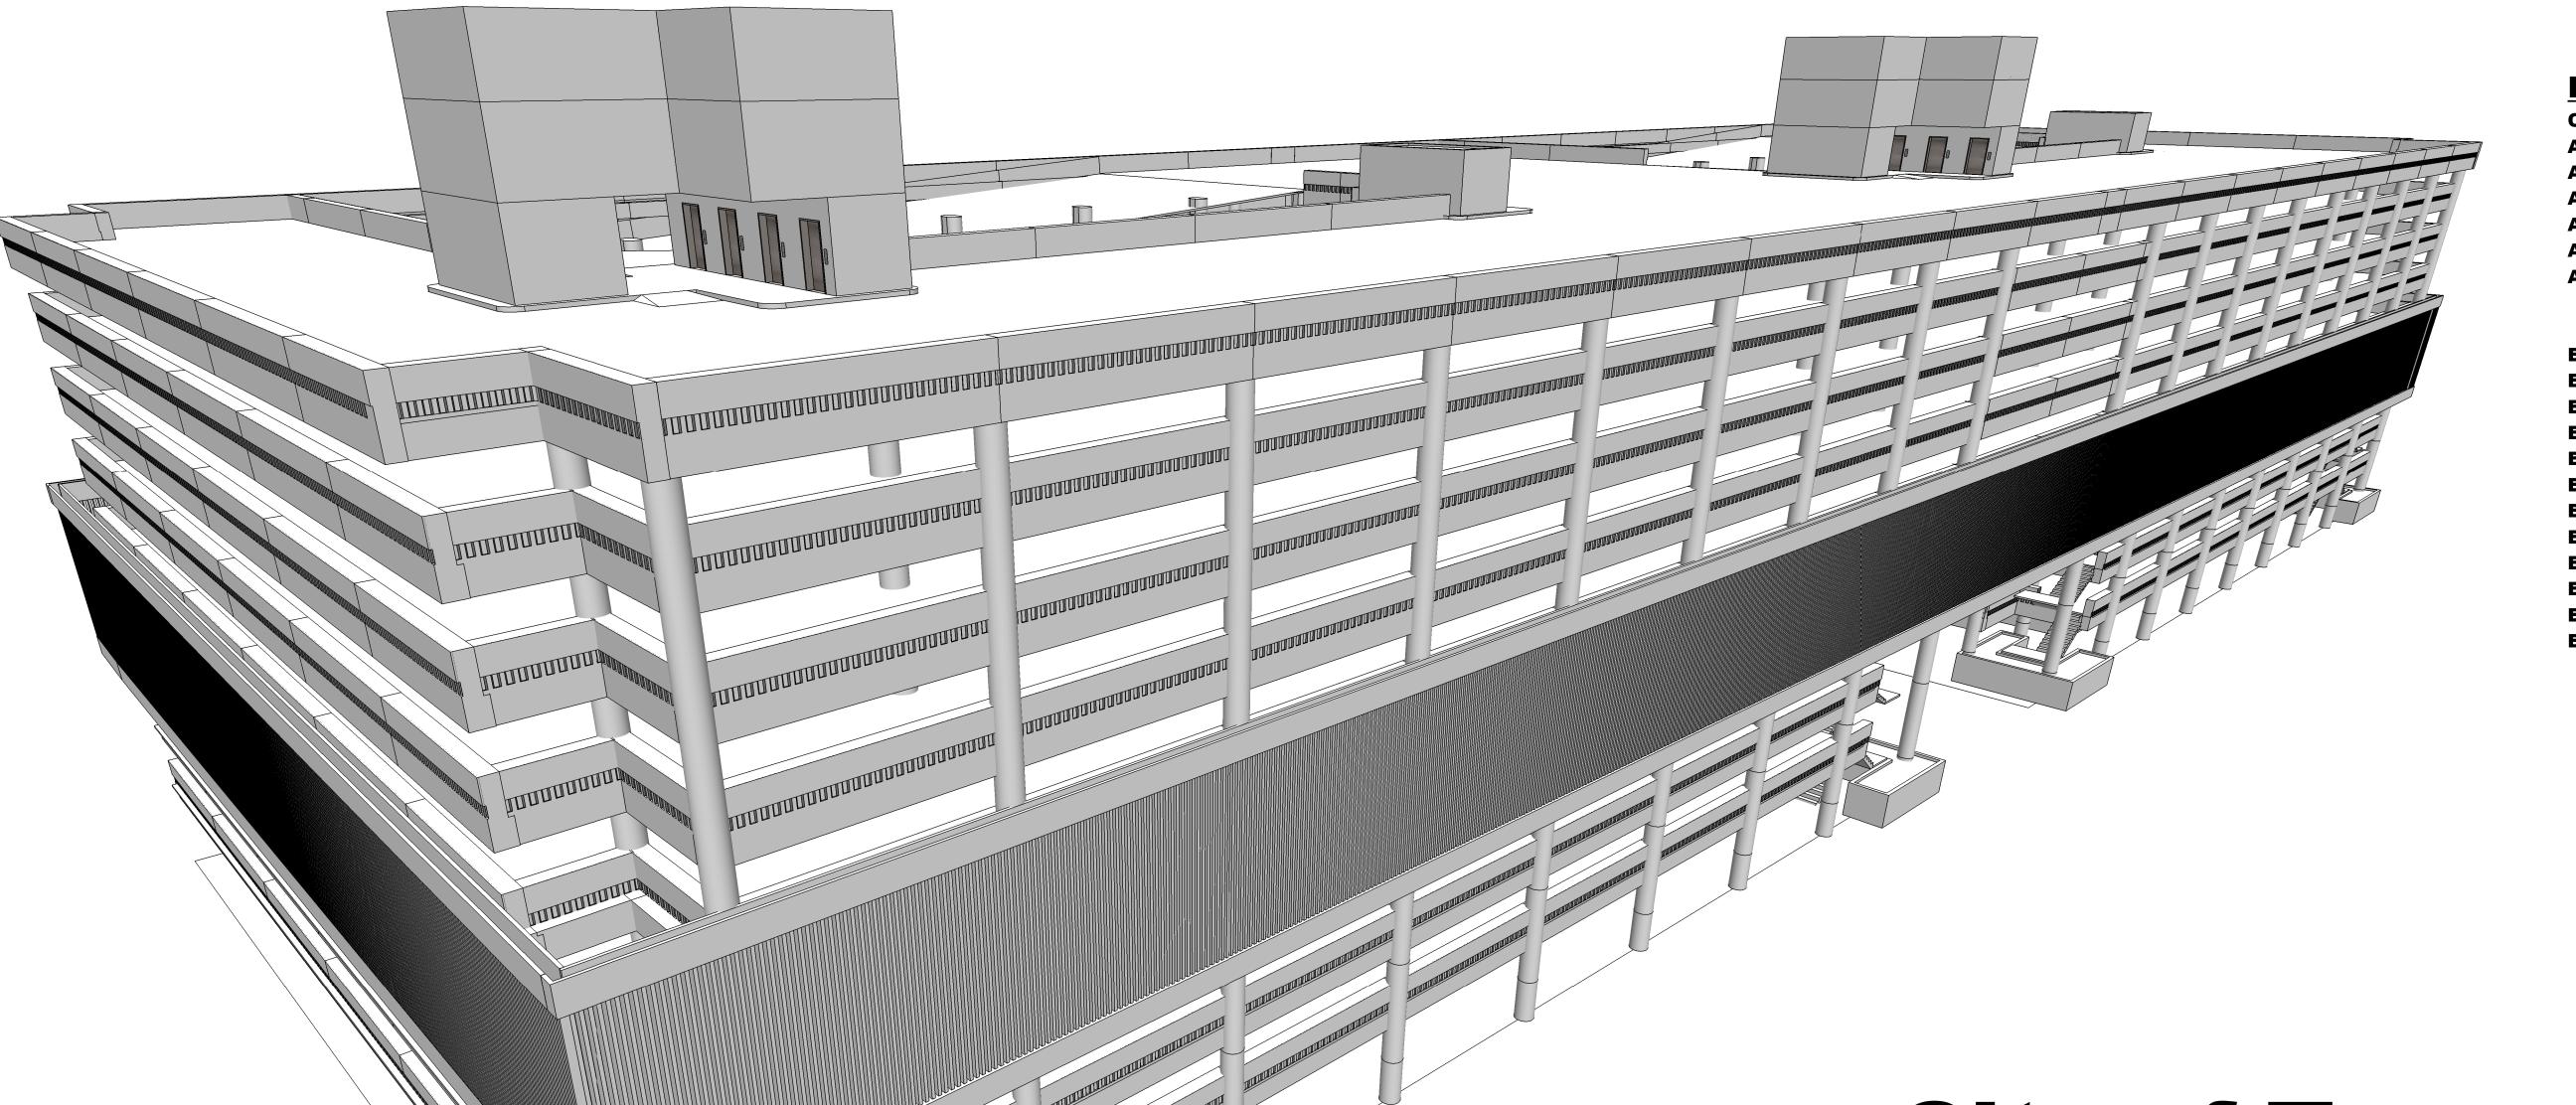

DRAWING LIST:

COVER

ARCHITECTURAL

SITE PLAN **FLOOR PLANS**

FLOOR PLANS

FLOOR PLANS BUILDING SECTIONS

ELECTRICAL

ELECTRICAL COVER SHEET

ELECTRICAL ELEVATION

ELECTRICAL ROOF PLAN

ELECTRICAL PENTHOUSE PLAN

GROUND FLOOR ELECTRICAL PLAN

ELECTRICAL POWER RISER ELECTRICAL PANELS

FA PLAN GROUND FLOOR

FA PLAN FLOORS 2-10

FA DETAILS

FA DETAILS

City of Tampa Fort Brooke Parking Garage

Elevator Improvements Tampa, Florida Date: MARCH 2015

CONTRACT No.: 15-C-00031

Architect:

Mechanical and Electrical Engineers:

Elevator Consultant:

Design Harmonics Architecture, Inc Griner Engineering, Inc

Vertical Assessment Associates

ISSUE

03-20-15

PROJECT NO.

CONSTRUCTION DOCUMENTS

GENERAL NOTES - SITE:

2 PROVIDE BARRICADES, ETC. AS REQUIRED TO MAINTAIN PUBLIC SAFETY AT ALL TIMES.

GARAGE OPERATIONS.

CONSTRUCTION.

1 SEE FT. BROOKE GARAGE SPECIFICATIONS FOR ACCESS REQUIREMENTS AND LIMITATIONS.

FT. BROOKE PARKING GARAGE SHALL REMAIN IN

BROOKE GARAGE REPRESENTITIVES MINIMUM 48

PRIOR TO DOING ANYTHING THAT MIGHT AFFECT

CONTRACTOR SHALL VERIFY ALL SITE CONDITIONS AND OBTAIN RESOLUTIONS TO CONFLICTS PRIOR TO

PROVIDE PROTECTIVE MEASURES AS REQUIRED AND

AND SAFE PASSAGE OF CITY OF TAMPA PERSONNEL

AND THE GENERAL PUBLIC TO AND FROM AREAS OF THE GARAGE, INCLUDING THE EXTERIOR PERIMETER AREAS AT GRADE.

APPROPRIATE FOR THE CONDITIONS TO PROVIDE FREE

FULL OPERATION AT ALL TIMES. PROVIDE CITY AND FT.

HOURS ADVANCE NOTICE FOR REVIEW AND APPROVAL

Comm. No. 14-030 AS NOTED 03-20-15

Checked: WR







STAIRWELL#3

ELEVATOR UPGRADES

3 GARAGE SITE PLAN - FLOOR 1

BASE BID limited to the north core/elevator

core/elevator improvements)

improvements and fire alarm system upgrade (both elevator cores, auto-dialer in office area, etc), and will include an ALTERNATE for the remaining scope (south

NOTES:

AND ASSOCIATED

NORTH FLORIDA AVENUE

STAIRWELL#1

S. FRANKLIN STREET

ELEVATOR UPGRADES

AND ASSOCIATED



LEGAL DESCRIPTION:

SECTION 24 -TOWNSHIP 29S - RANGE 18E ATLAS SHEET: I-12 FLOOD ZONE: X

CONTRACTORS ARE TO VISIT THE SITE AND FAMILIARIZE THEMSELVES WITH EXISTING CONDITIONS AND SATISFY THEMSELVES AS TO THE NATURE AND SCOPE OF WORK. THE BASE BID SHALL REFLECT MODIFICATIONS TO SYSTEMS AND DEVICES AS REQUIRED BY STATE AND LOCAL CODES AND REQUIREMENTS INDICATED ON PROJECT DOCUMENTS. THE SUBMISSION OF A BID WILL BE EVIDENCE THAT SUCH AN EXAMINATION AND COMPLIANCEWITH GOVERNING CODES/REQUIREMENTS HAS BEEN MADE. LATER CLAIMS FOR LABOR, EQUIPMENT, OR MATERIALS REQUIRED, OR FOR DIFFICULTIES ENCOUNTERED WHICH WOULD HAVE BEEN FORESEEN HAD AN EXAMINATION AND

CLASS AND WORKMANLIKE MANNER AND WITH NEW MATERIALS.


CODE/REQUIREMENTS REVIEW BEEN MADE, WILL NOT BE ALLOWED.

CONTRACTOR SHALL COMPLY WITH ALL REQUIREMENTS OF THE OWNER REGARDING COORDINATION OF WORK IN THE BUILDING.

ALL PENETRATIONS THROUGH FIRE RATED WALLS SHALL BE RESEALED TO THE ORIGINAL FIRE RATINGS WITH 3M #303 FIRE SEAL PUTY OR APPROVED EQUAL.

CONSTRUCTION NOTES:

ALL WORK PERFORMED BY CONTRACTORS SHALL BE PERFORMED IN A FIRST

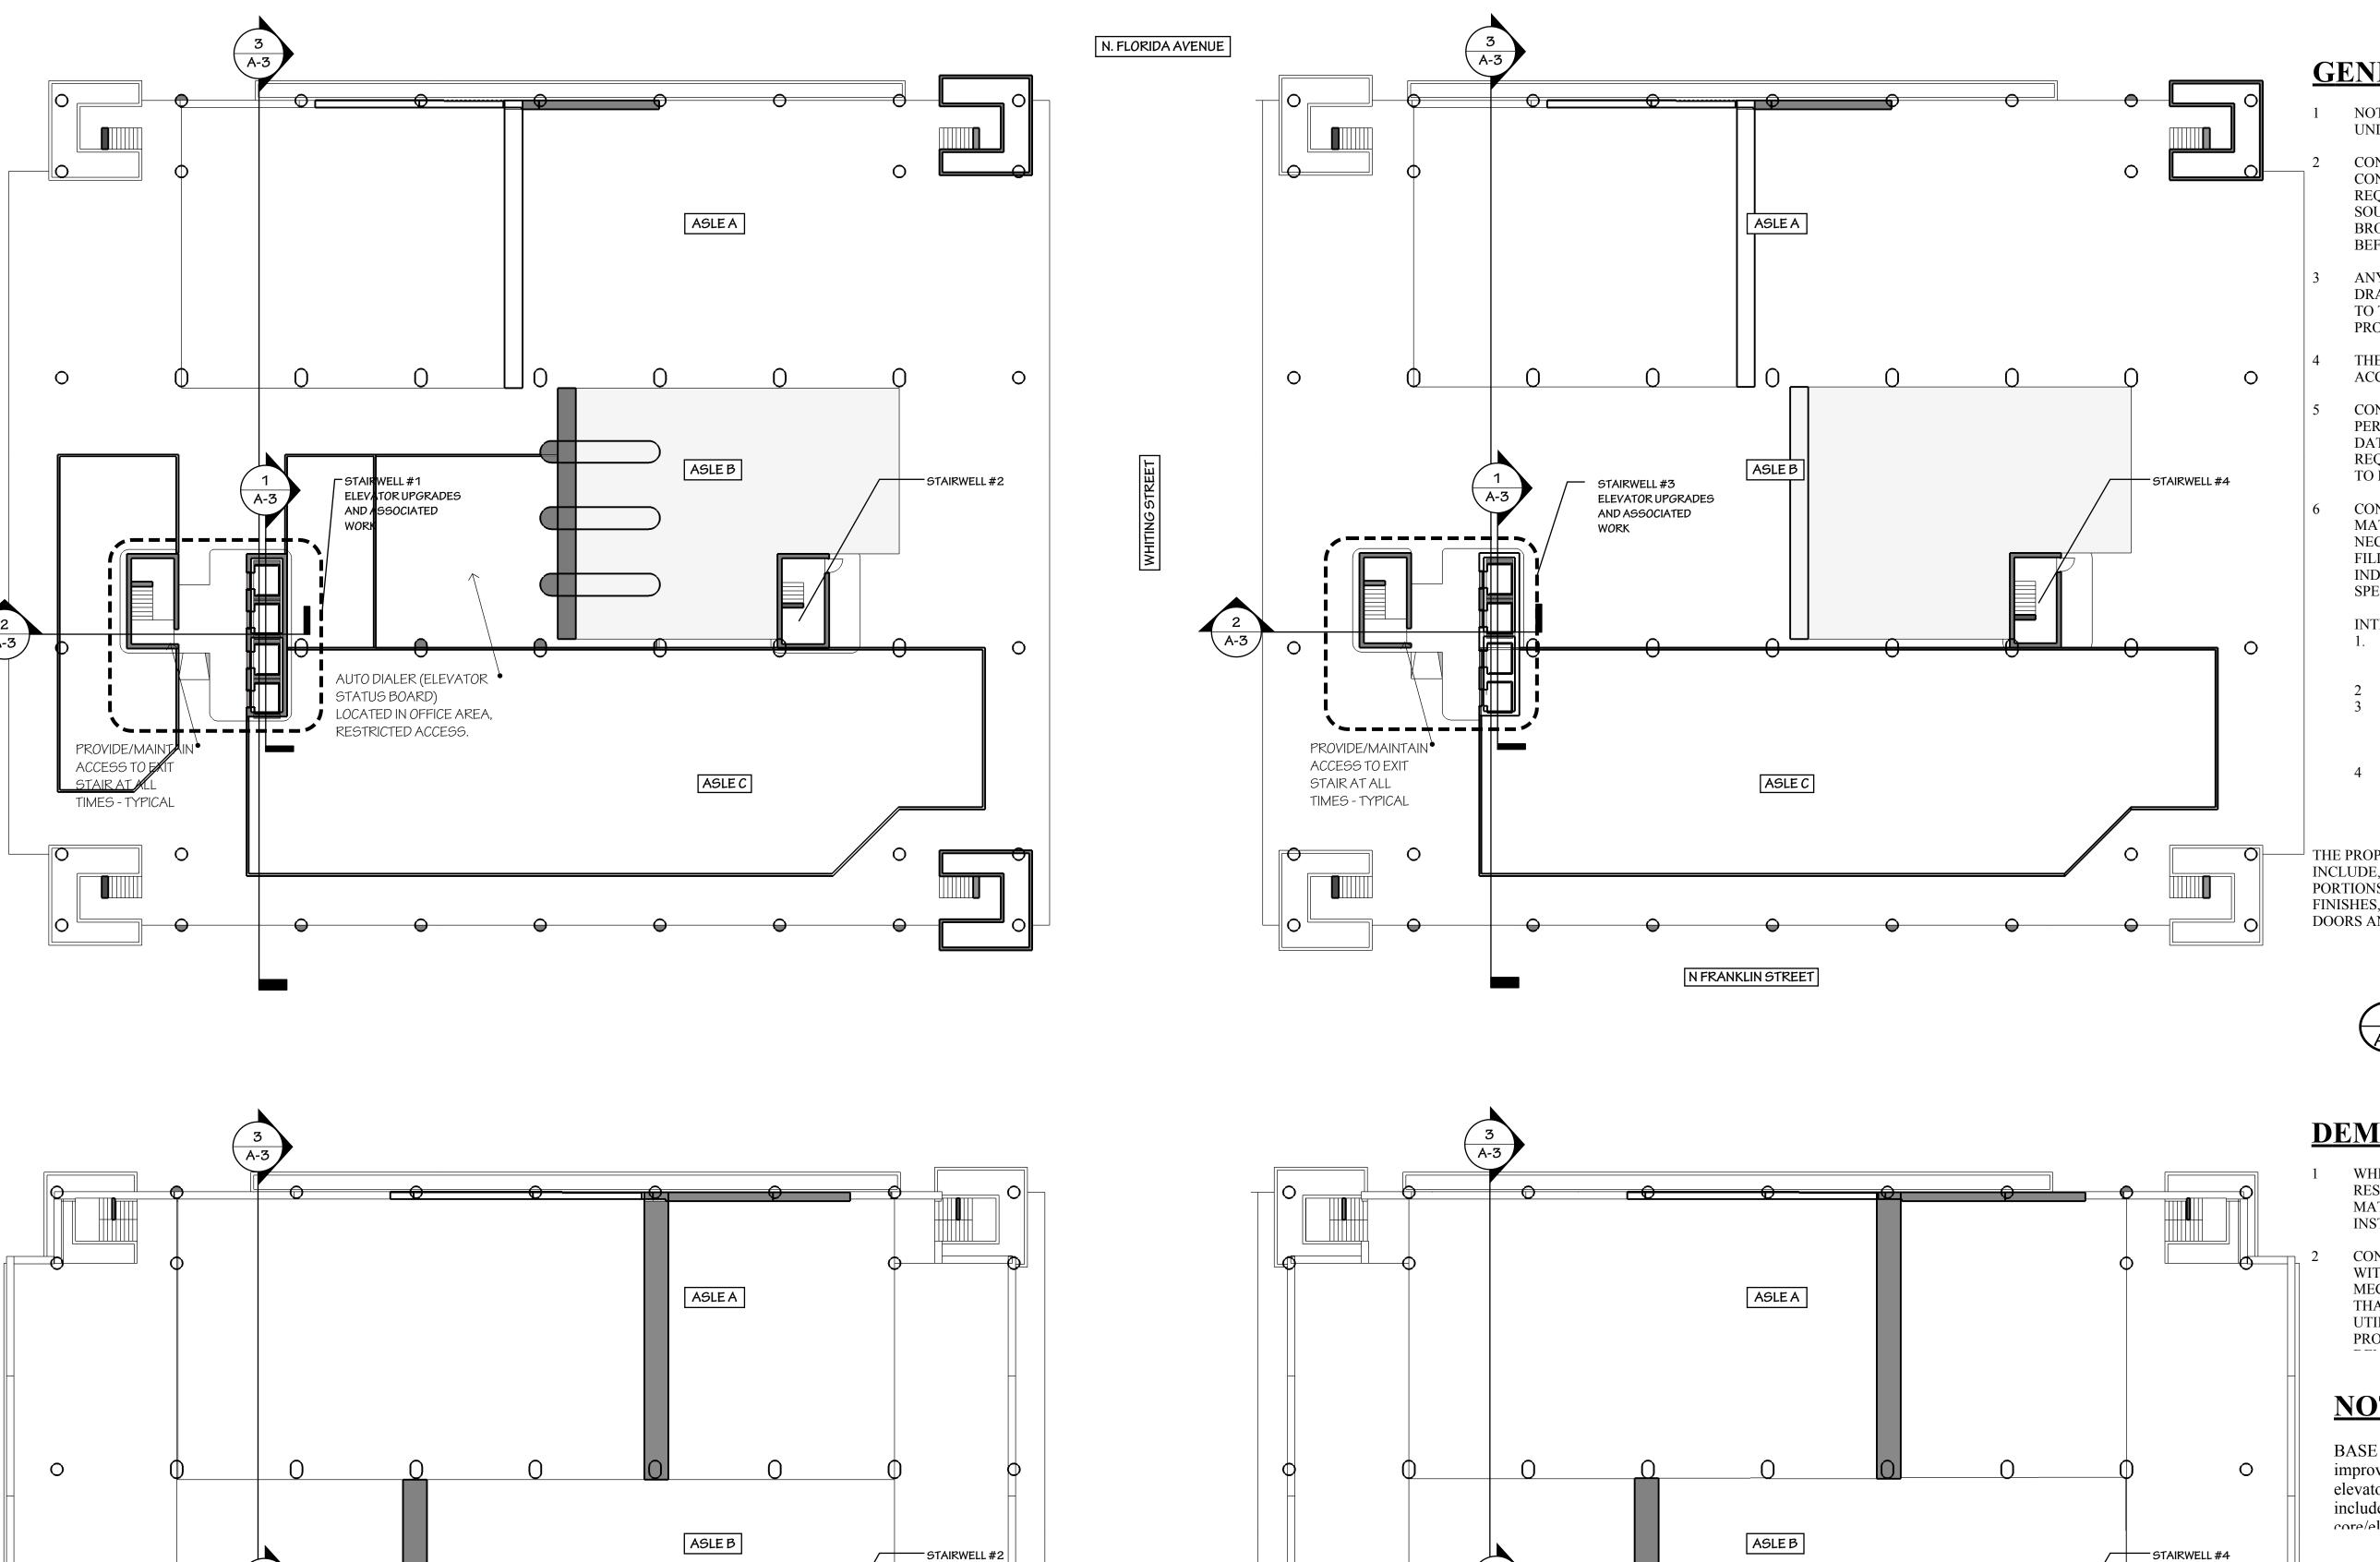

A-3

PROVIDE/MAINTAIN

ACCESS TO EXIT

TIMES - TYPICAL

STAIR AT ALL

STAIRWELL#1

ELEVATOR UPGRADES

ASLE C

AND ASSOCIATED

GENERAL NOTES:

GENERAL NOTES.

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THE PROJECT COMPLIES WITH THE ADA ACCESSIBILITY CODE FOR BUILDING CONSTRUCTION.

CONTRACTOR SHALL FURNISH COPIES OF ALL PERTINENT PRODUCT APPROVALS, PERFORMANCE DATA AND INSTALLATION INSTRUCTIONS OR REQUIREMENTS TO THE INSPECTOR FOR REVIEW PRIOR TO INSTALLATION.


6 CONTRACTOR SHALL FURNISH ALL LABOR,
MATERIALS, SCAFOLDING, TOOLS AND EQUIPMENT
NECESSARY TO COMPLETE PAINTING, SEALING AND
FILLING REQUIREMENTS OF THE PROJECT AS
INDICATED ON THE DRAWINGS AND DESCRIBED IN THE
SPECIFICATIONS.

INTERIOR ITEMS (NOT LIMITED TO:)

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- PANELS, MISCELLANEOUS TRIM AND SURFACES
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NOTES:

BASE BID limited to the north core/elevator improvements and fire alarm system upgrade (both elevator cores, auto-dialer in office area, etc), and will include an ALTERNATE for the remaining scope (south core/elevator improvements)

PHASING:

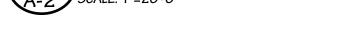0

STAIRWELL#3

PROVIDE/MAINTAIN*

ACCESS TO EXIT

TIMES - TYPICAL

STAIR AT ALL

AND ASSOCIATED

ELEVATOR UPGRADES

ASLE C

KEEP MINIMUM OF 2 ELEVATORS, PER CORE, IN OPERATION PER SPECIFICATION SECTION 14210.





BROOKE PARKING GARAGE TOR IMPROVEMENTS

PROJECT ADDRESS 107 N Franklin St

ArchitectureAA 26001084

S5910 Murrell Road, #509

Sockledge, FL 32955

S030 N Rocky Point Drive, Ste 150

et Title:

Sheet Title:
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FLOOR PLANS

Comm. No. 14-030
Scale: AS NOTED

Date: 03-20-15

Drawn: WR

Checked: WR

Revised:

Sheet No.

A - 2

ASLE A

ASLE B

ASLE C

STAIRWELL#1

ELEVATOR UPGRADES

AND ASSOCIATED

0

PROVIDE/MAINTAIN •

ACCESS TO EXIT

TIMES - TYPICAL

STAIR AT ALL

0

STAIRWELL#2

CONSTRUCTION NOTES:

ASLE A

ASLE B

ASLE C

STAIRWELL#3

PROVIDE/MAINTAIN*

ACCESS TO EXIT

TIMES - TYPICAL

STAIR AT ALL

AND ASSOCIATED

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NOTES:

0

STAIRWELL#4

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PHASING:

KEEP MINIMUM OF 2 ELEVATORS, PER CORE, IN OPERATION PER SPECIFICATION SECTION 14210.

GARAGE FLOOR PLAN - FLOOR 7

(OTHER FLOORS SIMILAR)

A-2.1 SCALE: 1"=20'-0"

All dimensions and job condition shall be checked by the contract who shall be responsible for the same; any and all discrepencies shall be reported to the architect prior to the start of construction. The information contained herin the sole property of Design Harmonics Architecture, Inc. Unauthorized reproduction and o use may be prosecuteded under

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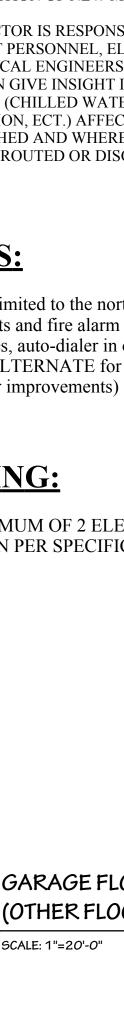
FORT BROOKE PARKING GARAGELEVATOR IMPROVEMENTS


AA 26001084 3810 Murrell Road, #309 Rockledge, FL 32955 3030 N Rocky Point Drive, Ste 150 Tampa, FL 33607

Sheet Title:
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FLOOR PLANS

Comm. No. 14-030
Scale: AS NOTED
Date: 03-20-15
Drawn: WR
Checked: WR
Revised:

Sheet No. A - 2.1



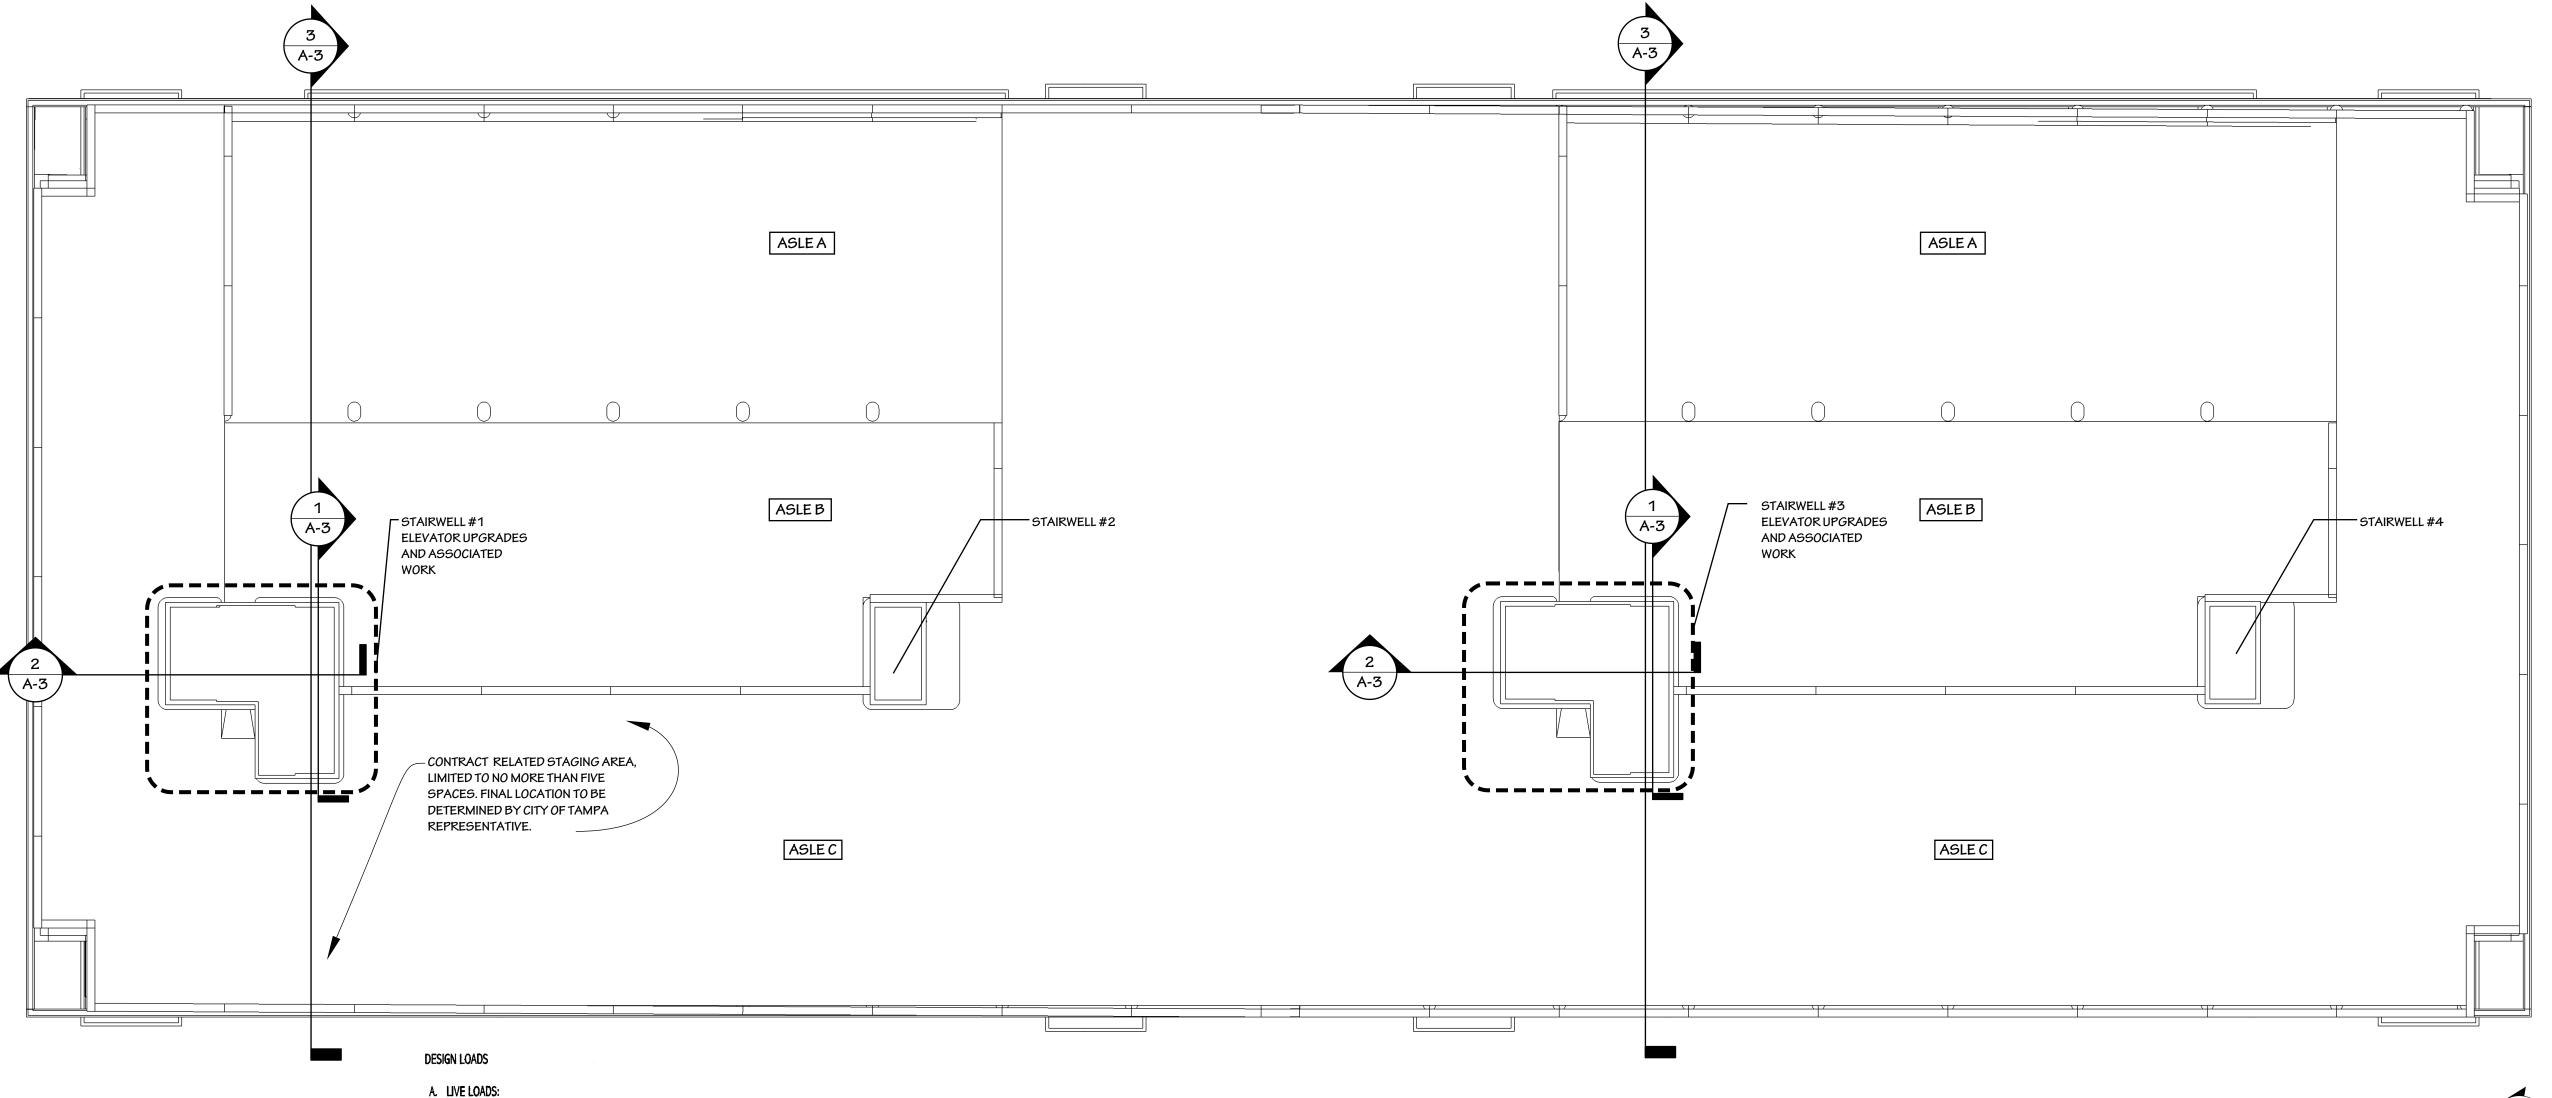

1. UNIFORMLY DISTRIBUTED LIVE LOADS PSF

c) MECHANICAL ROOMS (OR ACTUAL

b) ELEVATOR MACHINE ROOM GRATING, c) PARKING, GUARDRAILS, 18 IN ABOVE FLOOR AT ANY POINT ALONG GUARDRAIL...... 10,000 d) STAIR TREADS (ON CENTER OF TREADS)...... .300

2. CONCENTRATED LIVE LOADS

3. LIVE LOAD REDUCTION:

THE STANDARD BUILDING CODE. a) BASIC WIND SPEED = 100 MPH

B. WIND LOADS:

a) PARKING DECKS (LEVELS 8, 9, & ROOF)......50 b) PARKING DECK (LEVEL 7 ONLY) SEE PLAN

EQUIPMENT LOAD, WHICHEVER IS LARGER)......150

a) PASSENGER CARS ON AN AREA OF 20 SQ IN....2,000

FOR LIVE LOADS OF 100 LBS/SQ FT OR LESS, THE DESIGN

LOADS HAVE BEEN REDUCED AS PER THE STANDARD BUILDING

1. ALL WIND LOADS SHALL BE BASED ON THE REQUIREMENTS OF



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KEEP MINIMUM OF 2 ELEVATORS, PER CORE, IN OPERATION PER SPECIFICATION SECTION 14210.

Sheet Title	g:
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Comm. No.	14-030
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\ENLARGED ELEVATOR SECTION A-3 SCALE: 1/4"=1'-0"

\ELEVATOR CAB/STAIR SECTION SCALE: 1/8"=1'-0"

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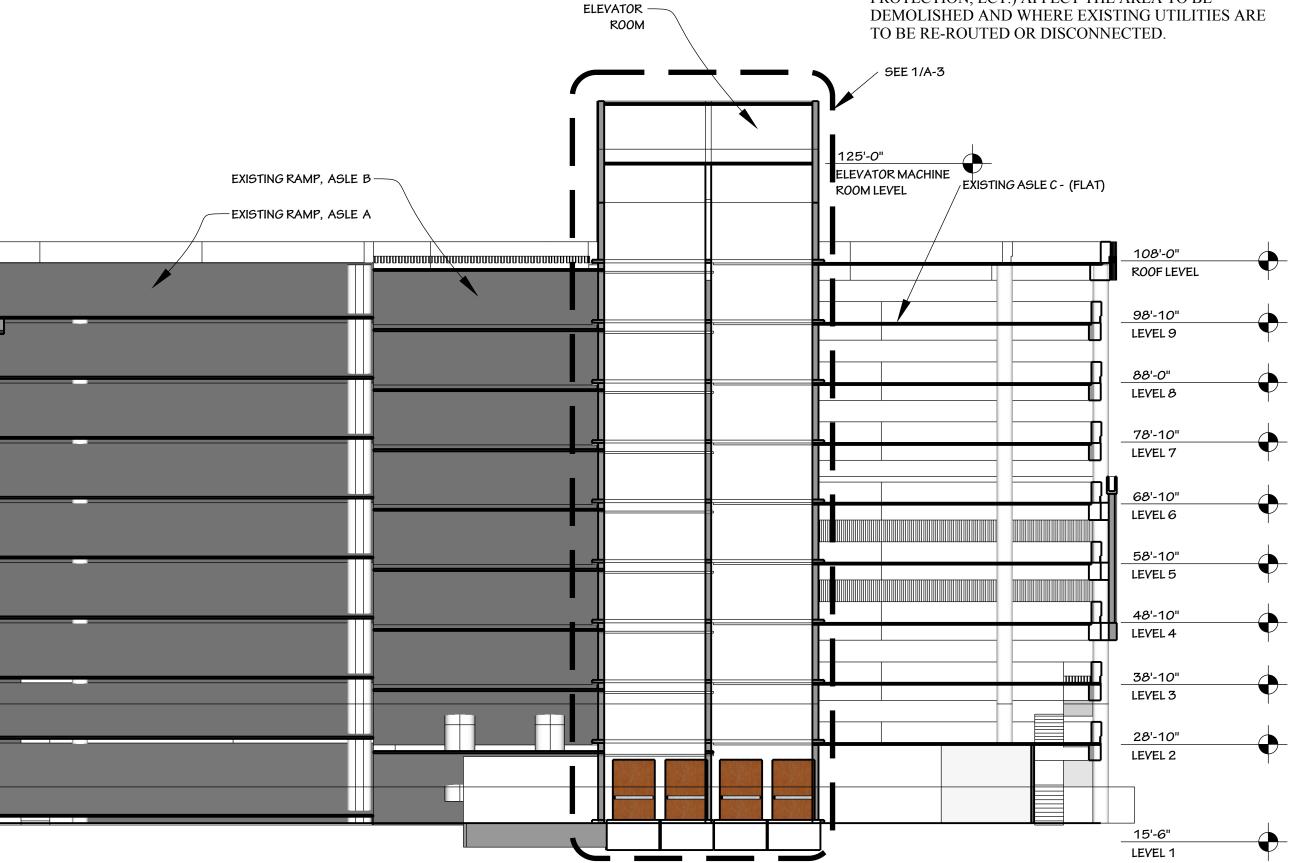
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EXISTING

3 GARAGE SECTION A-3 SCALE: 1/16"=1'-0

KING N N

Sheet Title:

BUILDING SECTIONS Checked: WR

A-3

Sheet No.

JHG

GRINER ENGINEERING, INC 1628 First Avenue North St. Petersburg, Florida 33713 Designed RHM Phone: (727)-822-2335 Fax: (727)-821-3361 Certificate of Authorization #3173

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D10 — NATIONAL
S AND SATISFY . THE SUBMISSION AIMS FOR LABOR, HAVE BEEN FORESEEN
WORK SIMILAR TO IT FIVE PROJECTS WITH CONSTRUCTION ON. E CONTRACT
S PRIOR TO THE BID IN THE CONTRACT
ANY SUBSTITUTION
DE INVOLVED. ISTURBED IN THE QUAL CAPACITY,
AND NON-BUSINESS
WORK WHICH WOULD ED ON THE ELECTRICAL TRADES. LACK OF THIS JBCONTRACTOR.
UIPMENT SHOWN ON QUIRE THE REQUIRE A CREDIT TO HALL BE CONTINUOUSLY
TH PERMANENT R ALL LIGHTING AND
CHEDULE ALL WORK
INUITY OF ELECTRICAL BE INTERRUPTED ONLY AT AND FOR THE GUIDED BY THE
AND INDICATED ON THE
TRUCTURAL ITEM (I.E. JTTING SHALL BE
ONSTRUCTION. E UL LISTED AS
MILLIAMP GROUND
OR CONTACTORS. DO UNSWITCHED HOT TO
YOOD DOOR FRAME.
ID OTHER DEVICES
A MINIMUM OF 24" ON
CH CIRCUIT OS 75 FT. IN LENGTH, RCUIT. FOR RUNS OVER ENGTH OF THE
ALL ELECTRICAL ID STORE ANY S AS REQUIRED THE S, PANEL BOARDS, ETC.

ALL WORK SHALL CONFORM TO THE REQUIREMENTS OF THE FLORIDA BUILDING CODE 20 ELECTRIC CODE 2008, NFPA 70 AND ALL LOCAL ORDINANCES LATEST EDITIONS. BIDDERS ARE TO VISIT THE SITE AND FAMILIARIZE THEMSELVES WITH EXISTING CONDITIONS THEMSELVES AS TO THE NATURE AND SCOPE OF WORK AND THE EXTENT OF DEMOLITION. OF A BID WILL BE EVIDENCED THAT SUCH AN EXAMINATION HAS BEEN MADE. LATER CLAIN EQUIPMENT OR MATERIALS REQUIRED, OR FOR DIFFICULTIES ENCOUNTERED WHICH COULD HAD AN EXAMINATION BEEN MADE, WILL NOT BE ALLOWED. ELECTRICAL CONTRACTOR SHALL BE EXPERIENCED IN PERFORMING AND INSTALLATION OF THAT REQUIRED FOR THIS PROJECT. THE CONTRACTOR SHALL SUBMIT A LIST OF AT LEAST SIMILAR PROJECT SCOPE OF WORK THAT THEY HAVE BEEN CONTRACTED AND COMPLETED 4. PRIOR TO SUBMITTING A BID, THE CONTRACTOR SHALL HAVE STUDIED AND COMPARED TH DOCUMENTS WITH EXISTING/PROPOSED CONDITIONS AND NOT LATER THAN TEN (10) DAYS

ELECTRICAL GENERAL NOTES

DOCUMENTS. ELECTRICAL EQUIPMENT SHALL BE AS SPECIFIED. ARCHITECT AND ENGINEER WILL REVIEW FOR COMPATIBILITY.

6. ALL CUTTING, PATCHING AND REPAIR WORK SHALL BE THE RESPONSIBILITY OF THE TRAD

OPENING SHALL REPORT TO THE ENGINEER ANY ERROR, INCONSISTENCY, OR OMISSION

ELECTRICAL SYMBOL LEGEND

MOUNTING

SEE FIXTURE

SCHEDULE

SEE FIXTURE

SCHEDULE

SEE FIXTURE

SCHEDULE SEE FIXTURE

SCHEDULE

SEE FIXTURE

SCHEDULE

SEE FIXTURE

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SECURITY INSTALLER 18" AFF OR AS

NOTED

SEE PANEL

SCHEDULE

AS NOTED

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60" AFF OR

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SEE SPECIFICATIONS

SEE SPECIFICATIONS

SEE SPECIFICATIONS

SEE SPECIFICATIONS

DESCRIPTION

SHADING DENOTES FIXTURE WITH EM BATTERY PACK.

EXIT-SHADING DENOTES FACEPLATE LOCATION. LETTER

INDICATES TYPE. PROVIDE ARROWS AS REQUIRED.

OUTLET BOX OR J-BOX FOR POWER AND DATA

RACEWAY CONCEALED IN WALL OR ABOVE CEILING

HOMERUN TO PANEL. LETTERS INDICATE PANEL,

INDICATES THE NUMBER OF WIRES EXCLUDING

NON-FUSIBLE SAFETY SWITCH-SIZE AS NOTED

FIRE ALARM AUDIBLE/VISUAL SIGNAL 75cd UON. ADA

FIRE ALARM AUDIBLE/VISUAL SIGNAL 75cd UON. ADA

FIRE ALARM COMBINED HEAT AND RIGHTSYSTEM DETECTOR

FIRE ALARM COMBINED SMOKE ANDHEO SYSTEM DETECTOR

FIRE ALARM PANEL ('FACP' DENOTES FIRE ALARM

CONTROL PANEL, 'FAA' DENOTES ANNUNCIATOR)

120 VOLT SINGLE STATION SMOKE DETECTOR

FIRE ALARM TAMPER AND FLOW SWITCH

THE REQUIRED EQUIPMENT GROUND.

MOTOR, NUMERAL INDICATES HORSEPOWER

FUSIBLE SAFETY SWITCH-SIZE AS NOTED

FAN OR AIR HANDLER SHUTDOWN RELAY

FIRE ALARM VISUAL SIGNAL 75cd UON

FIRE ALARM MANUAL PULLSTATION

FIRE ALARM SMOKE DETECTOR

FIRE ALARM HEAT DETECTOR

FIRE ALARM SMOKE DETECTOR

'SB' DENOTES SOUND BASE

 $3\rangle(3)$ REFER TO LIKE NUMBERED NOTES

FIRE ALARM MINIHORN

COMPATIBLE.

l COMPATIBLE.

MOTOR RATED SWITCH WITH OVERLOAD

NUMBERS INDICATE CIRCUIT. NOTE: HASH MARKS

SINGLE POLE SWITCH (20A-120/277)S S3 D 3' DENOTES 3-WAY 'D' DENOTES DIMMER

'NL' DENOTES FIXTURE UNSWITCHED FOR NIGHT LIGHT

G | 1 X 4 FLUORESCENT FIXTURE

LETTER INDICATES TYPE

OCCUPANCY SENSOR

LINEAR INDIRECT FLUORESCENT FIXTURE

2 X 4 FLUORESCENT FIXTURE

FLUORESCENT STRIP FIXTURE

FLUORESCENT WALL BRACKET FIXTURE

PL FLUORESCENT DOWNLIGHT

LOW VOLTAGE LIGHTING SWITCH

DUPLEX RECEPTACLE, 125V, 20A

'IG' DENOTES ISOLATED GROUND

DUPLEX RECEPTACLE, 125V, 20A

DUPLEX RECEPTACLE, 125V, 20A

COMBINATION VOICE/DATA OUTLET

QUAD RECEPTACLE, 125V, 20A

POWER/TELEPHONE POLE

SUPPLY TO FURNITURE SYSTEMS

▼ DATA OUTLET

FAX OUTLET

CARD READER

T.V. OUTLET

SURVEILLANCE CAMERA

PANELBOARD 120/208V

RELAYS AS REQUIRED.

SYMBOL

—(K)—

- 7. PROTECT ELECTRICAL EQUIPMENT AND INSTALLATIONS AS NECESSARY. IF DAMAGED OR DI COURSE OF THE WORK, REMOVE DAMAGED PORTIONS AND INSTALL NEW PRODUCTS OF EC QUALITY, AND FUNCTIONALITY.
- 8. THE CONTRACTOR SHALL INCLUDE WITHIN THE BID ALL REQUIRED OFF HOUR, OVERTIME, HOUR WORK AS REQUIRED.
- 9. ALL WORK SHALL BE COORDINATE WITH OTHER TRADES FOR ITEMS IN THEIR SCOPE OF \ REQUIRE ELECTRICAL WORK (DISCONNECTION/RECONNECTION ETC.) AND ARE NOT INDICATE PLANS. ALL SUBCONTRACTORS ARE REQUIRED TO COORDINATE THEIR WORK WITH OTHER COORDINATION RESULTING IN ADDED COST TO THE CONTRACT WILL BE BORNE BY THE SU
- 10. THE CONTRACTOR SHALL PROVIDE SHOP DRAWINGS AND SUBMITTALS FOR ELECTRICAL EQU THE PLANS AND SPECIFICATIONS FOR THE ENGINEERS APPROVAL. THE ENGINEER MAY REC CONTRACTOR TO REDO ANY WORK, WHICH WAS NOT APPROVED, OR THE ENGINEER MAY F THE OWNER. PROVIDE A SET OF AS BUILTS AFTER THE JOB IS COMPLETED. THIS SET SH UPDATED DURING CONSTRUCTION.
- 11. PROVIDE IDENTIFICATION FOR ALL LIGHT FIXTURES AND ALL ELECTRICAL COVER PLATES WI MARKER ON A SELF-ADHERING TAG INDICATING PANEL AND CIRCUIT NUMBER. TYPICAL FOR POWER DEVICES.
- 12. ALL WORK SHALL BE PERFORMED DURING TIME PERIODS ACCEPTABLE TO THE OWNER. SC WITH THE OWNER'S REPRESENTATIVE BEFORE PROCEEDING.
- 13. THE CONTRACTOR SHALL PERFORM ALL TEMPORARY WORK NECESSARY TO MAINTAIN CONT SERVICE (LIKE SAWPOLE SERVICE) WHEN CONNECTION IS MADE. THIS SERVICE SHALL NOT WITHOUT PRIOR CONSENT OF THE OWNER'S REPRESENTATIVE AND MAY BE INTERRUPTED (SPECIFIED TIME DESIGNATED BY OWNER'S REPRESENTATIVE. THE CONTRACTOR SHALL BE GU OWNER'S REPRESENTATIVE AT ALL TIMES IN MATTERS AFFECTING THE FACILITIES.
- 14. THE CONTRACTOR SHALL COORDINATE ALL PHASING OF ELECTRICAL WORK AS REQUIRED A ELECTRICAL DRAWINGS.
- 15. THE OWNER PROJECT REPRESENTATIVE SHALL BE NOTIFIED PRIOR TO CUTTING OF ANY ST CONCRETE FLOOR, MASONRY, WALL, ETC.) WITHIN THE EXISTING BUILDING. METHOD OF CU APPROVED BY THE OWNER PROJECT REPRESENTATIVE.
- 16. CONTRACTOR SHALL BE RESPONSIBLE FOR KEEPING THE BUILDING WATERTIGHT DURING CO
- 17. ALL WIRING IN CEILING SPACE OR IN AIR HANDLING PLENUMS NOT IN CONDUIT SHALL BE SUITABLE FOR PLENUM USE.
- 18. ALL JUNCTION BOXES AND COVER PLATES SHALL BE PAINTED AND LABELED.
- 19. ALL RECEPTACLES WITHIN (6) FEET OF PLUMBING FIXTURES SHALL BE PROVIDED WITH 5 FAULT INTERRUPTERS.
- 20. EXIT SIGNS AND ALL EMERGENCY LIGHTING SHALL BE WIRED AHEAD OF ANY SWITCHING OF NOT SWITCH EXIT SIGNS OR EMERGENCY NIGHT LIGHTS. CONTRACTOR SHALL PROVIDE AN BYPASS ANY SWITCHING AND/OR CONTRACTORS FOR ALL SWITCHED EMERGENCY LIGHTING.
- 21. EDGE OF LIGHT SWITCH WALL PLATE SHALL BE NOT MORE THAN 4" AWAY FROM METAL/W TYPICAL FOR SINGLE OR MULTIPLE WALL SWITCHES.
- 22. CONFIRM MOUNTING HEIGHTS AND COORDINATE LOCATION OF ALL OUTLETS, SWITCHES, AND WITH ARCHITECTURAL ELEVATIONS (FURNITURE LAYOUT) PRIOR TO ROUGH-IN.
- 23. PROVIDE SEAL FOR PENETRATION OF FIRE RATED WALLS BY CONDUIT.
- 24. BACK TO BACK RECEPTACLES IN ALL ONE HOUR FIRE RATED WALLS SHALL BE LOCATED CENTER.
- 25. BRANCH CIRCUIT CONDUCTORS SHALL NOT BE SMALLER THAN NO. 12 AND WHERE BRANC CONDUCTOR RUNS FROM SOURCE (PANEL) TO THE LAST DEVICE ON THE CIRCUIT EXCEED THE CONDUCTORS SHALL BE NO. 10 MINIMUM AND FOR THE ENTIRE LENGTH OF THE CIR 150 FT. IN LENGTH THE CONDUCTOR SHALL BE NO. 8 MINIMUM AND FOR THE ENTIRE LE CIRCUIT. THE ABOVE APPLIES TO 120 VOLT CIRCUITS ONLY.
- 26. THE CONTRACTOR SHALL COORDINATE WITH THE OWNER THE REMOVAL AND DISPOSAL OF MATERIAL WHICH IS NOT TO BE USED ON THE PROJECT. CONTRACTOR SHALL REMOVE ANI ELECTRICAL MATERIAL IF SO DIRECTED BY OWNER. PATCH AND PAINT WALLS AND CEILINGS CONTRACTOR SHALL COORDINATE INSTALLATION OF NEW LIGHTING FIXTURES, RECEPTACLES, WITH EXISTING STRUCTURE, PIPING, ETC. AND MAKE ADJUSTMENTS AS REQUIRED.
- 27. REFER TO ELECTRICAL SPECIFICATIONS SHEET FOR REQUIREMENTS.
- 28. UPON COMPLETION OF THE WORK, THE CONTRACTOR SHALL INSURE THAT ALL SYSTEMS OPERATE AS DESIGNED AND REQUIRED AND SHALL REVIEW THEIR OPERATION WITH THE OWNER AND PROVIDE TRAINING OF THE MAINTENANCE PERSONNEL. COMPLETE SET OF AS-BUILT DRAWINGS SHALL BE COMPILED (BY THE CONTRACTOR) AND ISSUED (1 EACH) TO THE ARCHITECT AND BUILDING MAINTENANCE PERSONNEL UPON COMPLETION OF CONSTRUCTION AND TESTING.

ABBREVIATIONS:

		<u> </u>	
AFF AHU BFG C CW DACF DN EF EG ENCL EWC EWH	- - - - -	EXHAUST FAN EQUIPMENT GROUND ENCLOSURE ELECTRIC WATER COOLER ELECTRIC WATER HEATER	HVAC - HEATING, VENTILATING, AIR CONDITIONI JB - JUNCTION BOX LRA - LOCKED ROTOR AMPERES MCB - MAIN CIRCUIT BREAKER MLO - MAIN LUGS ONLY N - NEUTRAL NL - NIGHT LIGHT OB - OUTLET BOX PB - PULL BOX, PUSH-BUTTON PS - PAY STATION SF - SUPPLY FAN SPEC - SPECIFICATIONS TI - TWISTLOCK
ΨX	_	EXPLOSION PROOF	TL – TWISTLOCK
FCU	_	FAN COIL UNIT	TTB — TELEPHONE TERMINAL BOARD
FHP	_	FRACTIONAL HORSEPOWER	TVTB — TELEVISION TERMINAL BOARD

FLA - FULL LOAD AMPERES UNO - UNLESS NOTED OTHERWISE UP – FEED UPWARD G – GROUND GFI — GROUND FAULT INTERRUPTER VERT – VERTICAL HID - HIGH INTENSITY DISCHARGE WM – WATT MISER WP – WEATHERPROOF HORIZ – HORIZONTAL WW - WARM WHITE

IG – ISOLATED GROUND LW - LIGHT WHITE HORSEPOWER, HEAT PUMP

NATIONAL ELECTRIC CODE NOTES:

XFMR – TRANSFORMER

ALL WORK SHALL CONFORM TO THE REQUIREMENTS OF NFPA 70 -2008 NATIONAL ELECTRIC CODE

FIRE ALARM GENERAL NOTES:

ALL FIRE ALARM WORK SHALL BE DONE BY A LICENSED ELECTRICAL/ FIRE ALARM CONTRACTOR.

ELECTRICAL SUBMITTAL NOTES:

SUBMIT ALL ELECTRICAL SYSTEMS SUBMITTALS AT ONE (1) TIME IN ONE (1) INTEGRAL GROUP. PIECE-BY-PIECE SUBMISSION OF INDIVIDUAL ITEMS WILL NOT BE ACCEPTABLE. ENGINEER MAY CHECK CONTENTS OF EACH SUBMITTAL SET UPON INITIAL DELIVERY; IF NOT COMPLETE AS SET FORTH HEREIN, SUBMITTAL SETS MAY BE RETURNED TO CONTRACTOR WITHOUT REVIEW AND APPROVAL AND WILL NOT BE ACCEPTED UNTIL MADE COMPLETE. SHOP DRAWINGS WILL BE REVIEWED MAXIMUM TWICE AS PART OF THIS CONTRACT.


- ALL MOUNTING HEIGHTS SHOWN ARE TO THE TOP OF THE DEVICE UNLESS NOTED OTHERWISE
- NOT ALL SYMBOLS APPEAR ON PLANS.


		ELECTRICAL DRAWING INDEX:
#	SHEET	DESCRIPTION
1	E1	ELECTRICAL COVER SHEET
2	E2	ELECTRICAL ELEVATION
3	E3	ELECTRICAL ROOF PLAN
4	E4	ELECTRICAL PENTHOUSE PLAN
5	E5	GROUND FLOOR ELECTRICAL PLAN
6	E6	ELECTRICAL POWER RISER
7	E7	ELECTRICAL PANELS
8	E8	FA PLAN GROUND FLOOR
9	E9	FA PLAN FLOOR 2-10
10	E10	FA DETAILS
11	E11	FA DETAILS

GENERAL NOTE:

CITY OF TAMPA FACILITY MANAGEMENT STORAGE IS LOCATED AT: 1550 NORTH GRADY AVE. TAMPA, FLORIDA CONTRACTOR IS RESPONSIBLE FOR LOADING AND TRANSPORTING THE SPECIFIED/OWNER PURSHASED EQUIPMENT TO THE JOB SITE AND INSTALLING EQUIPMENT PER CONSTRUCTION DRAWINGS.



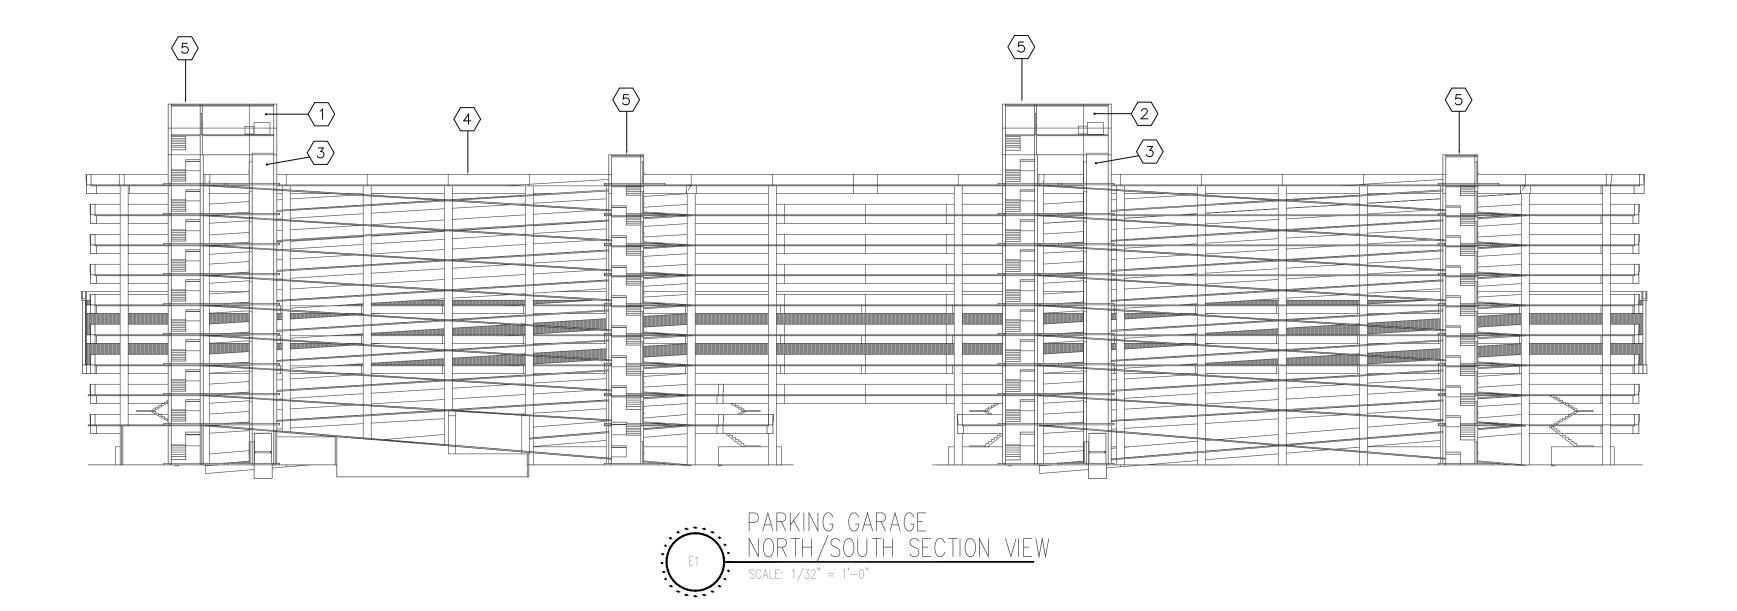

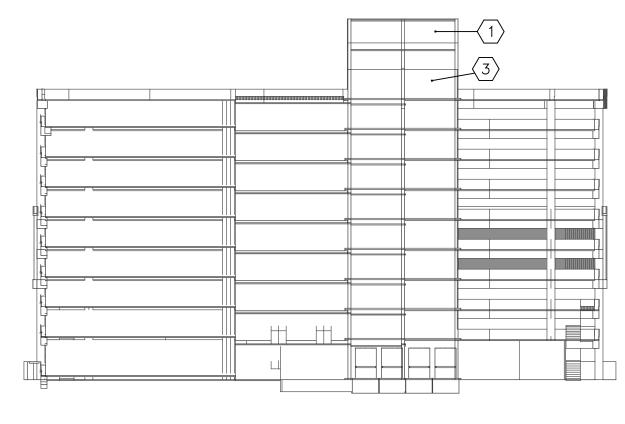

PARKING GARAGE

EAST/WEST END SECTION/VIEW

SCALE: 1/32" = 1'-0"

ELECTRICAL RENOVATION NOTES:

- 1. EXISTING NORTH ELEVATOR PENTHOUSE FOR ELEVATORS NO. 5 THRU 8. ACCESS FROM ROOF ELEVATION,
- 2. EXISTING SOUTH ELEVATOR PENTHOUSE FOR ELEVATORS NO. 1 THRU 4. ACCESS FROM ROOF ELEVATION.
- 3. EXISTING ELEVATOR HOISTWAY AND ELEVATOR CAR PLATFORM AND WALL FRAMING TO BE REUSED. ELEVATOR CAR INTERIOR FEATURES TO BE REPLACED/UPGRADED AS DEFINED IN THE CONTRACT DOCUMENTS (TYPICAL).
- 4. EXISTING PARKING GARAGE ROOF LEVEL.
- 5. EXISTING STAIR TOWER (TYPICAL).

FORT BROOKE P.
ELEVATOR IMPRC
107 N Franklin St
Tampa, FL 33602

Design
Harmonics
Architecture
A 26001084
3810 Murrell Road, #309
Rockledge, FL 32955
Tampa, FL 33607
Tel: (813)-350-7997 Fax: (designharmonicsarchitecture.ne

Sheet Title:

ELECTRICAL

ELEVATION

Comm. No. 14-030

Scale: AS NOTED

Date: 10-31-14


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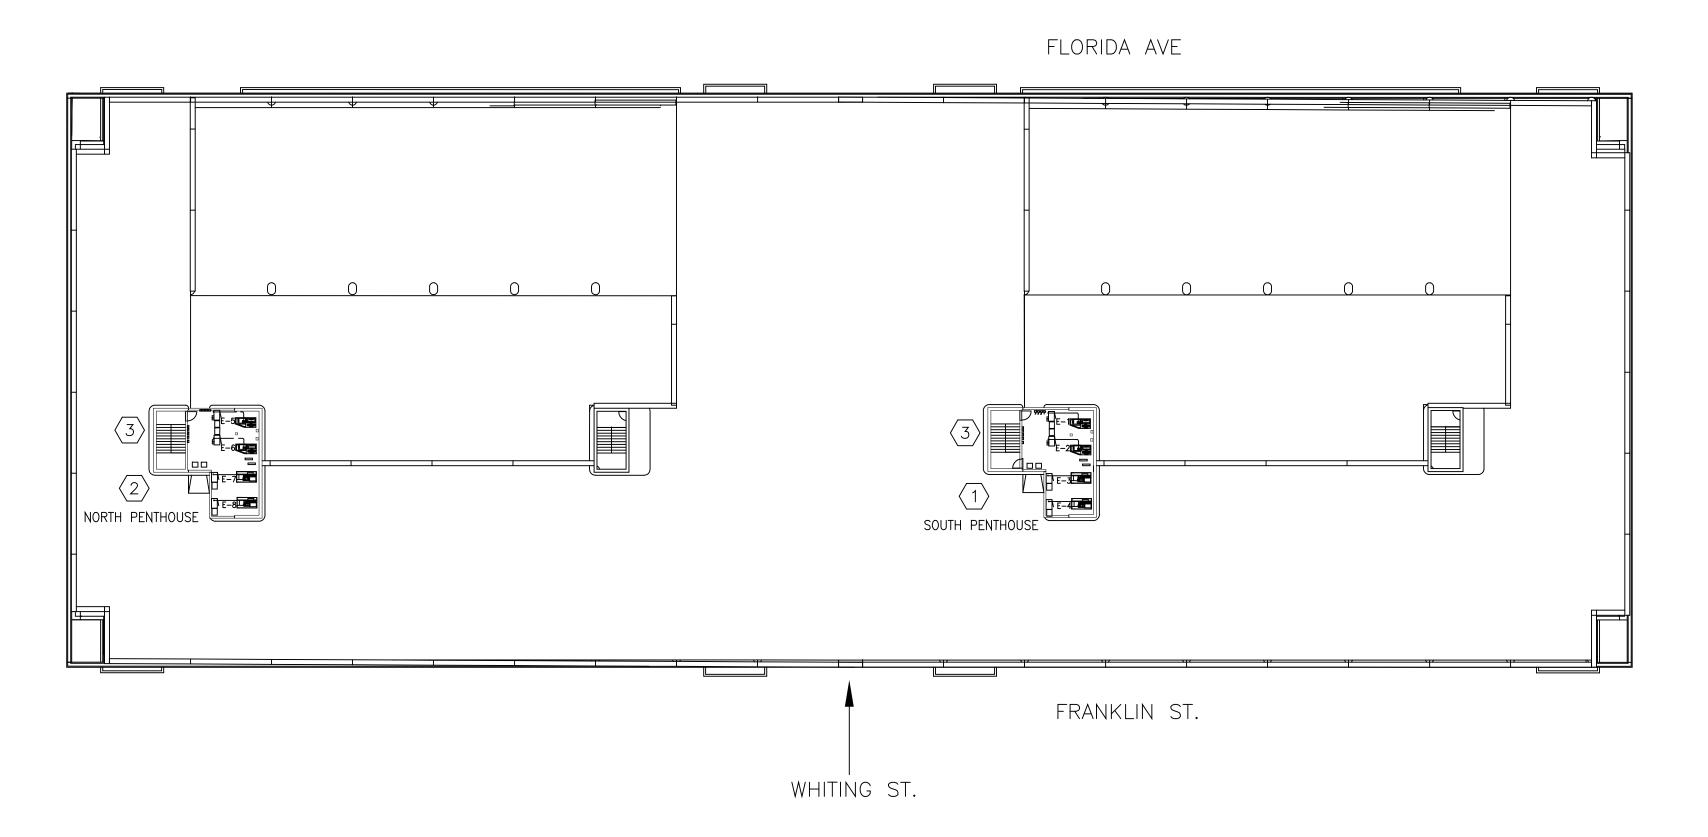
Revised:

Sheet No.





- 1. EXISTING SOUTH ELEVATOR PENTHOUSE FOR ELEVATORS NO. 1 THRU 4. ACCESS FROM ROOF ELEVATION. **WORK TO THESE UNITS BY ALTERNATE CONTRACT**.
- 2. EXISTING NORTH ELEVATOR PENTHOUSE FOR ELEVATORS NO. 5 THRU 8. ACCESS FROM ROOF ELEVATION. WORK TO UNITS #5,#6, #7, #8 UNDER THIS CONTRACT. SEE PENTHOUSE AND RISER SHEETS FOR DETAILS.
- 3. EXISTING STAIRWAY (TYPICAL)

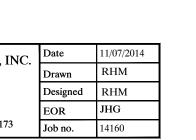

ELECTRICAL ROOF PLAN

WITH ELEVATOR MACHINE ROOMS

SCALE: 1/32" = 1'-0"





ELECTRICAL RENOVATION NOTES:

- 1. EXISTING NORTH ELEVATOR PENTHOUSE FOR ELEVATORS NO. 5 THRU 8. ACCESS FROM ROOF ELEVATION, SOUTH PENTHOUSE IS SIMILAR LAYOUT WITH ELEVATORS 1 THRU 4.

 -NORTH PENTHOUSE ELEVATORS (#5,#6,#7,#8) TO BE INCLUDED IN THIS CONTRACT.

 -SOUTH PENTHOUSE ELEVATORS (#1,#2,#3,#4) TO BE BY ALTERNATE CONTRACT.
- 2. ELEVATOR TRACTION MACHINE TO BE PURCHASED BY CITY AND REPLACED BY CONTRACTOR (TYPICAL). UNITS #5 AND #6 ARE TO BE REPLACED BY CONTRACT DOCUMENTS (UNITS #1 AND #2 BY ALTERNATE CONTRACT). REMAINING UNITS SHALL BE REFURBISHED AND ADJUSTED TO ACCEPTABLE CONDITION.
- 3. EXISTING 480V 60A 3 POLE FUSED DISCONNECT WITH 50A FUSES FOR ELEVATOR POWER TO REMAIN TO BE REUSED (TYPICAL). REPLACE EXISTING FUSES WHEN NEW ELEVATOR EQUIPMENT IS INSTALLED, TRACTION MACHINES #5 AND #6 ARE TO BE REPLACED BT CONTRACT DOCUMENTS. REMAINING UNITS WILL BE REFURBISHED TO ACCEPTABLE CONDITION. TRACTION MACHINES FOR UNITS #1, #2, BY ALTERNATE CONTRACT.
- 4. ELEVATOR CONTROLLERS FOR UNITS #5,#6,#7,#8 TO BE PURCHASED BY CITY AND REPLACED BY CONTRACTOR (TYPICAL). CONTROLLERS FOR UNITS #1, #2, #3, #4 BY ALTERNATE CONTRACT.
- 5. EXISTING FUSED DISCONNECTS FOR ELEVATOR CAR LIGHTS (TYPICAL),
- 6. EXISTING DX HVAC UNITS (TYPICAL)
- 7. EXISTING 31KVA 3 PHASE 480V DELTA TO 480V WYE ISOLATION TRANSFORMER FOR EACH CONTROLLER. TRANSFORMER TO REMAIN TO BE REUSED AS NEEDED WITH REPLACEMENT CONTROLLER.
- 8. REMOVE FIRE ALARM 120V HEAT DETECTOR AS SHOWN (TYPICAL), FURNISH AND INSTALL NEW ADDRESSABLE HEAT DETECTOR AND RUN TO NEW FIRE ALARM PANEL IN GROUND FLOOR VIA APPROVED METHODS AND MATERIALS AND CONNECT. SEE FIRE ALARM PANEL SHEET FOR USE OF EXPANDER PANELS FOR DISTANCE.

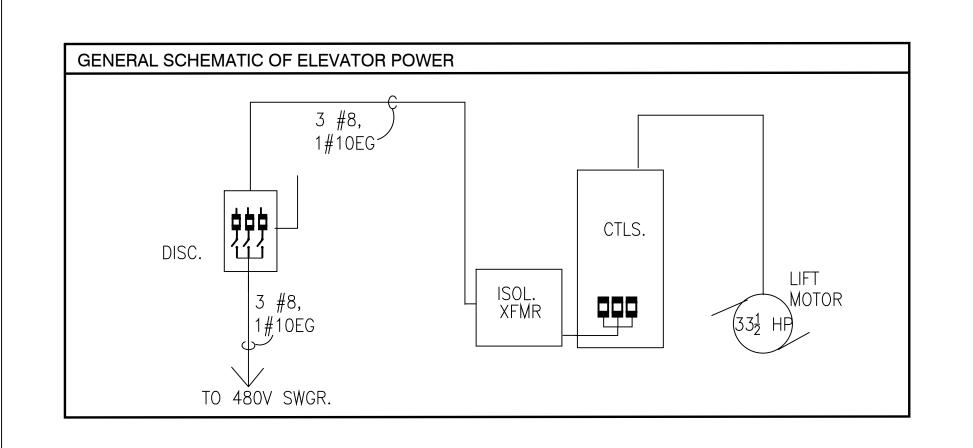

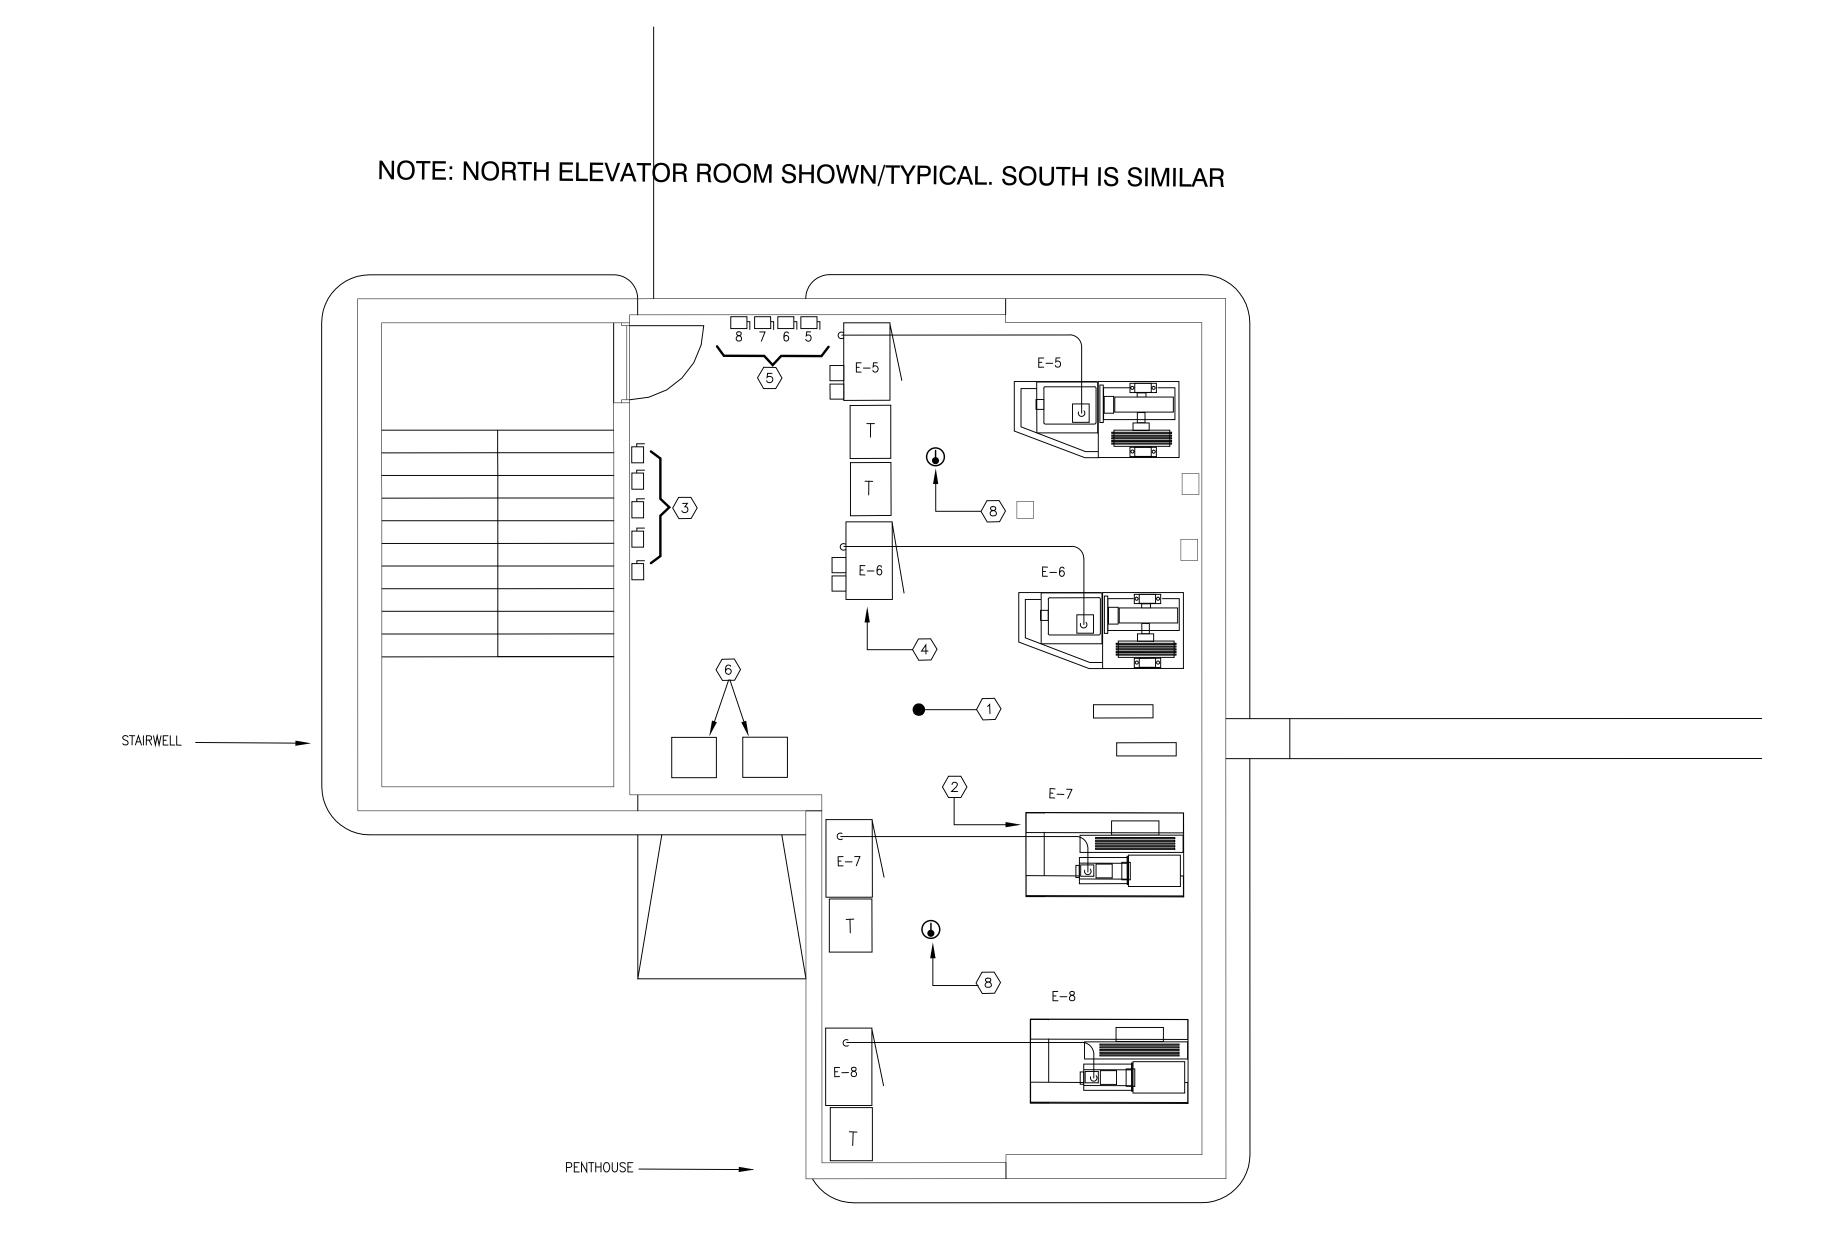



ROOF LEVEL DRIVE AND PARKING

ROOF LEVEL





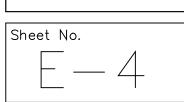

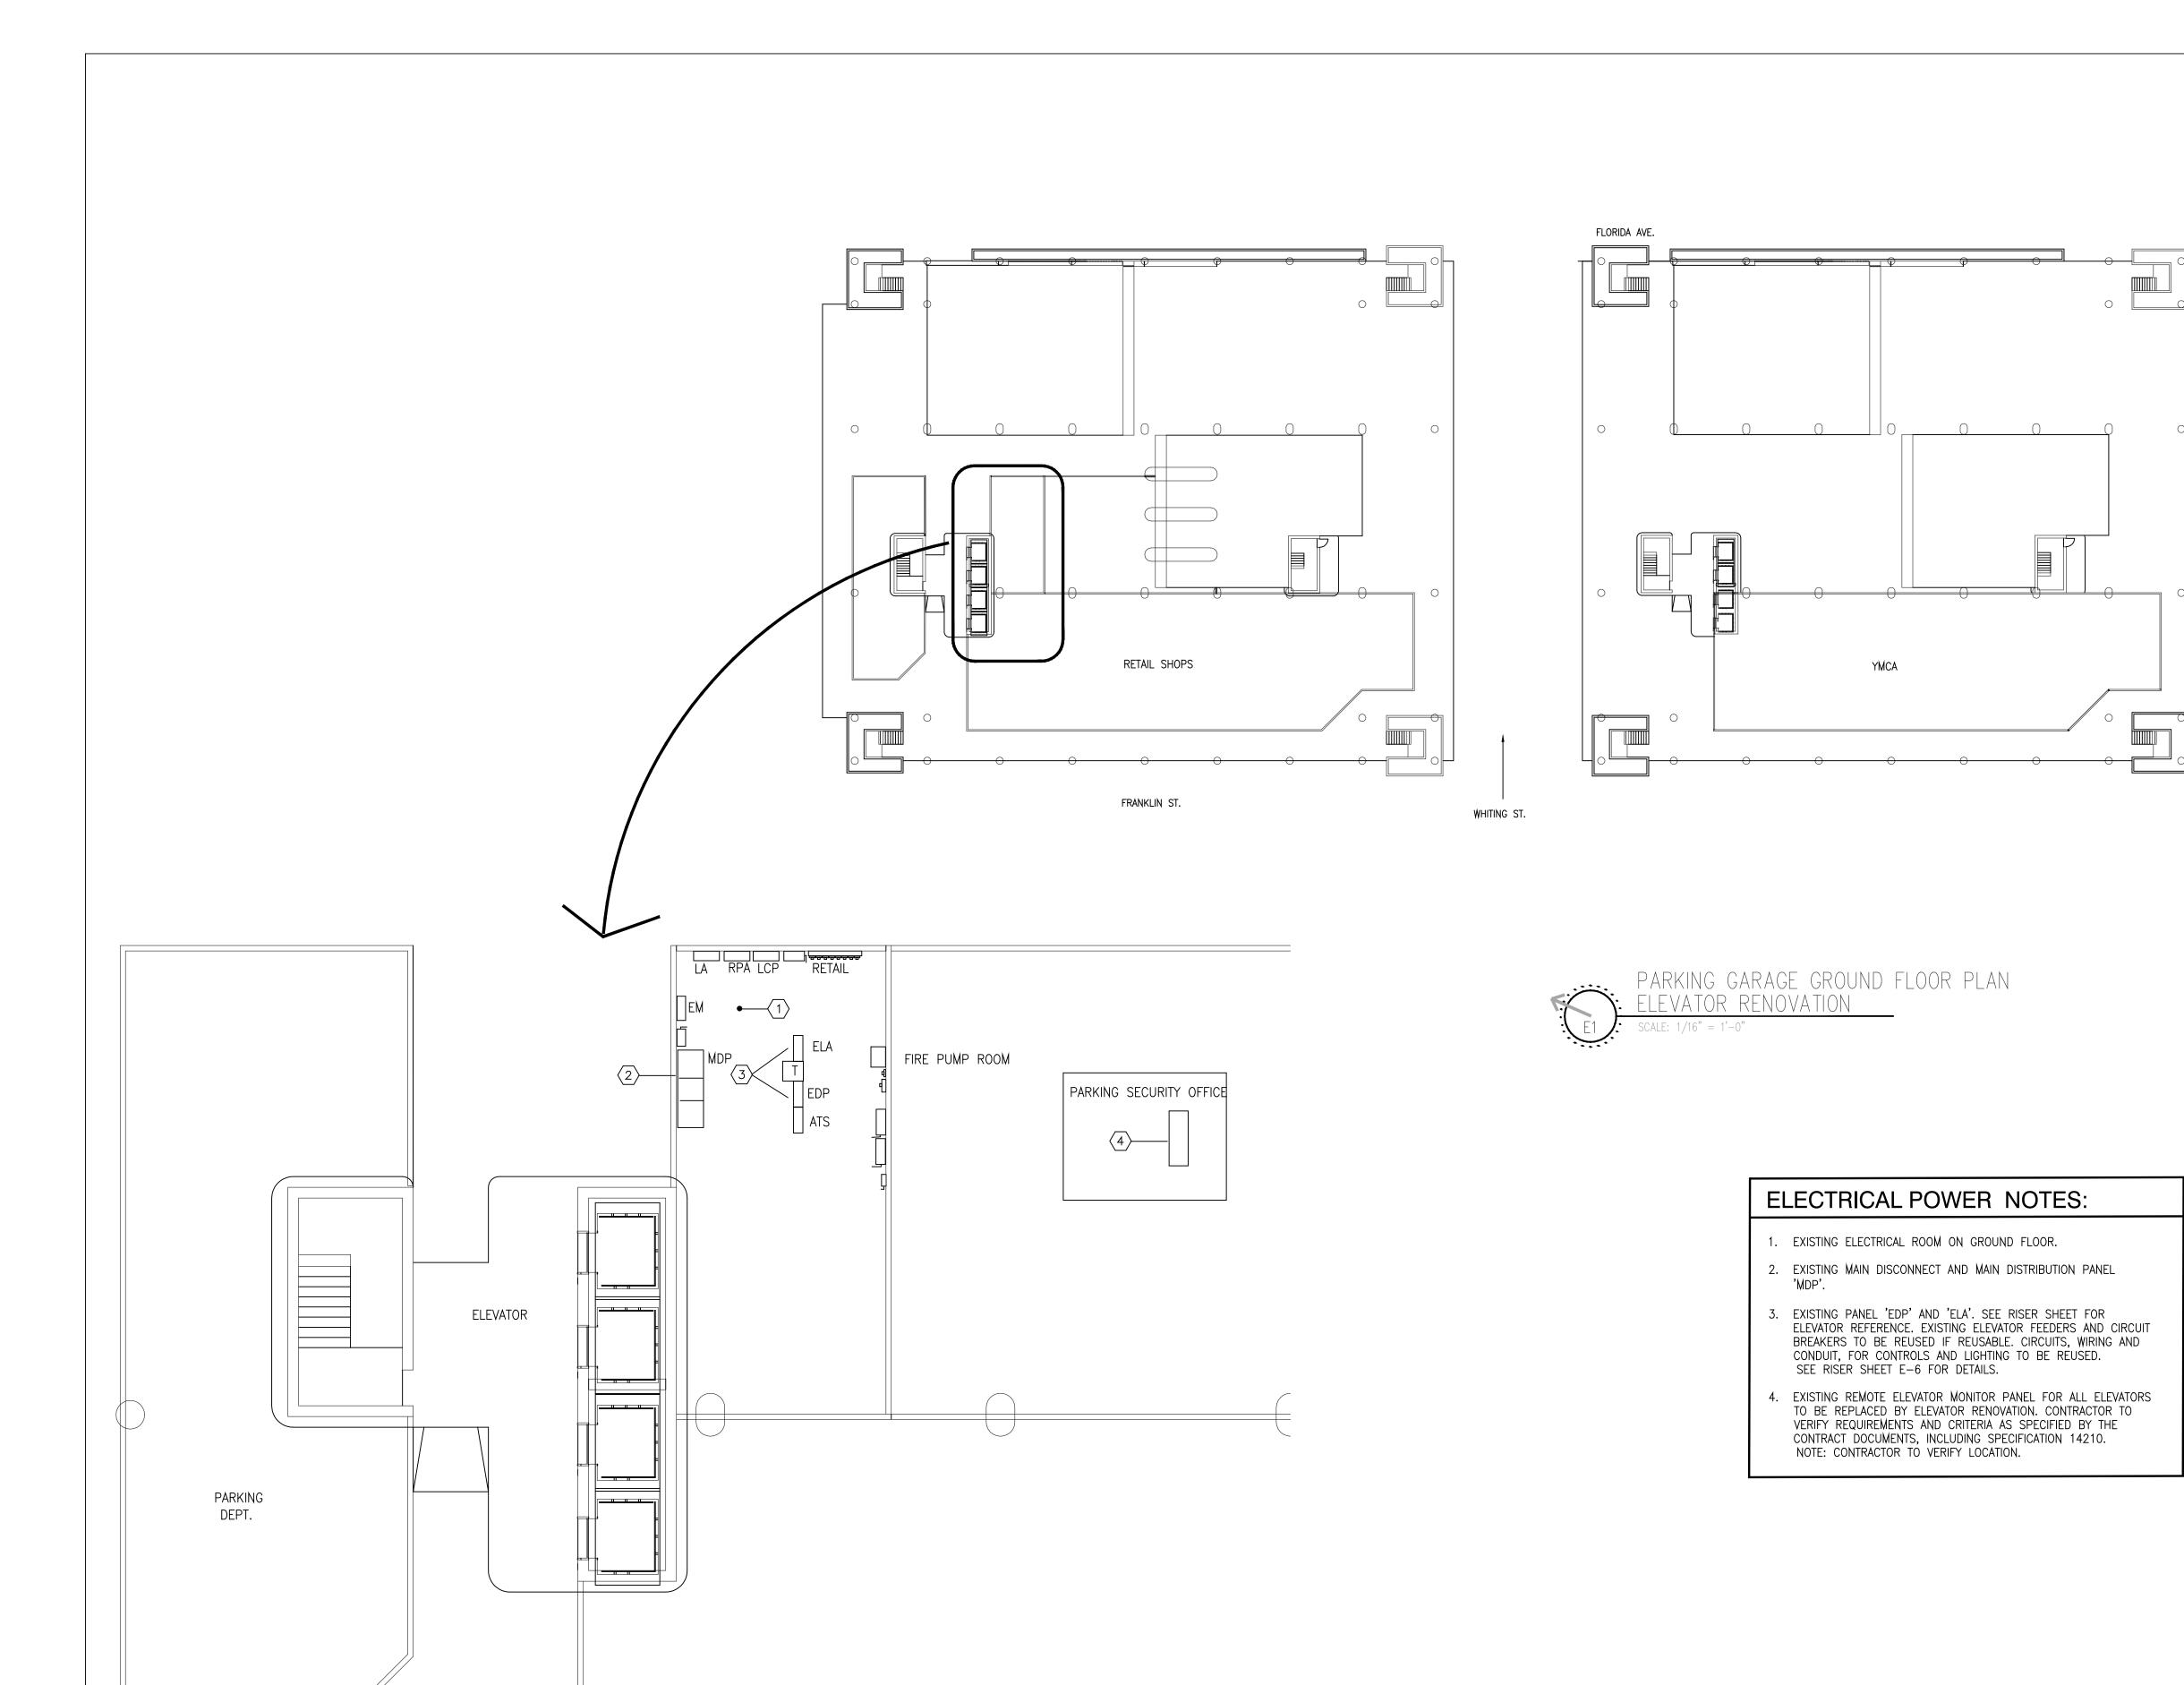

PARKING GARAGE GROUND FLOOR PARTIAL PLAN




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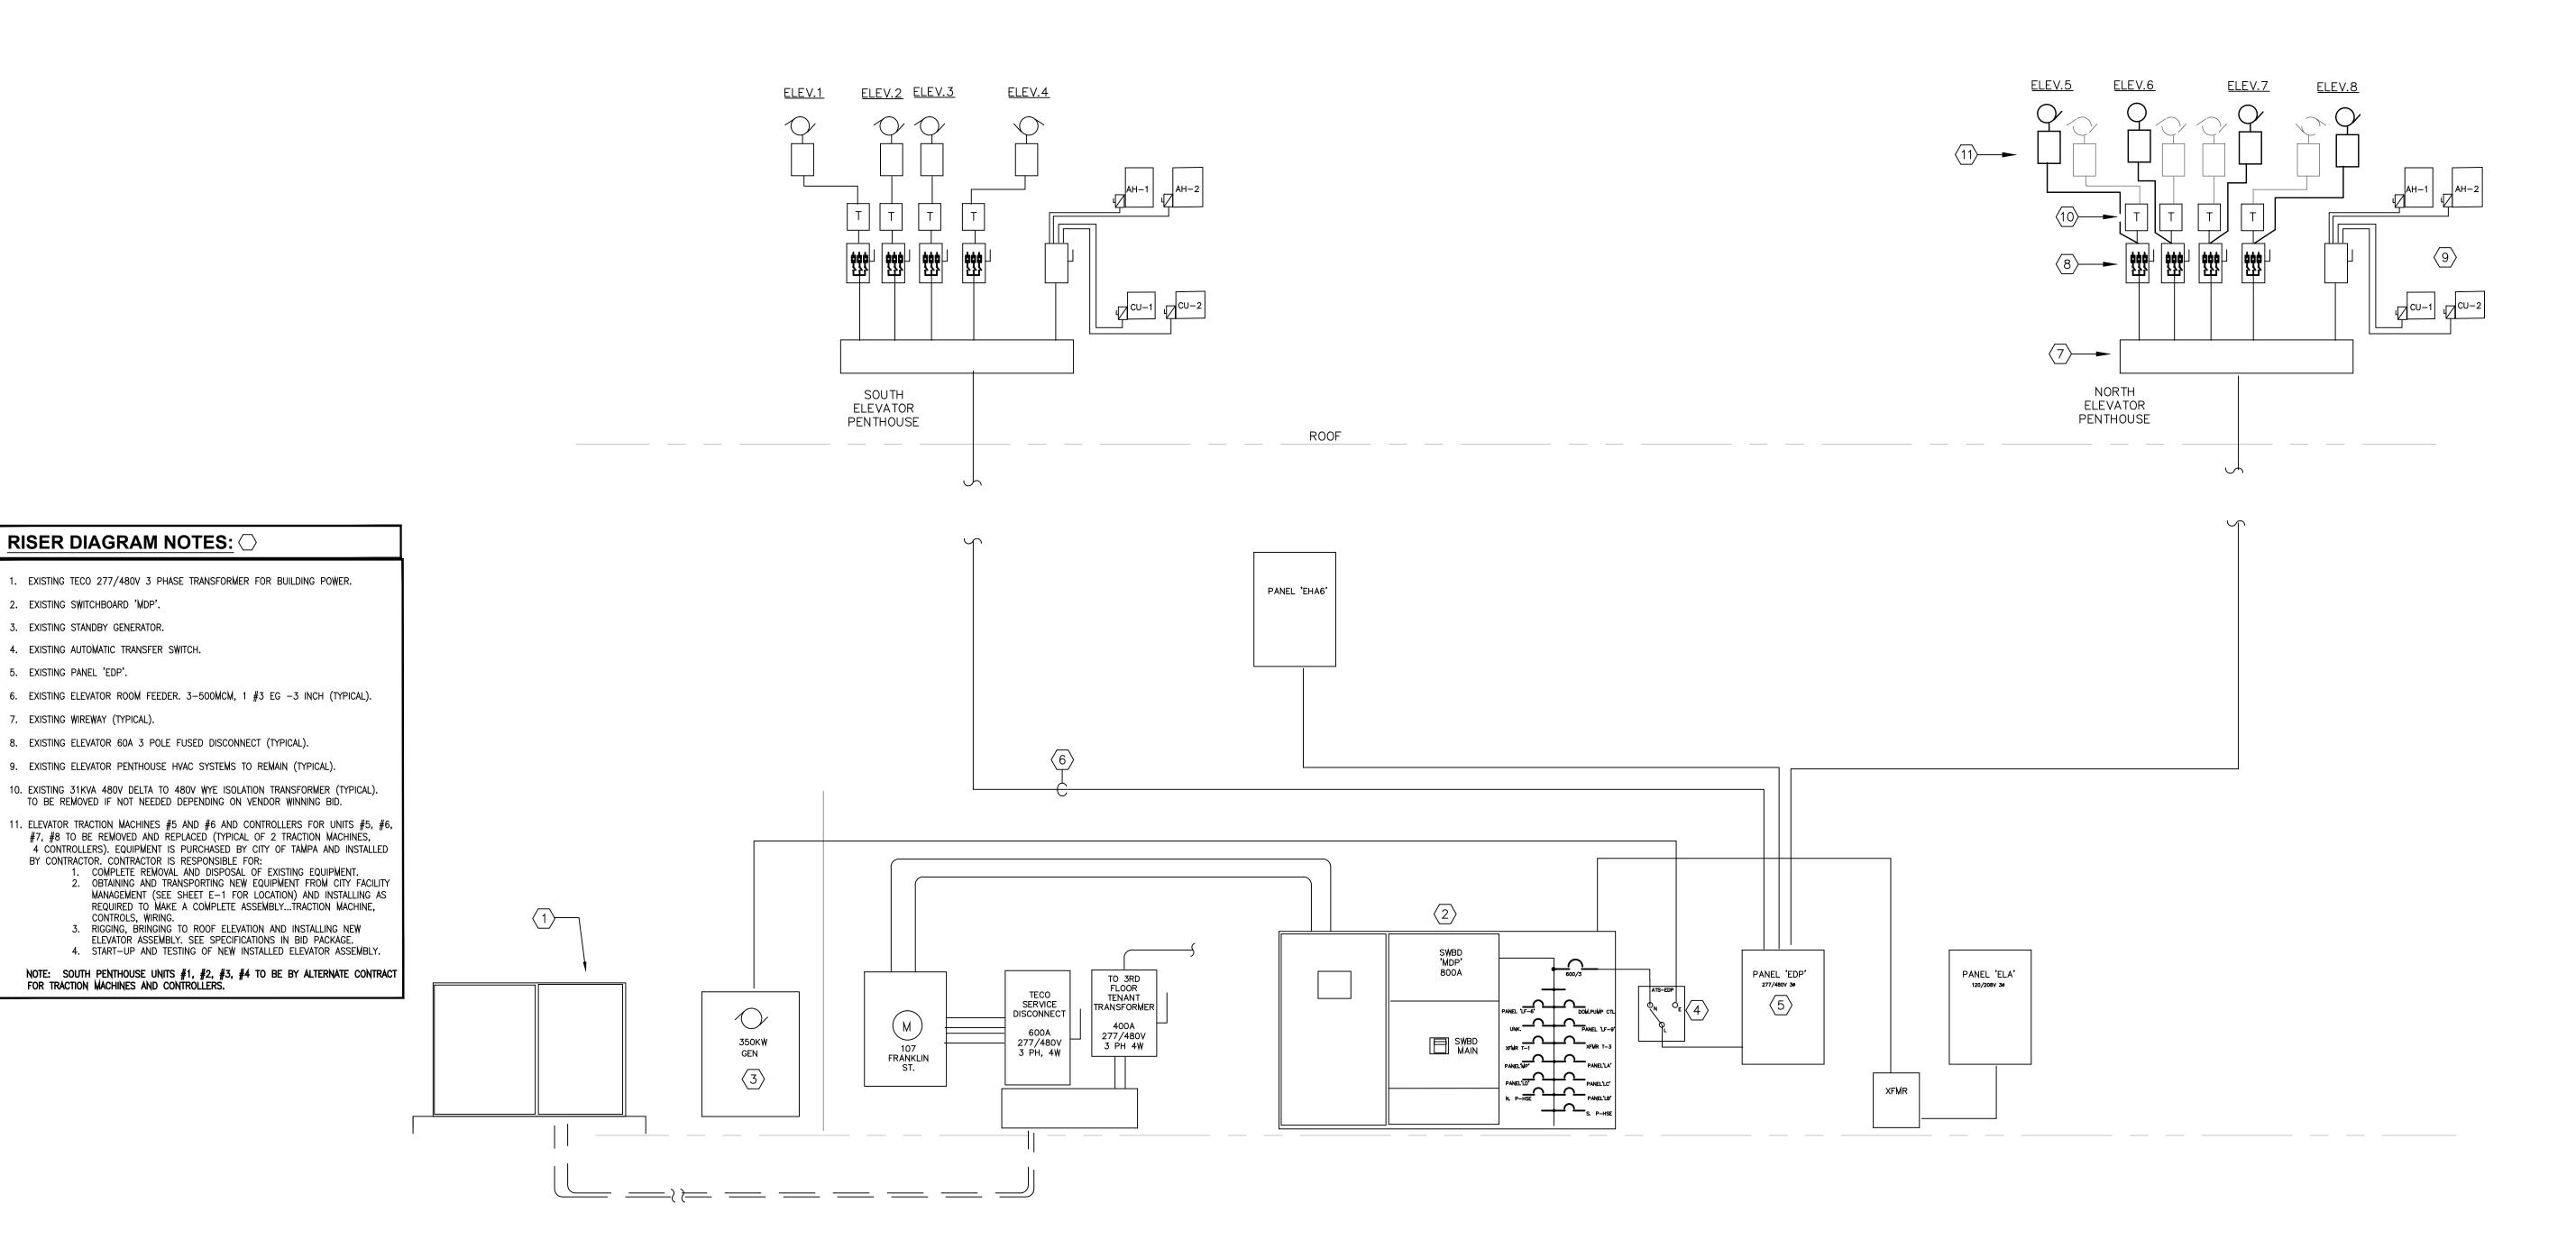
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Sheet No.

	GRINER ENGINEERING, INC.	Date	11/07/2014
	1628 First Avenue North	Drawn	RHM
\setminus	St. Petersburg, Florida 33713 Phone: (727)-822-2335	Designed	RHM
	Fax: (727)-821-3361	EOR	JHG
	Certificate of Authorization #3173	Job no.	14160





PARKING GARAGE PARTIAL

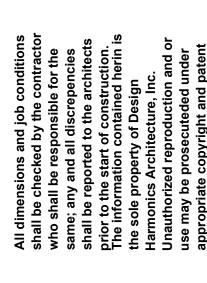SCALE: NONE

RISER DIAGRAM NOTES: \bigcirc

8. EXISTING ELEVATOR 60A 3 POLE FUSED DISCONNECT (TYPICAL).

BY CONTRACTOR. CONTRACTOR IS RESPONSIBLE FOR:

CONTROLS, WIRING.

2. EXISTING SWITCHBOARD 'MDP'. 3. EXISTING STANDBY GENERATOR.

EXISTING PANEL 'EDP'.

7. EXISTING WIREWAY (TYPICAL).

4. EXISTING AUTOMATIC TRANSFER SWITCH.

GRINER ENGINEERING, IN 1628 First Avenue North St. Petersburg, Florida 33713 Phone: (727)-822-2335 Fax: (727)-821-3361 Certificate of Authorization #3173

NC.	Date	11/07/2014
10.	Drawn	RHM
	Designed	RHM
	EOR	JHG
	Job no.	14160

Sheet No.

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RISER

Scale:

Checked:

Revised:

Date: Drawn:

DIAGRAM

Comm. No. 14-030

AS NOTED 10-31-14

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WR

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F O R 107 N Fr Tampa, F

Design
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Rockledge, FL 32955
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Tampa, FL 33607
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Sheet Title: ELECTRICAL RISER DIAGRAM

Comm. No. 14-030 Scale: AS NOTE AS NOTED Date: Drawn: 10-31-14 Checked:

Sheet No.

Date 11/07/2014

Drawn RHM

Designed RHM

EOR JHG

Job no. 14160 GRINER ENGINEERING, INC.
1628 First Avenue North
St. Petersburg, Florida 33713
Phone: (727)-822-2335
Fax: (727)-821-3361
Certificate of Authorization #3173


E)	KISTING		PANEL_EDP	27	7/480V	3PH, 4	-W					
LO	AD WA		LOAD DESCRIPTION	CIR BK	R 600/	′3 MLO		BKR	I IAKN NESADIDIIAKI I	LC	AD WA	TTS
ф_	вф	Сф	LOAD DESCRIPTION	TRIP NO).			TRIP		Аф	вφ	Сф
			ELEVATORS, HVAC NORTH	5			2 4 6	400	ELEVATORS, HVAC SOUTH			
			TRANSFORMER PANEL ELA	50 7)		8 10 12	150	PANEL EHA6			
			PANEL EM	60 13 15 17	<u>;</u>		14 16 18	20 20 20				
				20 ₁₉ 20 ₂ 20 ₂	1		20 22	20 20 20				
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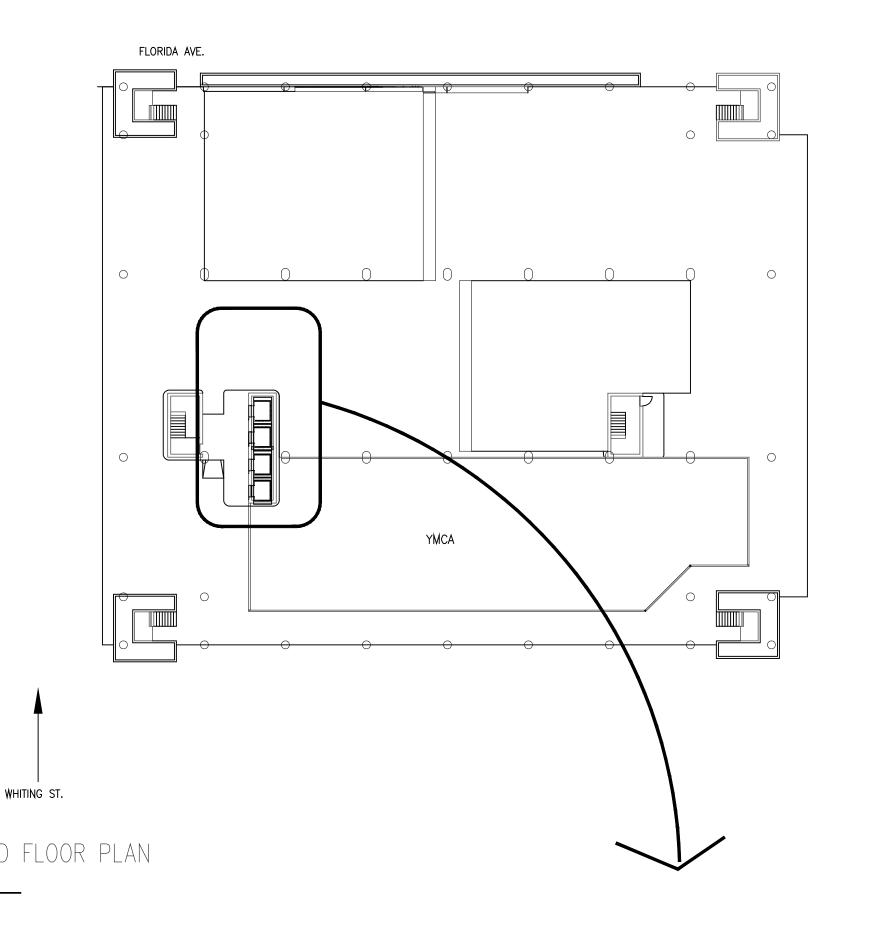
NOTE: PANEL SCHEDULES WERE PREPARED FROM SITE INFORMATION AND AS BUILT DRAWINGS. THE INFORMATION IS CONTRADICTORY AND SHALL BE VERIFIED PRIOR TO PERFORMING ANY WORK TO THE ELEVATOR SYSTEMS. AS SUCH, WHAT IS SHOWN IS HISTORIAL MATERIAL.

FOR GENERAL INFORMATION ONLY

··;	PARKING GARAGE PANEL SCHEDULES	W/	ELEVATOR	LOADS
	SCALE: NONE	· · · · ·		

120/208V 3PH, 4W <u>PANEL</u> ELA LOAD WATTS CIR BKR 100/3 MCB CIR BKR TRIP NO. TRIP LOAD WATTS LOAD DESCRIPTION LOAD DESCRIPTION | LOAD DESCRIPTION | TRIP NO. | NO. TRIP | LOAD DESCRIPTION | PROCEED | TRIP NO. | NO. TRIP | LOAD DESCRIPTION | PROCEED | PROCEED | NO. TRIP | LOAD DESCRIPTION | PROCEED | PROCEED | NO. TRIP | LOAD DESCRIPTION | PROCEED | PROCEED | PROCEED | NO. TRIP | LOAD DESCRIPTION | PROCEED | PRO АФ ВФ СО АФ ВФ СФ TOTAL CONNECTED: ESTIMATED DEMAND:




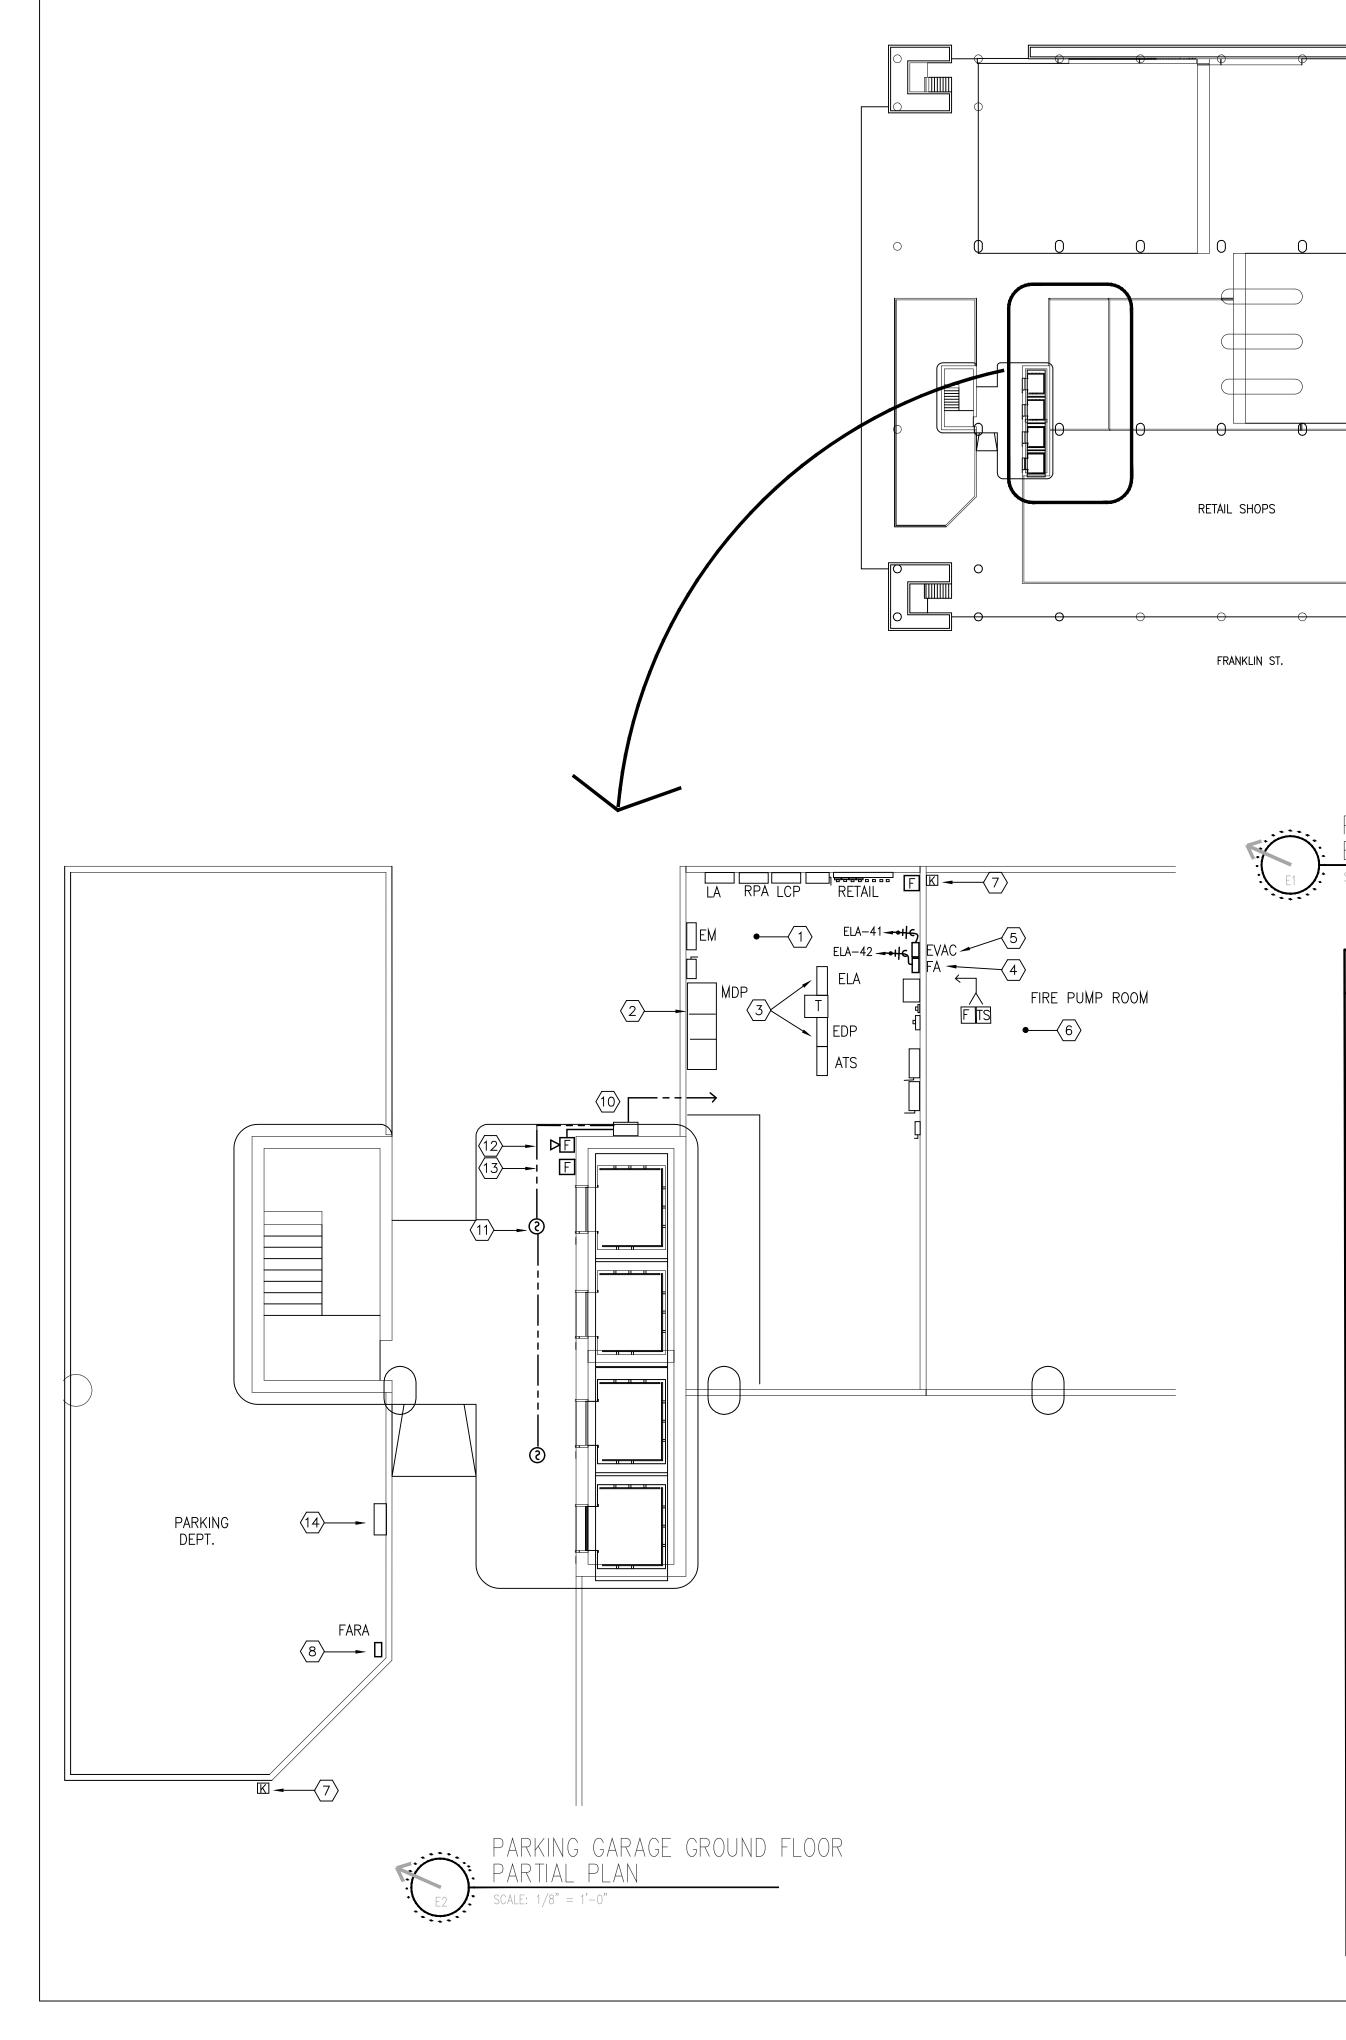

ELECTRICAL PARTIAL PLAN NOTES:

- 1. EXISTING ELECTRICAL ROOM ON GROUND FLOOR.
- 2. EXISTING MAIN DISCONNECT AND MAIN DISTRIBUTION PANEL
- 3. EXISTING PANEL 'EDP' AND 'ELA'. SEE RISER SHEET E-7 FOR ELEVATOR REFERENCE. EXISTING ELEVATOR FEEDERS AND CIRCUIT BREAKERS TO BE REUSED IS REUSABLE. CIRCUITS FOR CONTROLS AND LIGHTING TO BE REUSED.
- 4. CITY TO FURNISH AND INSTALL NEW ADDRESSABLE MULTIZONE EXPANDABLE NON-PROPRIETARY FIRE ALARM PANEL. UNIT TO BE FIRE LITE, HONEYWELL, GAMEWELL, FIKE, SILENT KNIGHT OR OTHER EQUAL APPROVED BY TAMPA FIRE DEPT. NEW PANEL TO BE FURNISHED WITH BATTERY BACK UP SYSTEM. CONTRACTOR TO OBTAIN PANEL FROM CITY (SEE SHEET E-1) AND INSTALL. PANEL TO INCLUDE DIGITAL COMMUNICATOR.
- 5. FURNISH AND INSTALL NEW VOICE EVAC PANEL SYSTEM AND CONNECT VIA NEW FIRE ALARM PANEL IN NOTE 4 ABOVE.
- 6. EXISTING FIRE SPRINKLER PUMP SYSTEM AND CONTROLLER. CONNECT TO FIRE ALARM SYSTEM TO REPORT INITIATION. TIE TO FIRE PROTECTION SYSTEM STANDPIPE FLOW AND TAMPER DEVICES. FURNISH AS REQUIRED.
- FURNISH AND INSTALL NEW KNOX BOX (TYPICAL) FOR FIRE DEPT KEY ACCESS.
- 8. NEW FIRE ALARM PANEL REMOTE ANNUNCIATOR (FARA). WIRE BACK TO FIRE ALARM PANEL AND CONNECT.
- 9. FURNISH AND INSTALL NEW EXPANDER/POWER SUPPLY PANEL AS REQUIRED (TYPICAL)FOR THE DISTANCES EXCEEDING % ALLOWABLE VOLTAGE DROP FOR UPPER LEVELS.


 VENDOR/CONTRACTOR TO CALCULATE FEET OF DISTANCE AND INSTALL AS REQUIRED (TYPICAL THE STRUCTURE-LEVELS 1 THRU 10).
- 10. FURNISH AND INSTALL NEW FIRE ALARM CONNECTION CABINET AS REQUIRED FOR DEVICES ON FLOORS.
- 11. FURNISH AND INSTALL NEW ADDRESSABLE SMOKE DETECTOR COMPATIBLE WITH NEW PANEL AND CONNECT USING APPROVED METHODS AND MATERIALS (TYPICAL THE STRUCTURE-LEVELS 1 THRU 10).
- 12. FURNISH AND INSTALL NEW SPEAKER/STROBE, 110 CANDELA AND CONNECT VIA NEW FIRE ALARM AND EVAC PANEL (TYPICAL THE STRUCTURE—LEVELS 1 THRU 10).
- 13. NEW MANUAL PULL STATION (TYPICAL)
- 14. FIRE ALARM DIALER FOR NOTIFICATION DURING AN EVENT TO BE LOCATED IN OCCUPIED SPACE AS DIRECTED. CONTRACTOR TO ARRANGE FOR LOCAL OUTSIDE PHONE CARRIER DEDICATED LINE AS APPROVED BY FIRE DEPT, AND CONNECT AS REQUIRED. CONTRACTOR TO CONNECT TO FIRE ALARM PANEL.

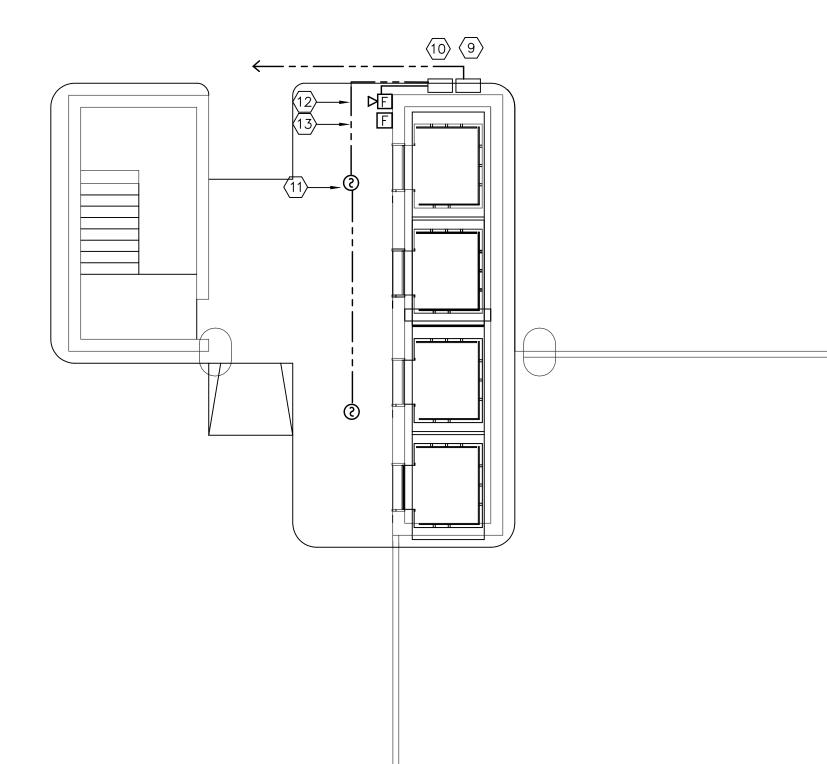






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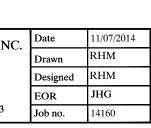
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Sheet Title: F/A PLAN Scale:

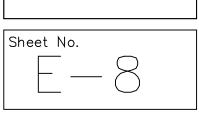Sheet No.

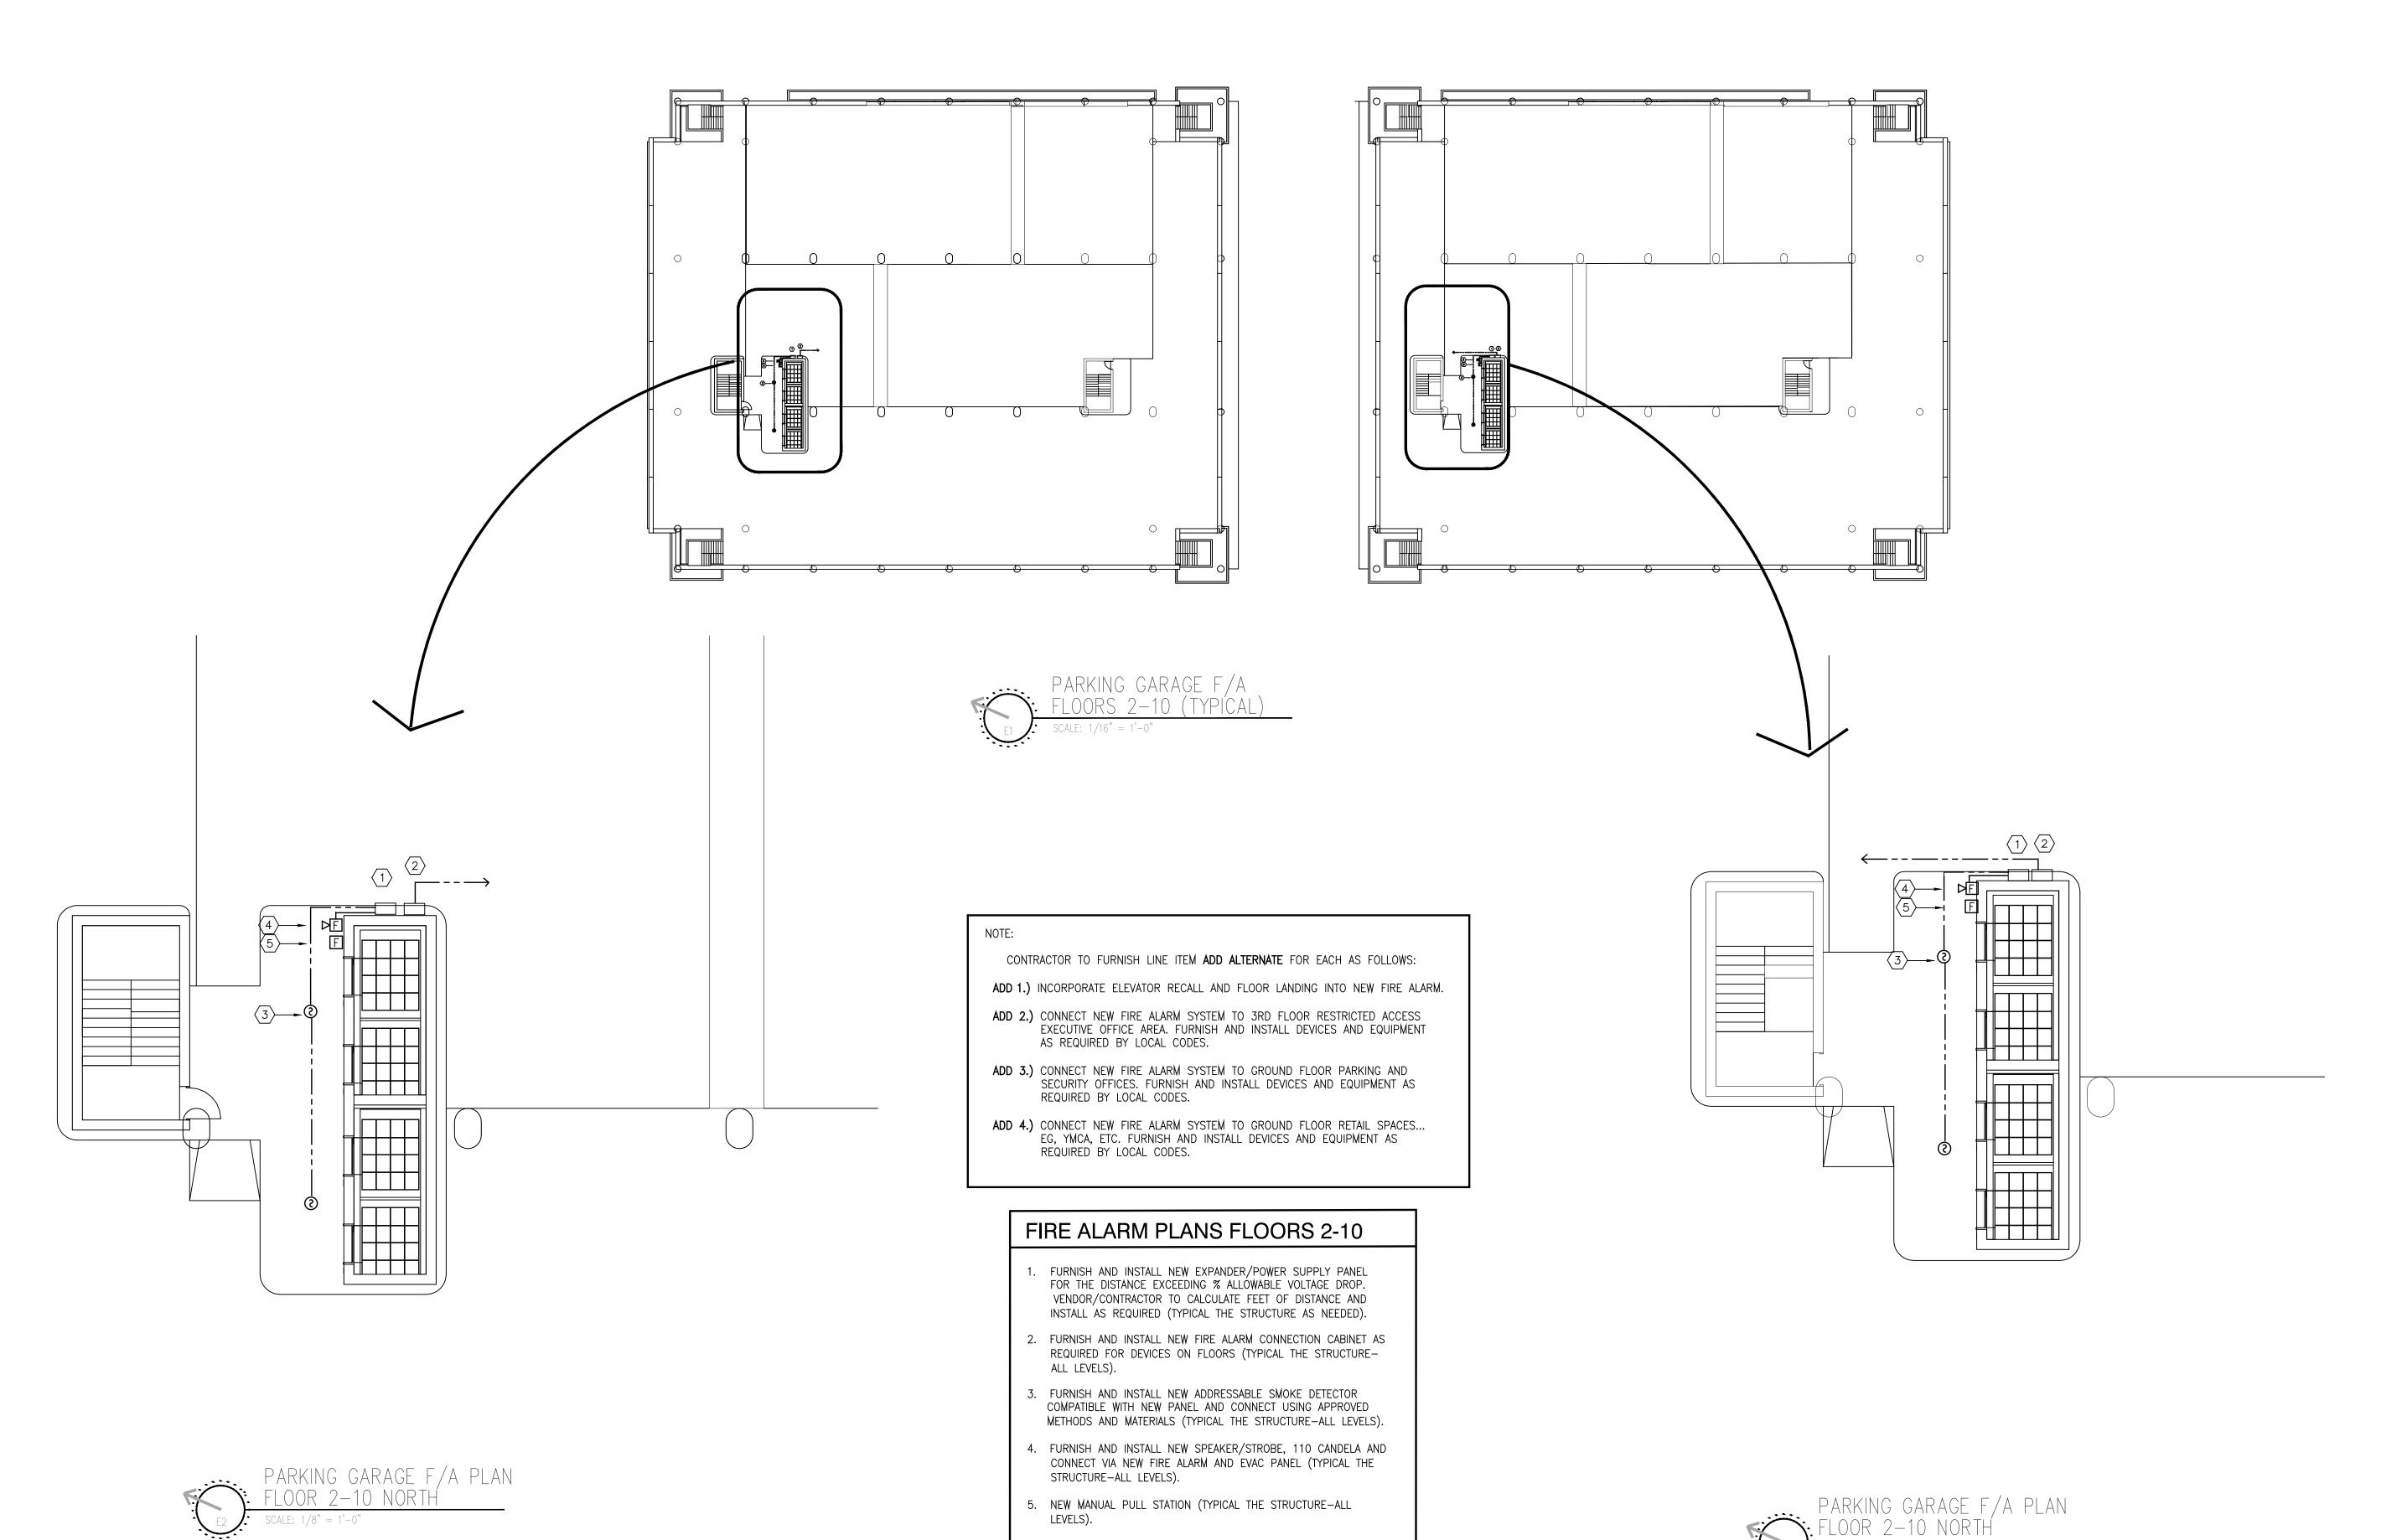FLOORS 2-10 Comm. No. 14-030 AS NOTED 10-31-14 Drawn: WR Checked: WR Revised:







FIRE ALARM GENERAL NOTES:

THE CONTRACTOR SHALL SUBMIT DRAWINGS OF THE PROPOSED RENOVATION OF THE EXISTING PARKING GARAGE AND ADDITION OF FIRE ALARM SYSTEM, INCLUDING ALL DEVICES AND WIRING LAYOUTS, BATTERY CALCULATIONS AND FREQUENCY OF OPERATION TO THE FIRE MARSHAL FOR APPROVAL PRIOR TO SUBMITTING TO ENGINEER AS SHOP DRAWINGS FOR REVIEW. ANY REVISIONS AND/OR ADDITIONS REQUIRED BY THE LOCAL JURISDICTION PRIOR TO OBTÁINING CERTIFICATION OF THE SYSTEM ARE THE RESPONSIBILITY OF THE CONTRACTOR AND WILL NOT BE REASON FOR ADDITIONAL COMPENSATION TO THE CONTRACTOR.

FIRE ALARM SYSTEM SEQUENCE MATRIX

| A | B | C | D | E | F | G | H | I | J | K | L

| A | B | C | D | E | F | G | H | I | J | K | L

 $X \mid X \mid X$

 $X \mid X \mid X$

 $X \mid X \mid$

FIRE SAFETY CONTROL

(IF PROVIDED FOR-OFFICES)

- ELEVATOR RECALL

UNLOCK ACCESS CONTROLLED LOCK

SHUT DOWN AIR HANDLER

NOTIFICATION

TRANSMIT TROUBLE SIGNAL TO MONITORING STATION

TRANSMIT ALARM SIGNAL TO MONITORING STATION

ACTUATE OCCUPANT NOTIFICATION-

COMMON TROUBLE ANNUNCIATION

SUPERVISORY ZONE ANNUNCIATION—

SYSTEM INPUTS

MANUAL PULL STATIONS

NOT USED

4 NOT USED

5 NOT USED

6 NOT USED NOT USED

8 | NOT USED

9 NOT USED

GENERAL NOTES:

10 | SYSTEM TROUBLE

•ALL FIRE ALARM SYSTEM DEVICES TO BE ADDRESSABLE.

SMOKE/HEAT DETECTORS

SYSTEM ANNUNCIATION

ALARM ZONE ANNUNCIATION

TRANSMIT SUPERVISORY SIGNAL TO MONITORING STATION

- 2. THE FIRE ALARM SYSTEM SHALL BE INSTALL IN COMPLIANCE WITH NFPA 70, 72, FLORIDA BUILDING CODE, AND LOCAL ORDINANCE.
- 3. SYSTEM SUPPLIER SHALL SUPERVISE INSTALLATION, PROGRAM AND TEST SYSTEM, AND INSTRUCT OWNER.
- 4. ALL CONNECTION CABINETS/EXPANDER PANELS SHALL BE GROUNDED PER NEC AND MANUFACTURER SPECIFICATION.
- 5. SYSTEM INSPECTION, TEST RESULT, AND OPERATION SHEETS SHALL BE PROVIDED TO THE OWNER.
- 6. REFER TO FIRE DRAWINGS E-8 AND E-9 FOR ADDITIONAL REQUIREMENTS.
- 7. THE ELECTRICAL CONTRACTOR SHALL PROVIDE AS-BUILT DRAWINGS SHOWING EXACT FIELD INSTALLATION TO THE OWNER AFTER COMPLETION OF THE
- 8. ALL FIELD CHANGES SHALL BE COORDINATED WITH OWNER'S REPRESENTATIVE.
- 9. FIRE ALARM SYSTEM SHALL BE ENERGIZED UNDER THE SUPERVISION OF THE
- 10. VERIFY LOCATION OF THE FIRE ALARM CONTROL PANEL AND REMOTE ANNUNCIATOR WITH THE LOCAL AUTHORITY HAVING JURISDICTION. SEE SHEET E-8
- 11. ALL CONTROL AND ALARM CABLES SHALL BE INSTALLED IN CONDUIT.
- 12. CONTRACTOR SHALL VERIFY THAT THE QUANTITY AND LOCATIONS SHOWN ON THE DRAWINGS SHALL PROVIDE A COMPLETE AND FUNCTIONAL SYSTEM TO
- 13. INSTALLATION OF WIRING, RACEWAY, AND DEVICES SHALL BE IN ACCORDANCE WITH UNIFORM RULE 69A, RULES AND REGULATIONS OF THE STATE FIRE MARSHAL'S OFFICE; ALL APPLICABLE COUNTY CODES, AND F.S. 633-701. RACEWAY SHALL BE MINIMUM 3/4" CONDUIT UNLESS OTHERWISE
- 14. WALL-MOUNTED AUDIBLE, VISUAL, AND AUDIBLE-VISUAL APPLIANCES SHALL HAVE THE BOTTOM OF THE FACE PLATE AT 80" AFF, OR 6" FROM THE TOP OF FACE PLATE TO CEILING, WHICHEVER IS LOWER.
- 15. DO NOT MOUNT SMOKE AND/OR HEAT DETECTORS CLOSER THAT 3'-0" TO ANY SUPPLY REGISTER OF THE A/C SYSTEM.
- 16. WHEN CEILING MOUNTED, SMOKE AND/OR HEAT DETECTORS SHALL BE MOUNTED NO CLOSER THAT 4" TO A SIDE WALL.
- 17. ALL DEVICES SUCH AS FIRE ALARM PULLS, STROBES AND HORNS, AND ETC ARE TO BE RED IN COLOR.

- 18. SLC AND NAC CIRCUITS SHALL BE DESIGNED SUCH THAT SPARE CAPACITY IS PROVIDED. NO CIRCUIT SHOULD BE LOADED TO MORE THAN 75% OF ITS CAPACITY. NAC CIRCUIT VOLTAGE DROP AS INSTALLED SHALL NOT EXCEED 75% OF THE MAXIMUM ALLOWED BY THE MANUFACTURER AT THE LAST APPLIANCE ON EACH CIRCUIT.
- 19. CONTRACTOR SHALL INCLUDE MINIMUM (4) HOURS IN HIS BID PROPOSAL FOR OWNER'S TRAINING. THE TRAINING TO BE PERFORMED AFTER COMPLETION OF FIRE ALARM SYSTEM.

GRINER ENGINEERING, INC. 1628 First Avenue North St. Petersburg, Florida 33713 Phone: (727)-822-2335 Fax: (727)-821-3361 Certificate of Authorization #3173

Designed RHM EOR JHG

Drawn RHM

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Sheet Title: FIRE ALARM DETAILS

Comm. No. 14-030

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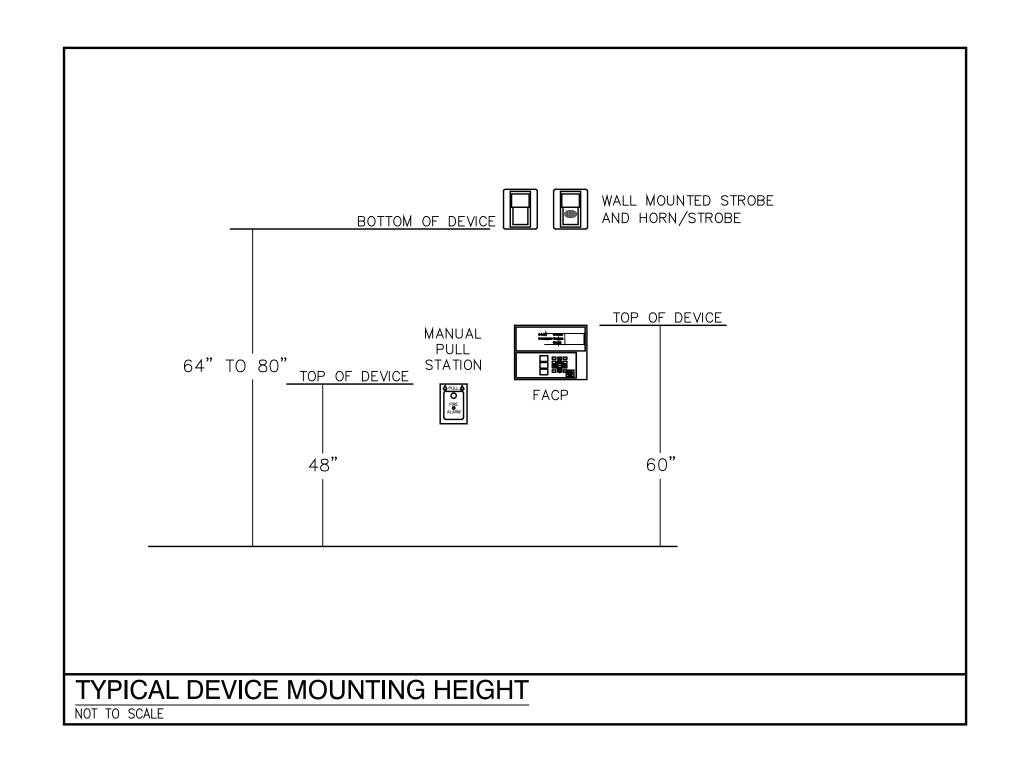
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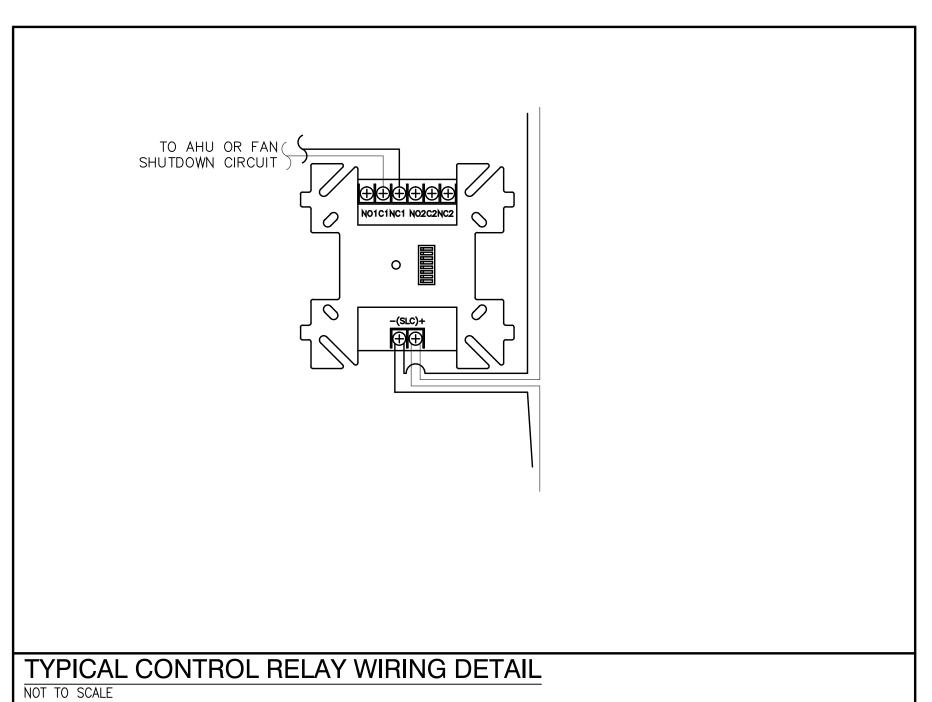
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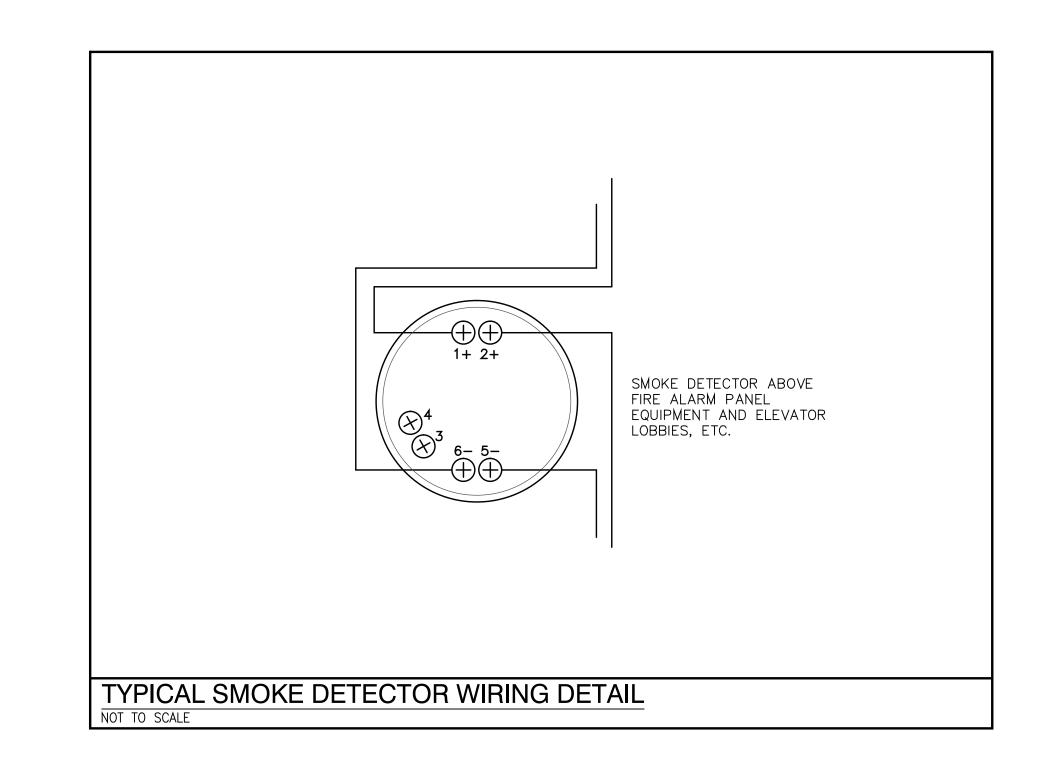
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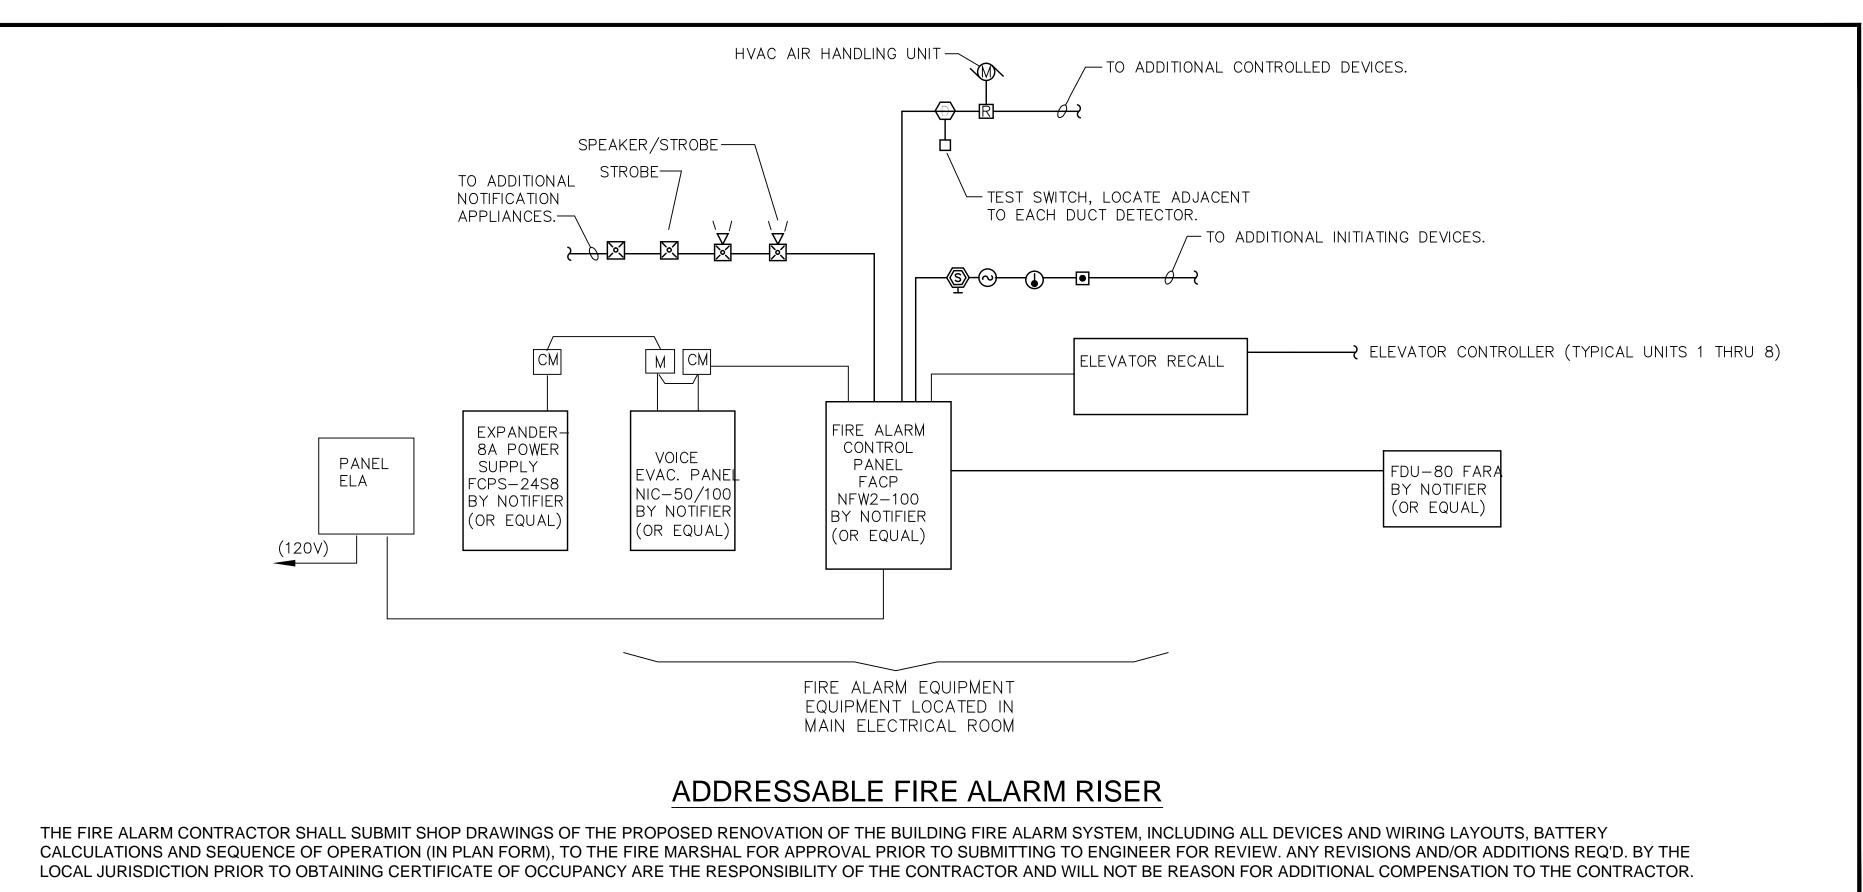
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FIRE ALARM CONDUCTOR SCHEDULE			
DESIG- NATION	CONDUCTOR	DEVICE TYPE	COLOR CODE
А	2 NO. 14 'THHN' — STRANDED	INITIATION DEVICES	TWISTED PAIR
С	2 NO. 12 'THHN' — STRANDED	AUDIO/VISUAL DEVICES	RED/BLACK
E	2 NO. 14 'THHN' — STRANDED	AUXILLIARY RELAYS	BLUE/ORANGE
F	2 NO. 14 'THHN' — STRANDED	SUPERVISORY DEVICES	PURPLE/BROWN









FORT BROOKE PARKING GARAGE
ELEVATOR IMPROVEMENTS
107 N Franklin St
Tampa, FL 33602

Sheet Title:

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FIRE ALARM

DETAILS

Comm. No. 14-030

AS NOTED

10-31-14

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